

ARCHITECTURAL ADDENDUM #03

Addendum Number Three (03)
PLANS AND SPECIFICATIONS FOR
Houston Community College – Culinary Arts Center
STANTEC Project No. 2140 00 169

Stantec 20 East Greenway Plaza Suite 200 Houston, Texas 77046

February 01, 2017

NOTE: If you have questions about this Addendum, please contact Geoffrey Wheeler.

This Addendum is generally seperated into sections for convenience; however, all contractors, subcontractors, material suppliers and other involved parties shall be responsible for reading the entire Addendum. Failure to list an item(s) in all affected sections of this Addendum does not relieve any party affected from performing per instructions, provided the information is set forth one time anywhere in the Addendum.

This document shall become attached to and part of the Construction Documents for the aforementioned project.

DRAWINGS

Sheet P001

1. Issued now, previously not issued with bid documents

Sheet P002

2. Issued now, previously not issued with bid documents

Sheet P010

3. Issued now, previously not issued with bid documents

NUMBER OF ATTACHMENTS: Drawings – 42" x 30" – 3 sheets

END OF ADDENDUM NUMBER THREE (03)

Project Name: HCC Culinary Arts Center Architectural Addendum No. Three (03) Date: February 01, 2017

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- PRIOR TO WORK CONTRACTOR SHALL TIGHTLY COORDINATE PLUMBING WORK WITH OTHER TRADES.
- PROVIDE A UNION DOWNSTREAM FROM EACH THREADED VALVE.
- PROVIDE A SEPARATE P-TRAP AT EACH PLUMBING FIXTURE, UNLESS TRAP IS BUILT INTO FIXTURE.
- REFER TO ARCHITECTURAL DRAWINGS FOR PLUMBING FIXTURE MOUNTING HEIGHTS.
- MAKE ROUGH-IN AND FINAL CONNECTION TO ALL PLUMBING FIXTURES.
- ALL NEW WORK SHALL CONFORM TO THE 2012 EDITION OF THE UNIFORM PLUMBING CODE WITH CITY OF HOUSTON AMENDMENTS UNLESS
- OTHERWISE NOTED OR SHOWN.
- PROVIDE A COMPLETE WORKING PLUMBING SYSTEM PER THE SPECIFICATIONS AND PLUMBING CODE.

DRAWINGS ARE DIAGRAMMATIC IN NATURE, NOT ALL REQUIRED PIPE ELBOWS, TEES, AND ASSOCIATED FITTINGS ARE SHOWN. CONTRACTOR SHALL

- PROVIDE A HYDRAULICALLY SIZED SPRINKLER SYSTEM IN ACCORDANCE WITH 2013 EDITION OF NFPA 13, TO PROVIDE SPRINKLERED FLOOR COVERAGE, FOR THE BUILDING AS INDICATED ON THE FLOOR PLANS.
- 11. PROVIDE A BALL VALVE W/ IN-LINE Y-STRAINER OR A FILTER TYPE BALL VALVE UPSTREAM OF ALL TRAP PRIMERS.

10. FIRE PROTECTION PIPING SHALL BE COORDINATED AROUND OTHER TRADES, SUCH AS PLUMBING, HVAC AND ELECTRICAL.

- 12. VERIFY LOCATION OF ALL FLOOR DRAINS WITH THE EQUIPMENT ROUGH-IN LOCATION.
- 13. REFER TO REFLECTED CEILING PLANS FOR FIRE SPRINKLER HEAD LAYOUT.
- 14. A SUPERVISORY SWITCH (TAMPER SWITCH) SHALL BE PROVIDED ON EACH VALVE USED FOR CONTROLLING THE FIRE PROTECTION SPRINKLER SYSTEM, AS SPECIFIED.
- 15. PROVIDE A BACKFLOW PREVENTER (AS INDICATED ON FLOOR PLANS) ON THE DOMESTIC WATER SUPPLY LINES TO KITCHEN EQUIPMENT.
- 16. THE SIZE OF THE STORM DRAINAGE SYSTEM IS BASED ON 8" RAINFALL RATE PER THE CITY OF HOUSTON AMENDMENTS TO THE 2012 UNIFORM PLUMBING CODE. STORM DRAINAGE IS SHOWN ON ARCHITECTURAL ROOF PLANS.
- 17. TRAP PRIMER PIPING SHALL NOT CONNECT DIRECTLY TO FLOOR DRAIN/ FLOOR SINK BODIES. CONNECT TRAP PRIMER PIPING TO FLOOR DRAIN P-TRAP EQUIPPED WITH TRAP PRIMER TAP.
- 18. COORDINATE NATURAL GAS SERVICE TO BUILDING WITH UTILITY COMPANY PRIOR TO WORK.
- 19. CONTRACTOR SHALL OBTAIN ARCHITECT/ENGINEER APPROVAL FOR ALL ACCESS PANEL LOCATIONS.
- PROVIDE SPRINKLER PROTECTION FOR ELEVATOR HOISTWAYS AS OUTLINED IN NFPA 13 AND THE BUILDING CODE. PROVIDE A SIDEWALL SPRINKLER HEAD NOT MORE THAN 2' ABOVE THE FLOOR OF THE PIT. A SPRINKLER HEAD LOCATED AT THE TOP OF THE HOISTWAY IS NOT REQUIRED.
- 21. PROVIDE AN ISOLATION VALVE FOR EACH SINGLE PLUMBING FIXTURE, OR WHERE FIXTURES ARE GROUPED ONE VALVE PER GROUP, REFER TO FLOOR PLANS.
- EACH FLOOR DRAIN AND FLOOR SINK SHALL HAVE THE P-TRAP SEAL PROTECTED BY A TRAP PRIMER LINE. IF A TRAP PRIMER LINE IS NOT SHOWN ON THE DRAWING THE FLOOR DRAIN OR FLOOR SIN SHALL BE PROTECTED BY A TRAP GUARD.
- 23. PROVIDE PRESSURE & TEMPERATURE PORTS IN UPSTREAM AND DOWNSTREAM PIPING CONNECTING TO PUMPS, WATER HEATERS AND
- 24. PROVIDE PRESSURE & TEMPERATURE PORTS WITHIN 3 PIPE DIAMETERS OF EACH PRESSURE OR TEMPERATURE SENSOR FOR USE IN CALIBRATION AND VERIFICATION.
- 25. PROVIDE & INSTALL SUPPLY STOPS ON ALL WATER CONNECTIONS TO EQUIPMENT.
- PROVIDE INLINE DUAL CHECK WITH ATMOSPHERIC VENT ON DCW SUPPLY LINES TO BEVERAGE EQUIPMENT, COFFEE MAKERS & TEA BREWERS. PROVIDE INLINE DUAL CHECK VALVE ON DCW SUPPLY LINES TO ICE MAKERS.
- WHERE FOOD SINKS ARE PROVIDED FOR FOOD SERVICE EQUIPMENT PROVIDE & INSTALL FULL SIZE TYPE "L" COPPER DRAIN LINE FROM EQUIPMENT TO FLOOR SINK (INDIRECT WASTE).
- 28. REFER TO FOOD SERVICE DWGS. FOR EXACT CONNECTION LOCATION OF PLUMBING UTILITIES TO EQUIPMENT.
- 29. VALVES ON DCW & DHW SUPPLY LINES TO MOP SINK FAUCETS & PRE RINSE FAUCETS UNLESS INTEGRAL CHECK VALVES ARE BUILT INTO FAUCET.
- 30. PROVIDE DRY TYPE SPRINKLER HEAD TO PROTECT FREEZERS.

COMPRESSORS.

<u>SERVICE</u>	<u>PIPE</u>	<u>FITTING</u>
EQUIPMENT DRAINS AND OVERFLOWS	TYPE "L" HARD DRAWN COPPER (ASTM B88)	SOLDERED (95-5) WROUGHT COPPER, ANSI B16.22.
SANITARY DRAINAGE, GREASE WASTE AND VENT ABOVE GRADE AND BELOW SLAB ON GRADE	SERVICE WEIGHT CAST IRON, CISPI 301	SERVICE WEIGHT DWV NO-HUB FITTINGS. HEAVY WEIGHT NO- HUB, 4-BAND COUPLINGS FOR SIZES 4" & LESS AND 6-BAND COUPLINGS FOR PIPES SIZES OVER 4". CONFORMING TO CISPI 310 MANUF. BY ANACO "HUSKEY",2000, MIFAB MI-XHUB OR CLAMP-ALL 125. NO-HUB CISPI 310 COUPLINGS. ALL COUPLINGS WITH STAINLESS STEEL BANDS AND NEOPRENE GASKETS
SANITARY DRAINAGE SITE PIPING BEGINNING S' FROM THE BUILDING	SIZES 6" AND SMALLER: SCHEDULE 40 PVC	TYPE 1 GRADE 1 PVC SOCKET SOLVENT CEMENT JOINTS.
STORM AND OVERFLOW DRAINAGE ABOVE GRADE	SERVICE WEIGHT CAST IRON, CISPI 301	FOR SIZES THROUGH 8": SERVICE WEIGHT DWV NO-HUB FITTINGS WITH HEAVYWEIGHT 4-BAND COUPLINGS FOR PIPE SIZES 4" AND LESS AND 6-BAND COUPLINGS FOR PIPE SIZES OVER 4" CONFORMING TO CISPI 310, MANUF. BY ANACO "HUSKEY" 2000, MIFAB MI-XHUB OR CLAMP-ALL 125. FOR SIZES OVER 8": SERVICE WEIGHT BELL & SPIGOT DWV FITTINGS WITH NEOPRENE GASKETS, ASTM C564.
STORM AND OVERFLOW DRAINAGE BELOW GRADE	SERVICE WEIGHT CAST IRON, CISPI 301	SERVICE WEIGHT BELL & SPIGOT DWV FITTINGS WITH NEOPRENE GASKETS, ASTM C564.
DOMESTIC WATER MAKEUP WATER ABOVE GRADE	TYPE "L" HARD DRAWN COPPER (ASTM B88)	ANSI B16.22 WROUGHT COPPER WITH 95-5 SOLDER LEAD-FREE JOINTS, ASTM B32.
DOMESTIC WATER BELOW GRADE DUTSIDE BUILDING	TYPE "K" HARD DRAWN COPPER (ASTM B88)	ANSI B16.22 WROUGHT COPPER WITH SIL-FOS LEAD- FREE JOINTS, ASTM B32
NATURAL GAS ABOVE GRADE	SCHEDULE 40 BLACK STEEL (ASTM A53)	FOR PIPE SIZES UP TO 2 INCH - CLASS 150 THREADED MALLEABLE IRON FITTINGS FOR EXPOSED AREAS. CARBON STEEL SOCKET WELDED FITTINGS ABOVE CEILING AND CONCEALED AREAS. FOR PIPE SIZES OVER 2 INCH - CARBON STEEL LONG RADIUS BUTT WELDED FITTINGS
NATURAL GAS BELOW GRADE	POLYETHYLENE TYPE 2 GRADE 3 WITH SDR11 WALL THICKNESS (ASTM D1248)	TYPE 2 GRADE 3 POLYETHYLENE SOCKET HEAT FUSED FITTINGS FOR SIZES UP TO 2". BUTT FUSED FITTINGS FOR PIPE SIZES OVER 2 INCH.

	PL					
1. SANITARY SEWER WATER CLOSETS	10 X 6 DFU	= 60 DFU	2. STORM DRAIN: ALL STORM DRAIN PIPING SI ON UNIFORM PLUMBING COI IN THE CITY OF HOUSTON A	DE TABLES FO	4. GREASE INTERCEPTOR: FLOOR SINKS: 17 X 6 = 102 DFU PER TABLE 10-3 FROM THE 2012 UNIFORM	
URINALS LAVATORIES	2 X 5 DFU 8 X 1 DFU	= 10 DFU = 8 DFU	A RATE OF 8 INCHES PER HO ARCHITECTURAL PLANS FOR TOTAL CALCULATED FLOW =	OUR. SEE R ROOF DRAIN		PLUMBING CODE, 102 DFU WILL REQUIRE A MINIMUM GREASE INTERCEPTOR VOLUME OF 1,500 GALLONS.
MOP SINKS SINKS	2 X 3 DFU 25 X 2 DFU	= 6 DFU = 50 DFU	3. DOMESTIC WATER WATER CLOSETS	10 UNITS	= 165 FU	
DRINKING FOUNTAINS	4 X 1 DFU	= 4 DFU	URINALS	2 UNITS	= 35 FU	
FOOD WASTE SINK DISHWASHER	8 X 3 DFU 3 X 2 DFU	= 24 DFU = 6 DFU	LAVATORIES MOP SINKS	8 X 1 FU 2 X 3 FU	= 8 FU = 6 FU	
4" FLOOR SINKS TOTAL	34 X 6 DFU	= 204 DFU = 372 DFU	SINKS HOSE BIBBS	60 X 2 FU 2.5 + 6	= 120 FU = 8.5 FU	
			DRINKING FOUNTAINS KITCHEN EQUIPMENT	4 X .5 FU 15 X 2 FU	= 2 FU = 30 FU	
TABLES 703.2, 372 DFU V PIPE SLOPED AT 1/8" PEI DRAINS IN THE CENTER TRENCH DRAINS IN THE	PER 2012 EDITION OF UNIFORM PLUMBING CODE TABLES 703.2, 372 DFU WILL BE SERVED BY A 6" PIPE SLOPED AT 1/8" PER FOOT. NOTE: ALL FLOOR DRAINS IN THE CENTER OF THE LABS AND THE TRENCH DRAINS IN THE RESTROOMS ARE EMERGENCY FIXTURES AND HAVE A DFU VALUE OF 0.				= 6 FU 380.5 WFU 125 GPM CODE TABLES	
			CHARTS A2.1 AND A2.1(I), 380 GPM. FIXTURE COUNT INCLU UNITS FOR SHELL SPACE BU FIGURE A4.1(2) FOR TYPE "L" SIZE, A 4" PIPE IS ADEQUATE SECOND VELOCITY.	JDES ESTIMATI JILDOUT. ' COPPER TUBI	ED FIXTURE ING FOR PIPE	



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CULINARY ARTS CENTER HOUSTON, TEXAS

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ISSUE: 11/18/2016 11/18/2016 ISSUED FOR BIDDING

SHEET TITLE: PLUMBING LEGEND, **GENERAL NOTES AND SPECIFICATIONS**

					PLUI	MBING ROUGH IN SCHEDULE
FIXTURE	SOIL	WASTE	VENT	HOT WATER	COLD WATER	DESCRIPTION
<u>WC-1</u>	4	-	2	-	1	WALL HUNG WATER CLOSET - (ZURN ECO VANTAGE NO Z5615 AQUAMETER) WITH 1.28 GPF HANDS FREE SENSOR ACTIVATED FLUSH VALVE (ZURN MODEL ZER6000PL-HET-CPM)
<u>WC-2</u>	4	-	2	-	1	ADA WALL HUNG WATER CLOSET - (ZURN ECO VANTAGE NO Z5615 AQUAMETER) WITH 1.28 GPF HANDS FREE SENSOR ACTIVATED FLUSH VALVE (ZURN MODEL ZER6000PL-HET-CPM)
<u>U-1</u>	2	-	2	-	3/4	WALL HUNG URINAL - (ZURN ECOVANTAGE NO. Z5798) WITH .125 GPF ELECTRONIC FLUSH VALVE (ZURN ZEMS6003AV-ULF-IS)
<u>U-2</u>	2	-	2	-	3/4	ADA WALL HUNG URINAL - (ZURN ECOVANTAGE NO. Z5798) WITH .125 GPF ELECTRONIC FLUSH VALVE (ZURN ZEMS6003AV-ULF-IS)
<u>L-1</u>	-	2	1 1/2	1/2	1/2	ADA COUNTER MOUNTED LAVATORY - (ZURN NO. Z5220) WITH 0.5 GPM SPRAY OUTLET - (ZURN NO. 76915-TMV-1-F)
<u>SK-1</u>	-	2	2	3/4	3/4	WALL MOUNTED HANDSINK
<u>SK-2</u>	-	2	2	1/2	1/2	ADA COUNTER MOUNTED SINGLE COMPARTMENT SINK - (ELKAY"LRAD-2521") WITH 1.5 GPM GOOSENECK SPOUT - (CHICAGO NO. 786-GN8FC)
MS-1	-	3	2	1/2	1/2	FLOOR MOUNTED MOP SINK - (STERN WILLIAMS SBC-1525) WITH WALL- MOUNTED SERVICE SINK FAUCET - (CHICAGO MODEL 445-897SRCXKCP)
EDF-1	-	2	2	-	1/2	ELECTRIC DRINKING FOUNTAIN - (ELKAY No. EZSTL8WSLK)
TMV	-	-	-	-	-	THERMOSTATIC MIXING VALVE FOR LAVATORIES (ASSE 1070 COMPLIANT)
<u>RB-1</u>	-	2	2	-	1/2"	ROUGH-IN BOX (GUY GRAY NO. BIM875) WITH 5-MICRON CARTRIDGE TYPE FILTER HOUSING.
<u>HB-1</u>	-	-	-	-	3/4"	INTERIOR HOSE BIBB.
<u>HB-2</u>	-	-	-	-	3/4"	FREEZE PROOF WALL HYDRANT ON EXTERIOR OF BUILDING.
<u>FD-1</u>	-	4	2	-	-	FLOOR DRAIN IN FINISHED AREA.
<u>FD-2</u>	-	4	2	-	-	FLOOR DRAIN IN MECHANICAL ROOM.
<u>FS-1</u>	-	4	2	-	-	12" X 12" FLOOR SINK WITH 1/2 GRATE.
<u>FS-2</u>	-	4	2	-	-	12" X 12" FLOOR SINK WITH 3/4 GRATE.
<u>FS-3</u>	-	4	2	-	-	12" X 12" FLOOR SINK WITH FULL GRATE.
<u>TD-1</u>	-	4	2	-	-	TRENCH DRAIN.

	WATER SOFTENER SCHEDULE									
MARK	TYPE	MAXIMUM GRAIN PER DAY REMOVAL	RESIN CAPACITY (CUBIT FEET)	PEAK. FLOW (GPM @ 25PSI)	INCOMING HARDNESS	DISCHARGE HARDNESS		BACKWASH (GPM)	BRINE CAPACITY (LBS.)	REMARKS
WS-1	TWIN ALTERNATING	90,000	3.0	30	10 GRAINS	0 GRAINS	75 PSI	5	400	WATERTECH SERVICES WTS F-90-2T

	GAS FIRED WATER HEATER SCHEDULE											
MARK		RECOVERY RATE @ 100 DEGREE F (GALLONS/HR)		, ,	HEIGHT	ENSIONS LENGTH			RICAL DA		INTAKE & EXHAUST SIZE	REMARKS
WH-1,2	500	360	140	300	6'-2"	8'-5"	3'-10"	208	1	60	4"	HAMILTON EVO (2) HW 299

	PUMP SCHEDULE									
NA DIC	050)//05	TDH	FLOWRATE		E	ELECTRICA	L DATA			
MARK	SERVICE	SERVICE (FEET) (GPM)		HP EACH	RPM	VOLT	PHASE	HERTZ	REMARKS	
FP-1	FIRE PUMP	140	550	40	1770	460	3	60	AURORA. NO. 4-481-15	
JP-1	JOCKEY PUMP	154	5	1	3450	460	3	60	AURORA MODEL 391	
DWP-1	DOMESTIC WATER	155	65 EA. (2)	5 (2)	3450	460	3	60	GRUNDFOS NO. CRE 10-05 (2)	
SP-1	ELEVATOR SUMP	30	50	1/2	3450	115	1	60	HYDROMATIC NO. SHEF 50	
HWC-1	HOT WATER CIRC.	20	4.5	1/6	3450	115	1	60	GRUNDFOS NO UP26-96F	

	ELECTRIC INSTANTANEOUS WATER HEATER SCHEDULE								
MARK	TEMPERATURE RISE TEMP / FLOW RATE	KW VOLTS PHASE HERTZ			DIME	NSIONS (WIDTH	INCHES) DEPTH	REMARKS	
EIWH-1	70 DEGREES FAT 1.5 GPM	15	277	1	60	11	6	3	EEMAX MODEL EX160TC

NOTE: FACTORY PRE-SET DISCHARGE TEMPERATURE: 140 DEGREES F.

	EXPANSION TANK SCHEDULE								
MARK	VOLUME (GALLONS)	DIMENSION	NS (INCHES)	SYSTEM	DEMARKO				
	(01=0.110)	DIAMETER	HEIGHT	CONNECTION	REMARKS				
ET-1	30	16	45	DHW	AMTROL AX-60V				

HE	HEAT TRACING PANEL SCHEDULE								
	ELECTRICAL DATA								
MARK	MAXIMUM CIRCUIT LENGTH	VOLTS	PHASE	HERTZ	AMPS				
HTP-1	470'	277	1	60	40				
HTP-2	400'	277	1	60	40				

SHOO	CK ARR	ESTOR S	SCHEDULE
SYMBOL	FIXTURE UNIT	PIPE SIZE	ZURN SHOCK STOP NUMBER
A	1-11	1/2"	100
B	12-32	3/4"	200
C	33-60	1"	300
D	61-113	1"	400
E	114-154	1"	500
⟨F⟩	155-330	1"	600

NOTE:
WHERE SYMBOL OCCURS ON THE PLUMBING PLANS OR
PLUMBING DETAIL SHEETS, REFER TO ARRESTOR SCHEDULE ABOVE



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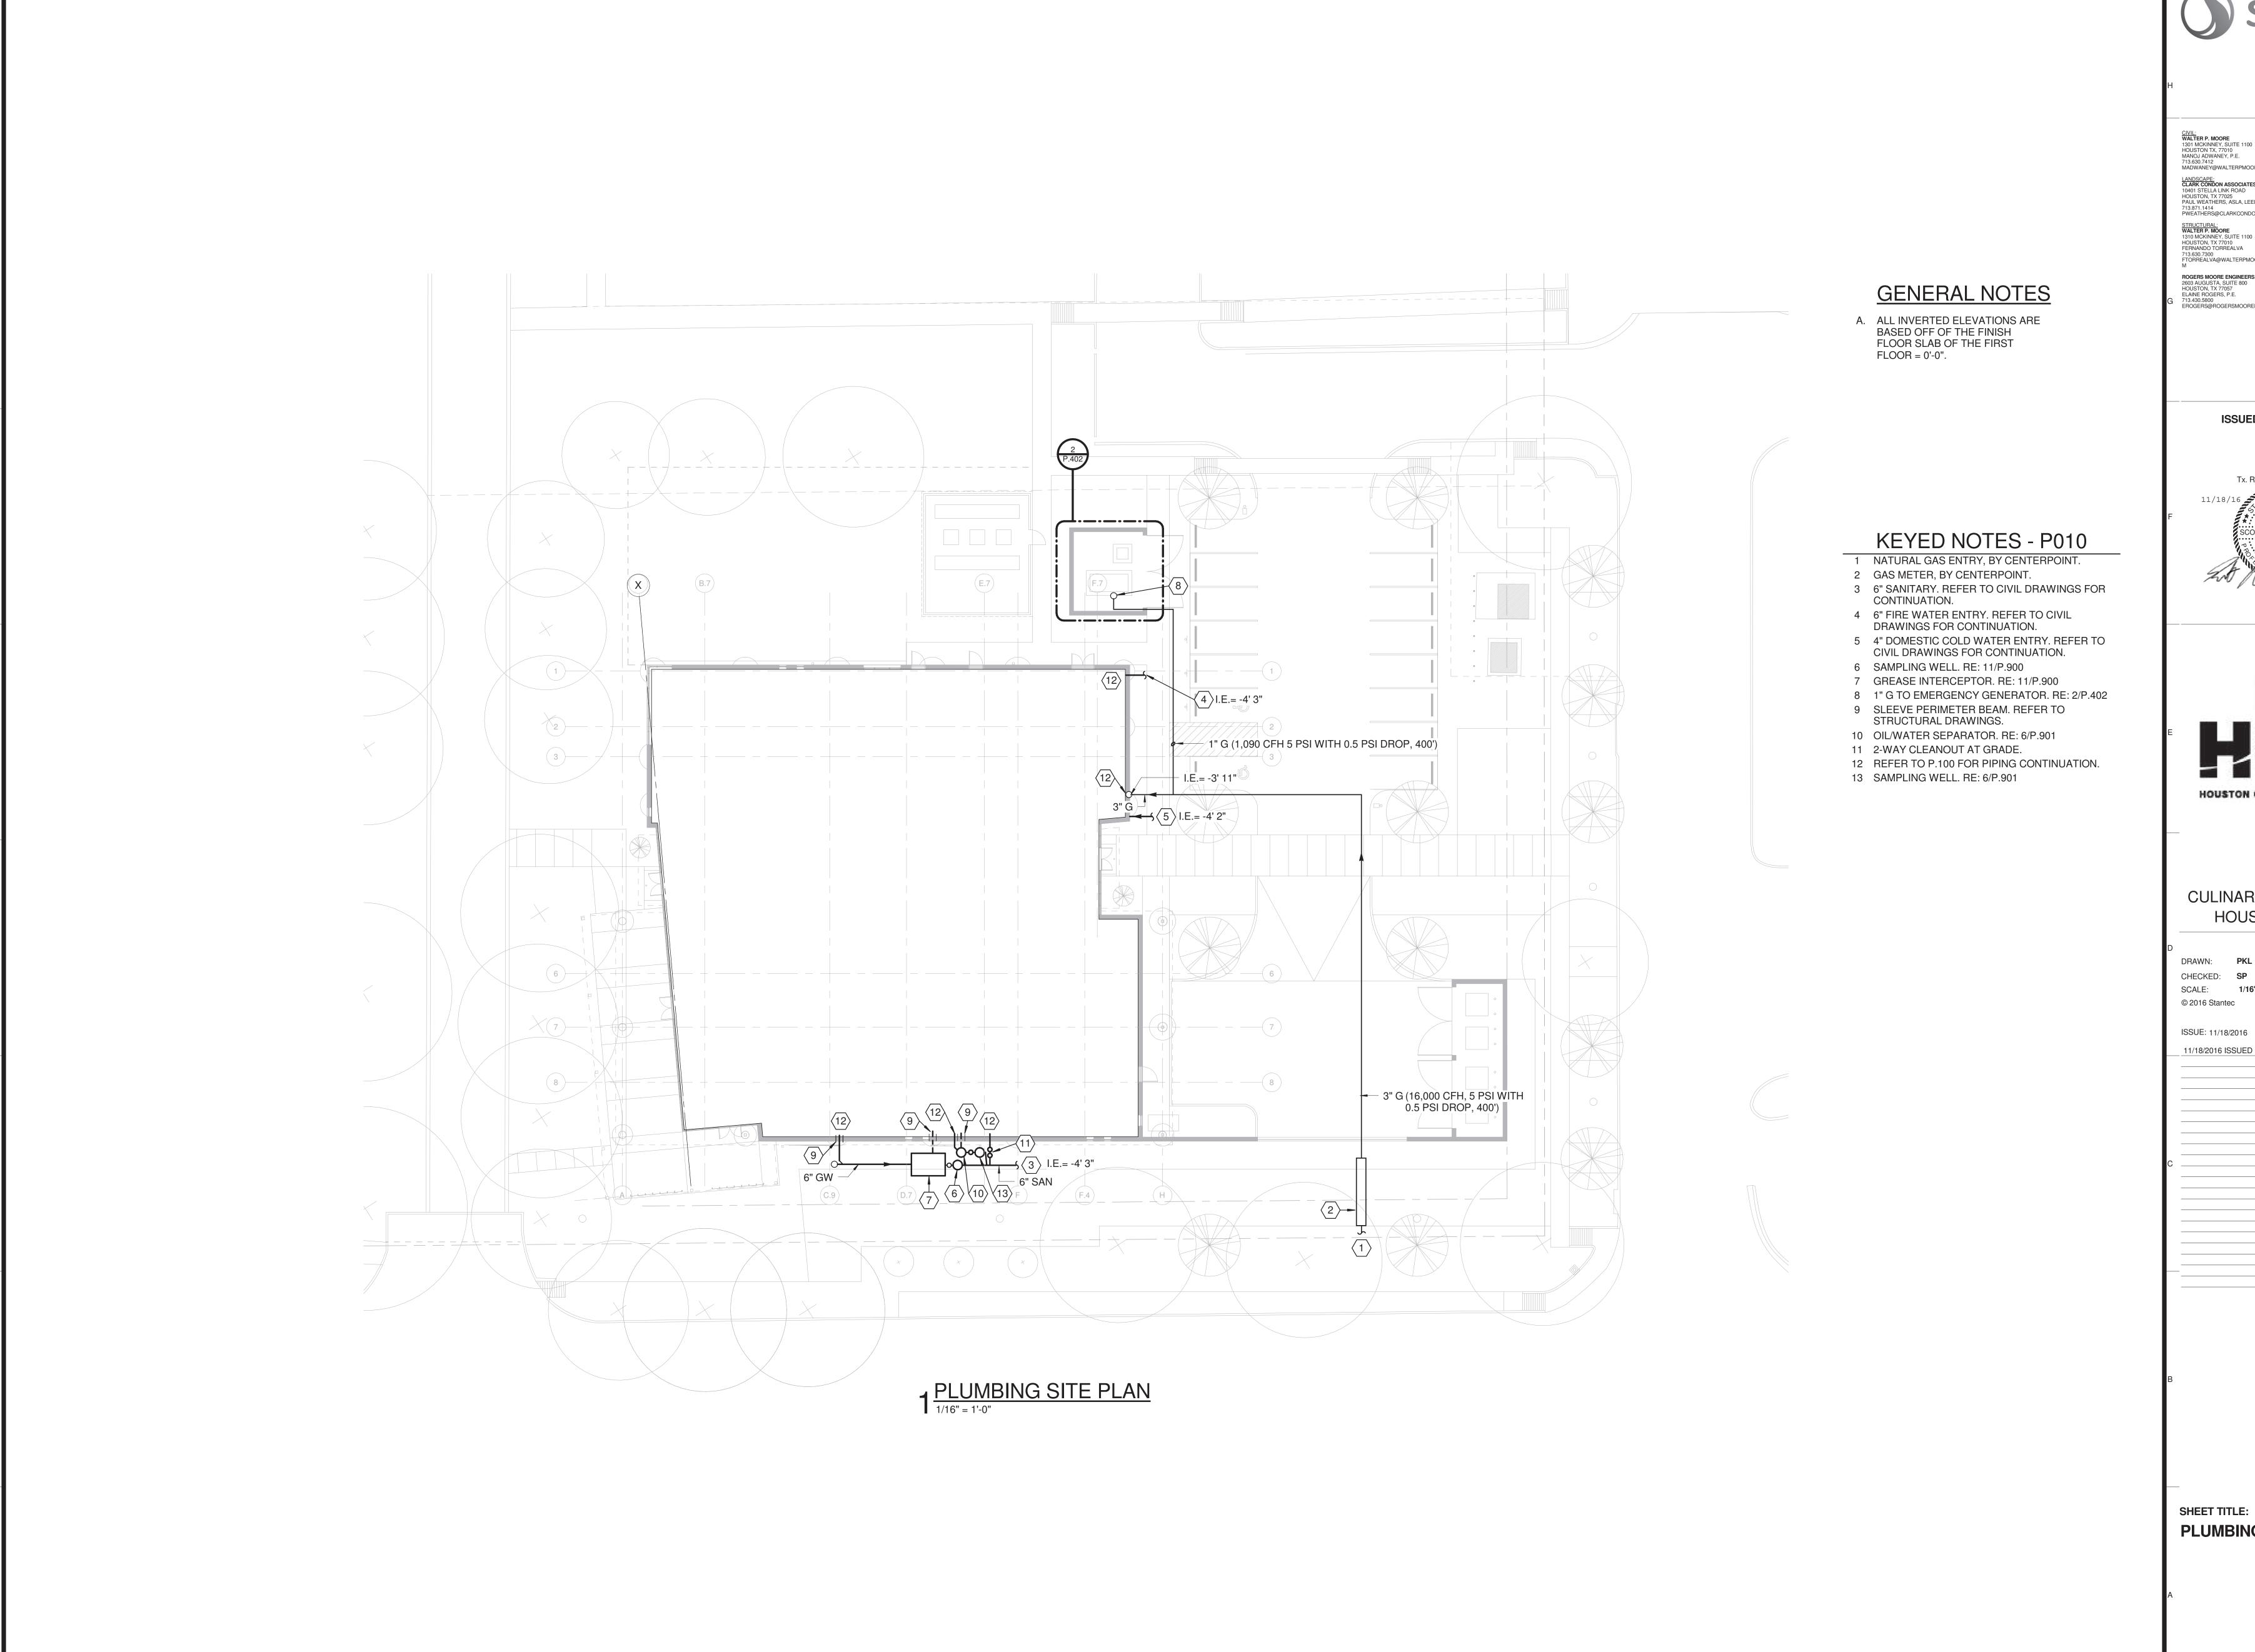


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ISSUE: 11/18/2016 11/18/2016 ISSUED FOR BIDDING

SHEET TITLE: PLUMBING SCHEDULES





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CULINARY ARTS CENTER HOUSTON, TEXAS

DRAWN: **PKL** CHECKED: SP SCALE: 1/16" = 1'-0"

11/18/2016 ISSUED FOR BIDDING

SHEET TITLE: **PLUMBING SITE PLAN**



ARCHITECTURAL ADDENDUM #04

Addendum Number Four (04)
PLANS AND SPECIFICATIONS FOR
Houston Community College – Culinary Arts Center
STANTEC Project No. 2140 00 169

Stantec 20 East Greenway Plaza Suite 200 Houston, Texas 77046

February 13, 2017

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GENERAL

1. See also responses to proposer RFI in the <u>QUESTIONS AND ANSWERS NO. 2</u> issued by HCC in conjunction with this addendum.

SPECIFICATIONS

04 20 00

 Section 2.1, A: Acme Brick of equivalent size, color and specification is an acceptable substitution for the Face Brick scheduled on Architectural drawings. Product must be source within 500 miles of the project site and qualify for LEED credits MR4 and MR5.

08 41 13

2. Arcadia's AG451 is an approved equal substitution for Aluminum-Framed Storefronts Manufacturers equivalent to the Basis-of Design.

08 87 23 - IMPACT RESISTANT GLAZING FILM

3. Specification Section is added in its entirety.

08 91 00

4. Section 2.3 COMPONENTS, Item A: Wall Louvers is revised as Drainable Style.

10 14 00

5. Section 1.4 QUALITY ASSURANCE, Installer Owner Design Standards has been revised to read:

Project Name: HCC Culinary Arts Center Do Architectural Addendum No. Four (04)

Date: February 13, 2017

Page 1 of 2



a. Obtain a copy of the 2011 Signage and Graphics Standards, and follow all Owner graphic design standards listed therein for materials, fonts, logos, and other design criteria.

11 24 29

6. Section 2.1: Peak Fall Protection is an approved equal substitution for fall protection anchor systems.

DRAWINGS

Sheet AS.001

1. List of alternates has been added to this sheet

Sheet AS.002

2. Added drawing titles for drawings relative to Alternate 1 (originally removed for Permitting)

Sheet A.131

3. Added louvered trellis on plan, alternate 1

Sheet A.601

4. Added notes clarifying Alternate 2

Sheet A.801

5. Revised brick selection and updated CMU selection info

Sheet A.831

6. Added sizes for student lockers

NUMBER OF ATTACHMENTS: Specifications – 8.5" x 11" – 3 pages

Drawings – 42" x 30" – 6 sheets

END OF ADDENDUM NUMBER FOUR (04)

Project Name: HCC Culinary Arts Center

Architectural Addendum No. Four (04)

Date: February 13, 2017

Page 2 of 2

February 13, 2017 Project No. 214000 169

SECTION 08 87 23 - IMPACT-RESISTANT GLAZING FILM

PART 1 - GENERAL

1.1 SUMMARY

- A. Section Includes installation of impact-resistant glazing film for certain exterior and interior glazing panels as indicated in the drawings.
- B. Related Sections:
 - 1. Section 08 80 00 Glazing.
 - 2. Section 08 41 13 Aluminum-Framed Entrances and Storefronts.
 - 3. Section 08 44 13 Glazed Aluminum Curtain Walls

1.2 REFERENCES

- A. American Society of Civil Engineers
 - ASCE-7 "Minimum Design Loads for Buildings and Other Structures": Section 6.0 "Wind Loads."
- B. General Services Administration
 - 1. GSA "Standard Testing Method for Windows and and Glazing systems Subject to Dynamic Overpressure Loadings".
- C. ASTM International:
 - ASTM F-1642-04 "Standard Test Method for Glazing and Glazing systems Subjected to Airblast Loadings."

1.3 PERFORMANCE REQUIREMENTS

- A. Glass Thickness: The Project glass pane thickness for glazing film application is 1/4" unless indicated otherwise. Exterior glazing panels are comprised of (2) 1/4" thick tempered panes separated by 1/2" gasketed seals for an overall insulated glazing unit thickness of 1".
- B. Provide impact-resistant glazing film for single-pane and dual-pane insulated glass units as required to meet or exceed the following criteria:
 - Wind Loads for Exterior Glazing:
 - a. As may be indicated, but not less than wind loads required by ASCE 7.
 - b. Probability of Breakage for Vertical Glazing: 8 lites per 1000 for lites set vertically or not more than 15 degrees off vertical and under wind action
 - Load Duration: 3 seconds.
 - c. Maximum Lateral Deflection: For exterior glass supported on all 4 edges, provide thickness required that limits center deflection at design wind pressure to 1/50 times the short side length or 1 inch, whichever is less.

1.4 SUBMITTALS

- A. Section 01 33 00 Submittal Procedures: Submittal procedures.
- B. Product Data:
 - Glazing Films: Provide structural, physical, and thermal and solar optical performance characteristics, size limitations, special handling or installation requirements.

2. Perimeter Sealants, Compounds and Accessories: Provide chemical, functional, and environmental characteristics, limitations, special application requirements. Identify available colors where exposed.

C.

- Glass Panels: Submit two samples 12x12 inch in size, for each type of glazing film required, and each type of glass to receive glazing film, including spandrel and wire glass.
- 2. Perimeter Sealant: Submit 12 inch long bead of proposed perimeter sealant.
- Film Manufacturer's Certificate: Certify specified glass products including sealed D. insulating units, spandrel glass, tinted glass, low-E coated glass, and any fire-rated glass are appropriate products to receive glazing film and will not negatively affect glazing panel performance.

QUALIFICATIONS 1.5

Α. Installer: Company specializing in performing Work of this section with minimum three years' experience.

1.6 PRE-INSTALLATION MEETING

- Section 01 30 00 Administrative Requirements: Pre-installation meeting. Α.
- B. Convene minimum one week before starting Work of this section.

ENVIRONMENTAL REQUIREMENTS 1.7

- Α. Section 01 60 00 - Product Requirements.
- B. Do not install glazing films or liquid glazing sealants when ambient and substrate temperature conditions are outside limits permitted by glazing sealant manufacturer or below 40 deg F.

1.8 WARRANTY

- Section 01 70 00 Execution and Closeout Requirements: Product warranties and Α. product bonds.
- B. Furnish ten-year warranty to include coverage for glazing films from delamination, color change, optical transparency change, failure to provide impact protection within limitations as specified herein.

PART 2 - PRODUCTS

2.1 SYSTEM MANUFACTURERS

- A. Madico SafetyShield, Inc., St. Petersburg, FL, 526-277-8775, www.safetyshield.com
- B. 3M Ultra S800 as equal substitution. www.3M.com/windowfilm
- C. Substitutions: Section 01 60 00 - Product Requirements.

2.2 **MATERIALS**

- Glazing Film: High strength Mylar polyester, optically clear and without waviness or A. other distortion. Colorless or tinted as selected.
 - Film: Minimum thickness 8 mils. 1.
 - 2. Color: Clear

February 13, 2017

Project No. 214000 169

- February 13, 2017 Project No. 214000 169
- Bonding Agent: Optically clear and colorless water-based water-thin aqueous mixture B. used for filling microscopic pores and valleys of the glass while providing enhanced bonding of film and adding measurable strength to the glass panel.
 - Type: Manufacturer's Recommendation
- C. Applied system shall be odor-free and non-toxic after 72-hour cure time.
 - Flame Spread: 0.
 - 2. Smoke Developed: 0.

PART 3 - EXECUTION

3.1 **EXAMINATION**

- Α. Section 01 30 00 - Administrative Requirements: Coordination and project conditions.
- Verify surfaces of glazing panels are clean, free of haze or visual distortion, dry, and B. ready to receive glazing.

3.2 **PREPARATION**

- A. Remove any glazing labels or protective tape or other markings on film application side of glazing panel. Replace any removed safety labels or tape on non-application side of glass.
- B. Clean contact surfaces with mild water-based solution, rinse thoroughly with clear potable water, and wipe dry.
- C. Ensure surfaces of glazing panels are clean, free of haze or visual distortion, dry, and ready to receive glazing film.


3.3 **INSTALLATION**

- A. Uniformly spray apply bonding agent to interior face of exterior glazing and to secure side of interior glazing.
- Apply film and use rubber-edged glazing squeegee to remove all excess liquid, air В. bubbles, wrinkles and other distortions.
- C. Trim film edges at intersection of glazing gasket/stop and glass panel, and squeegee edges along glazing gasket.
- Clean overspray of bonding agent and allow system to cure a minimum of 72 hours. D.
- E. Once system is fully cured, apply small bead of clear silicone sealant around perimeter of trimmed film at glazing gasket/stop.

3.4 **CLEANING**

- Α. Section 01 70 00 - Execution and Closeout Requirements: Final cleaning.
- B. Provide final cleaning and polishing of applied film.
- C. Do not remove any safety labels or tape from non-application side until removal is approved by General Contractor.
- D. Clean adjacent surfaces.

END OF SECTION

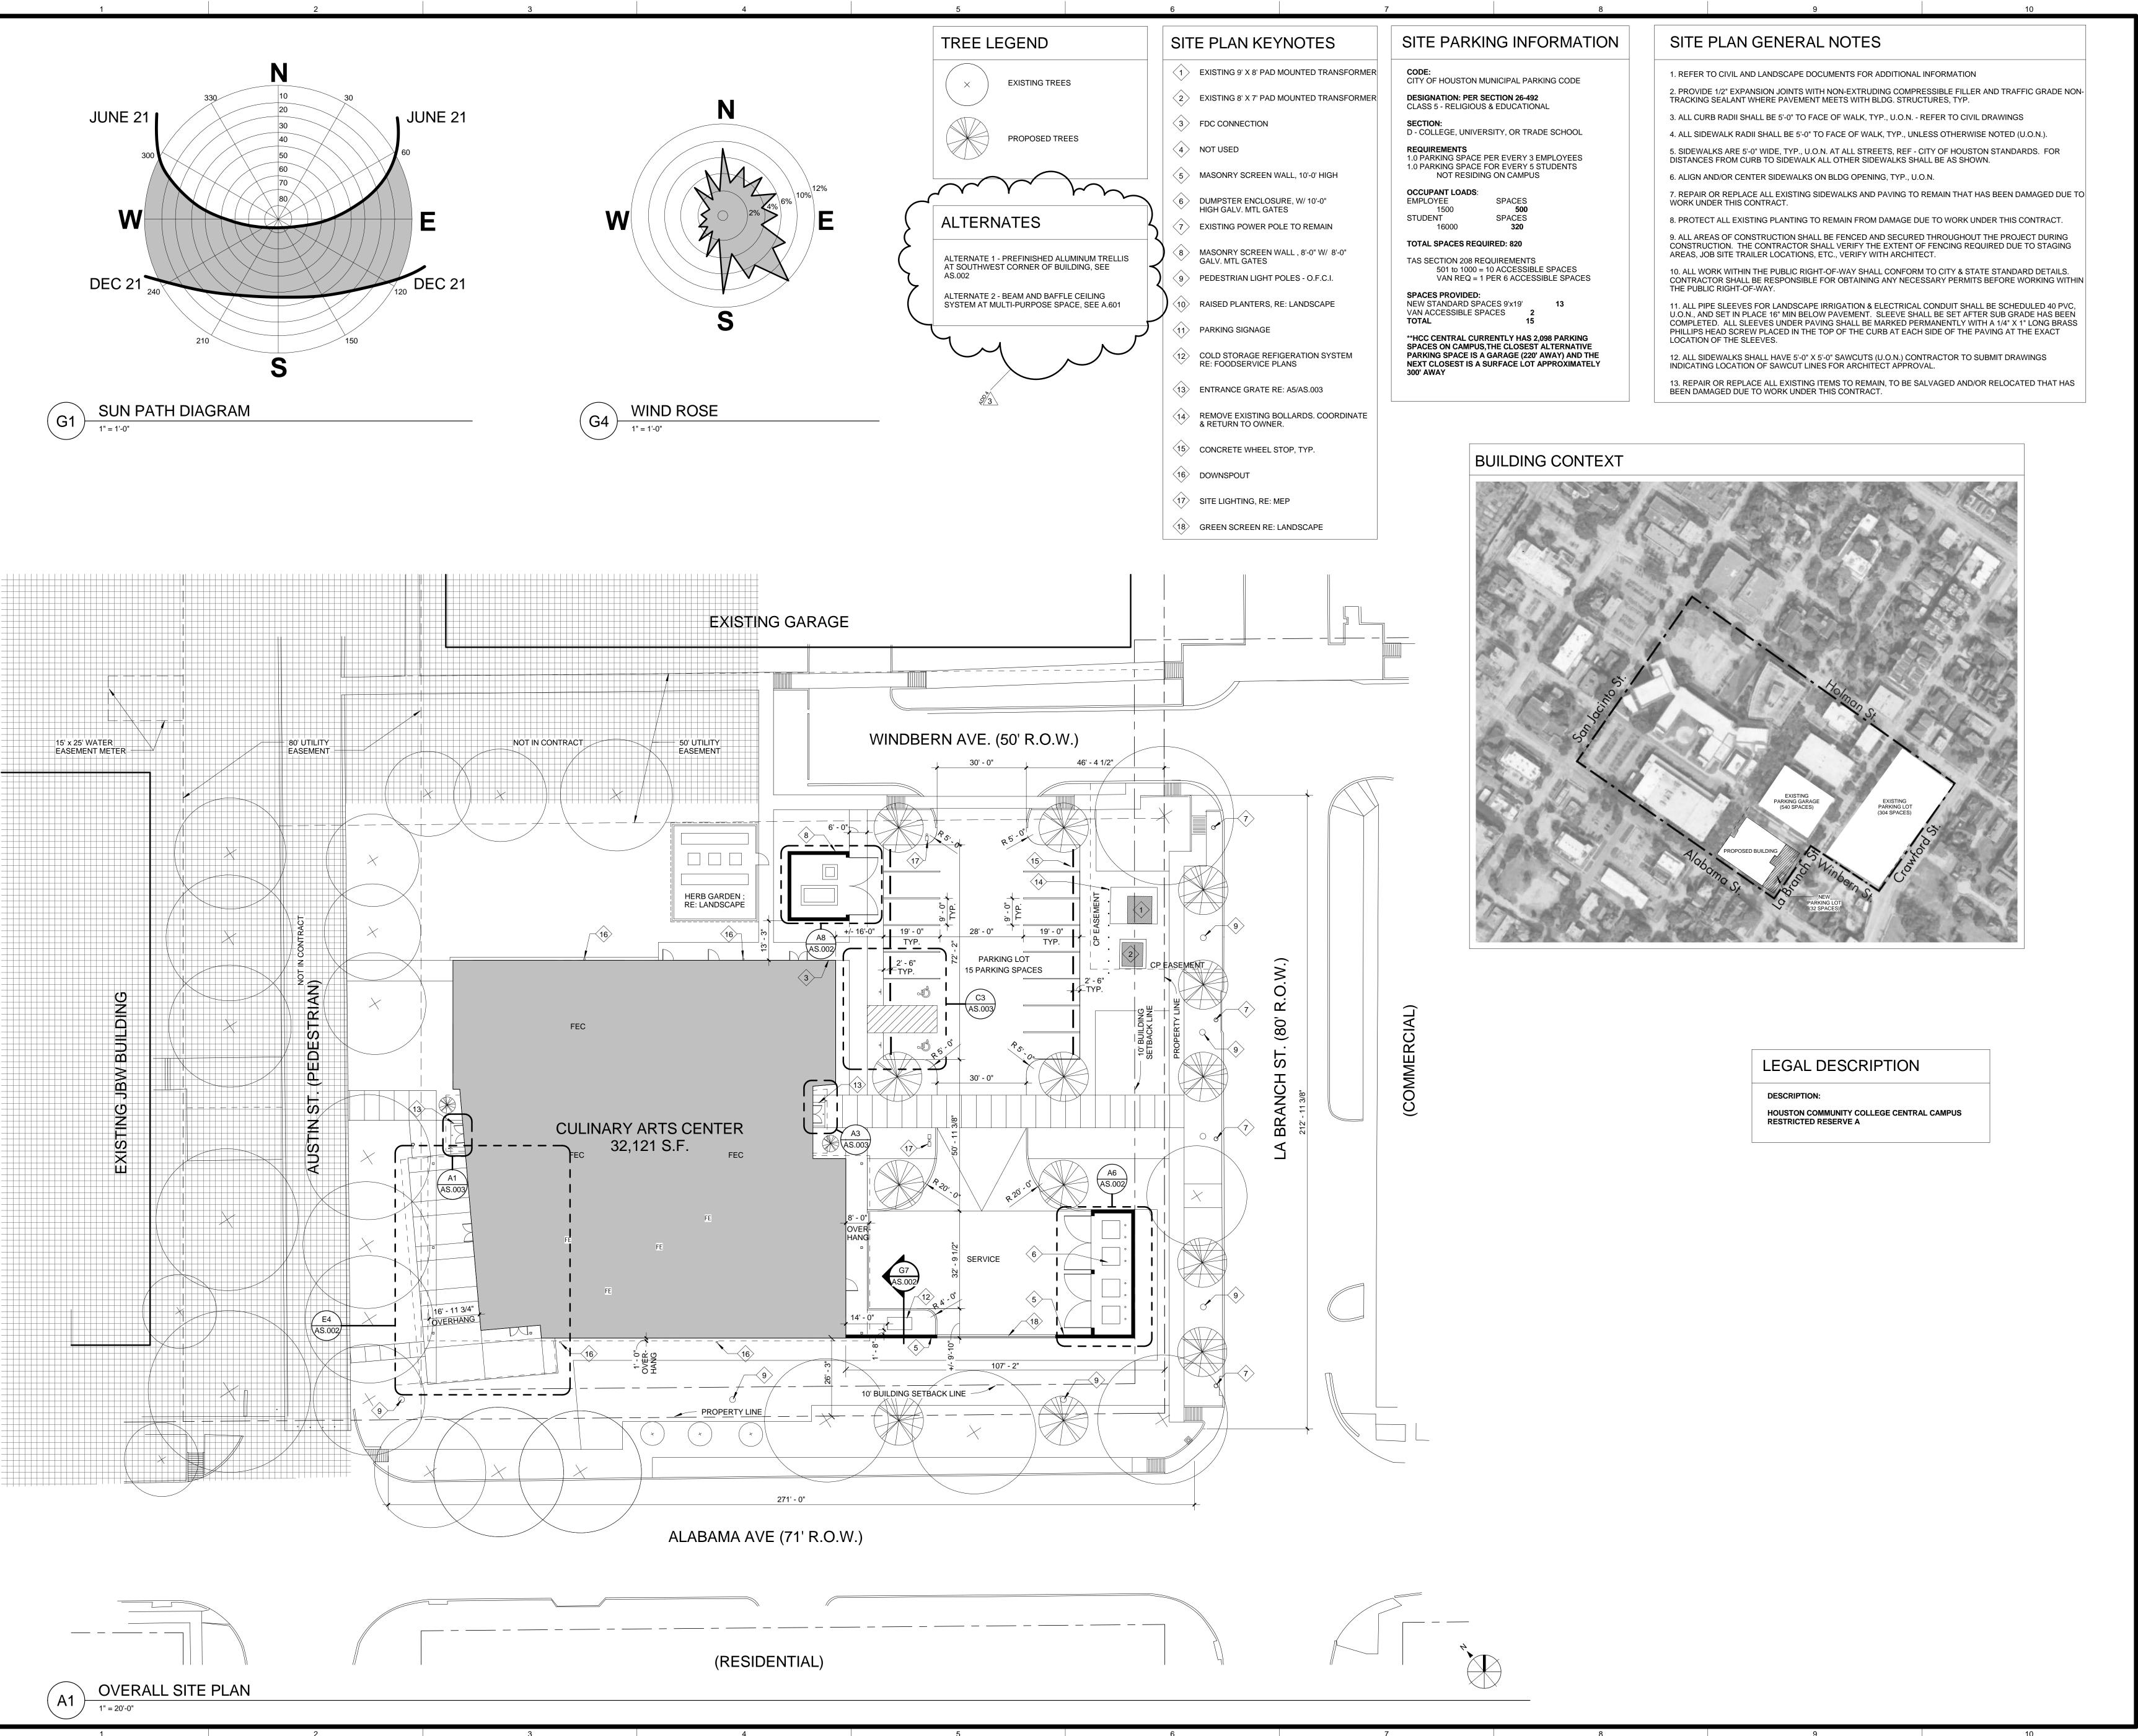

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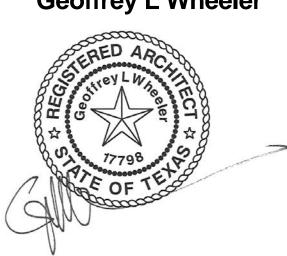
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> Issue for Bidding **Geoffrey L Wheeler**



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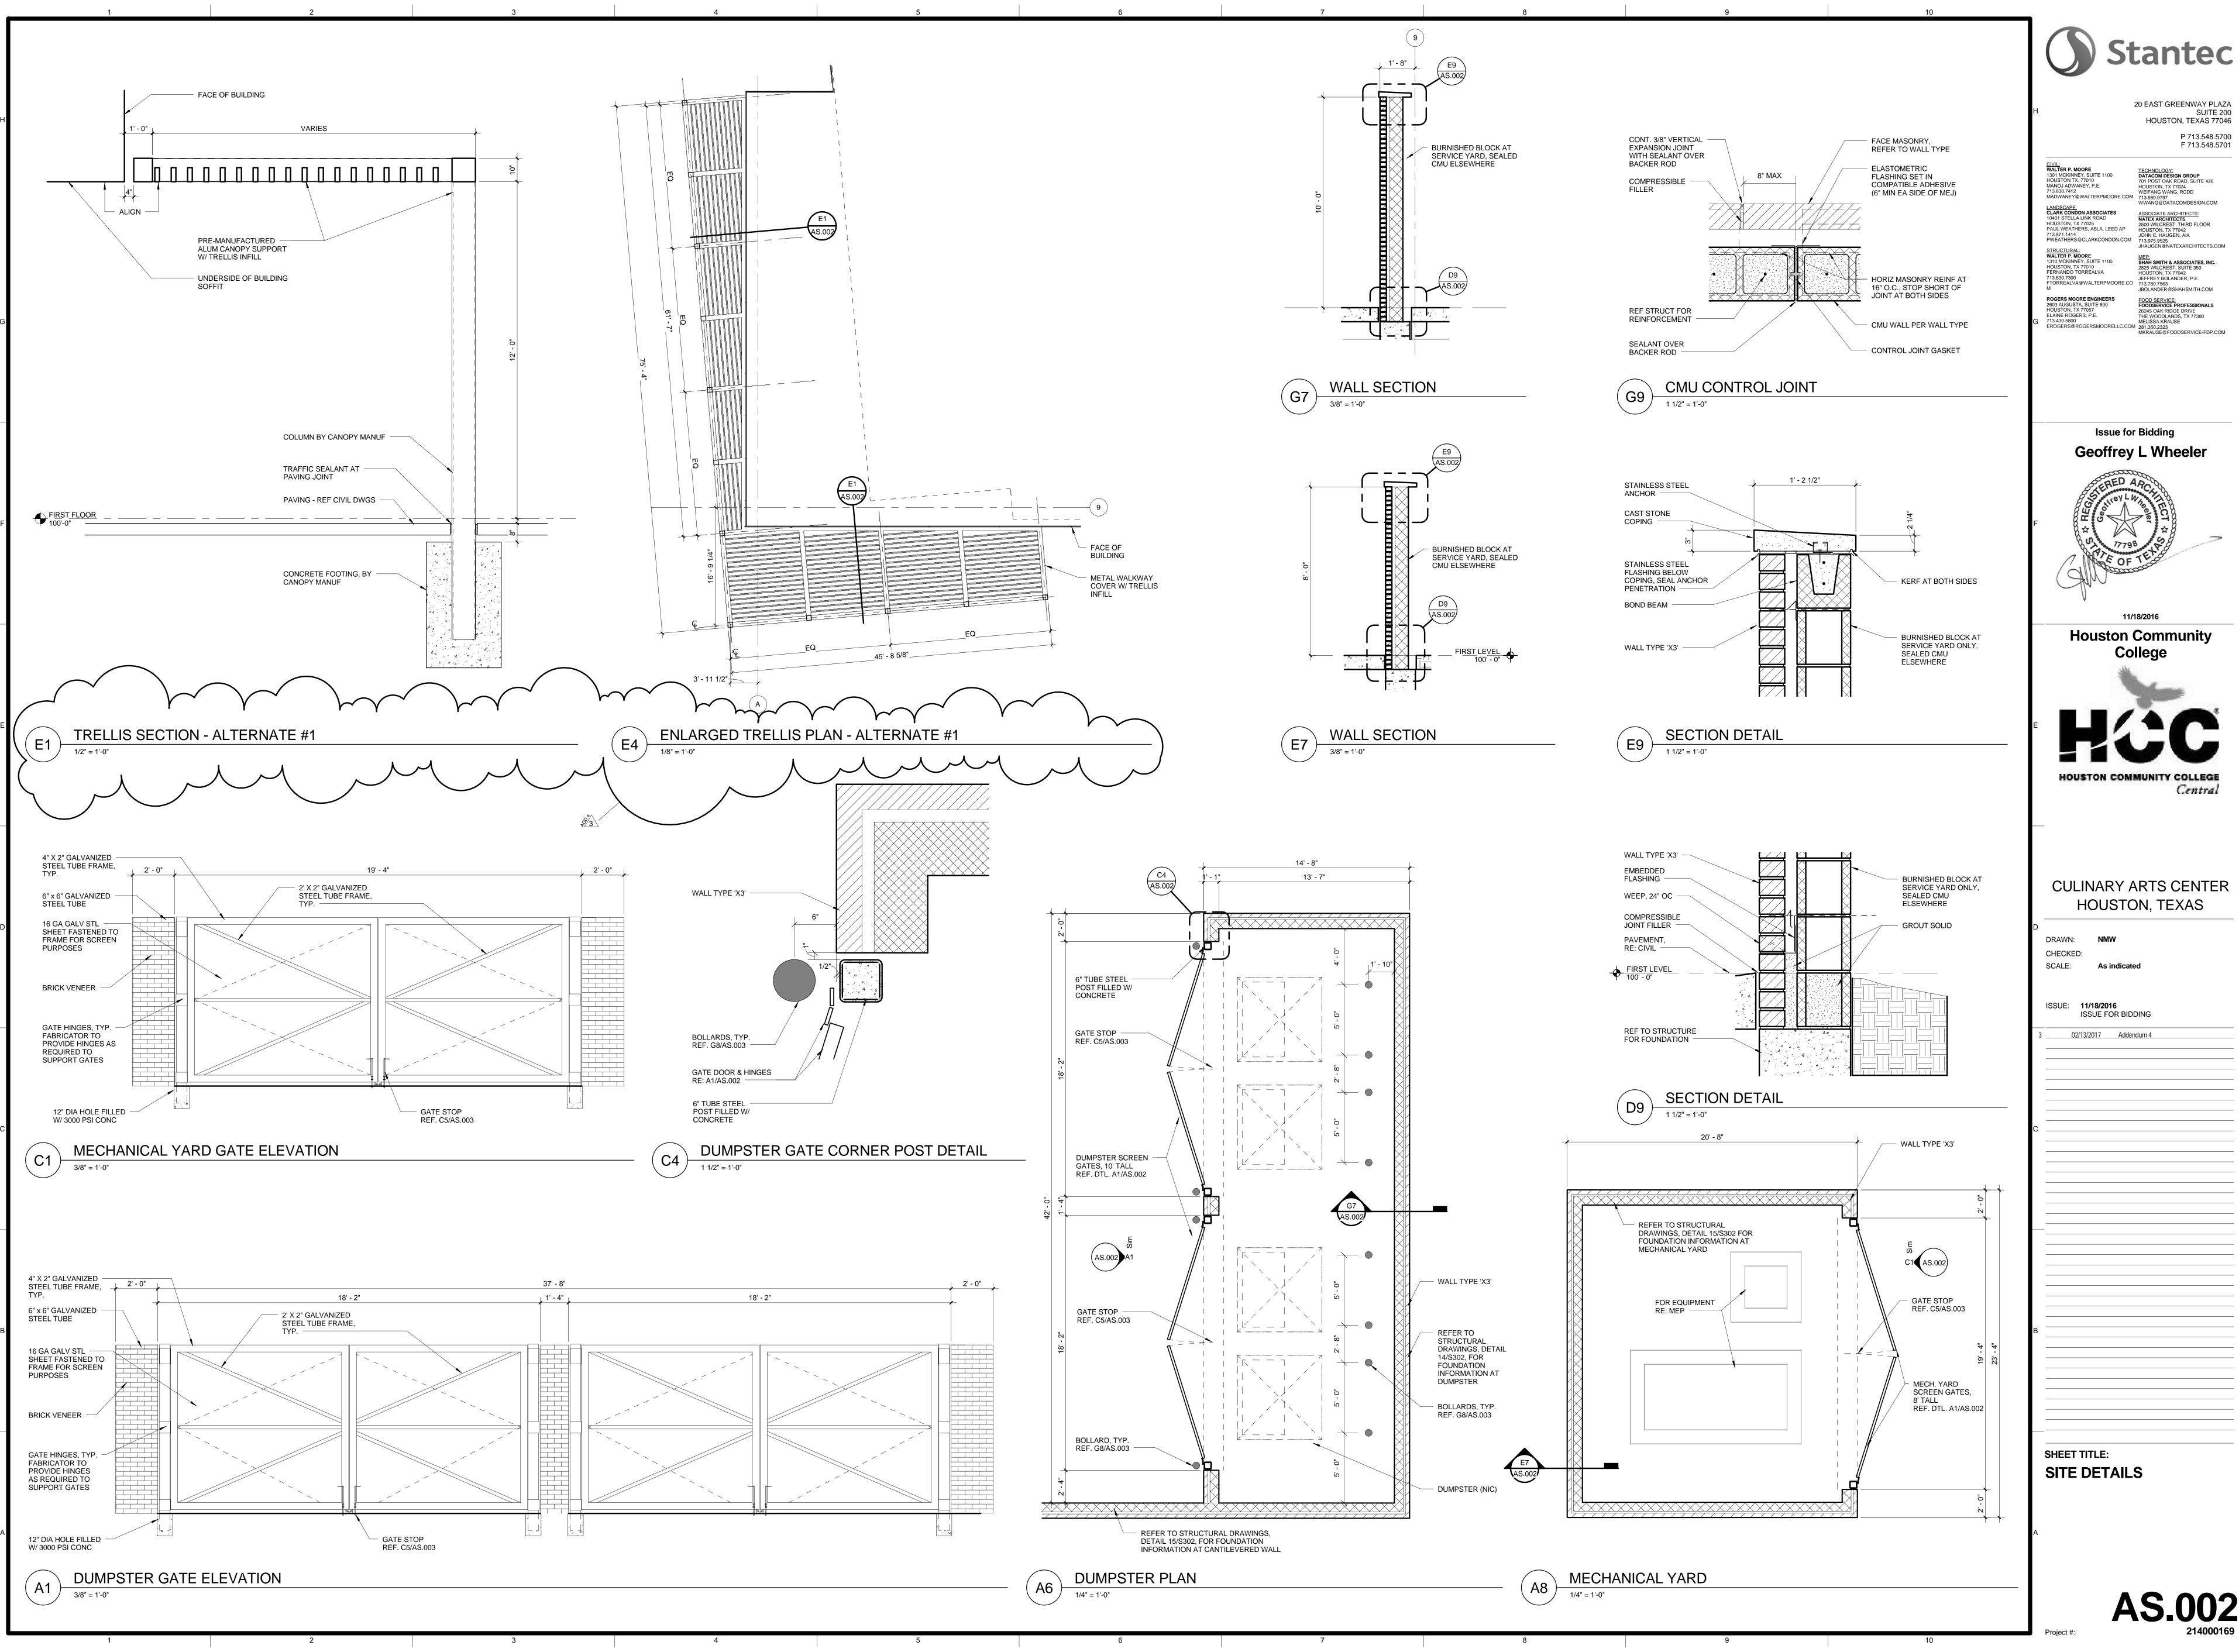
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SHEET TITLE: ARCHITECTURAL SITE

PLAN



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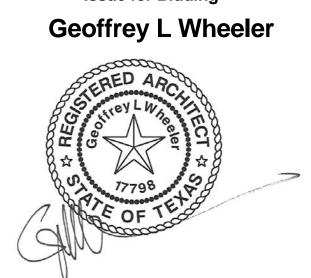
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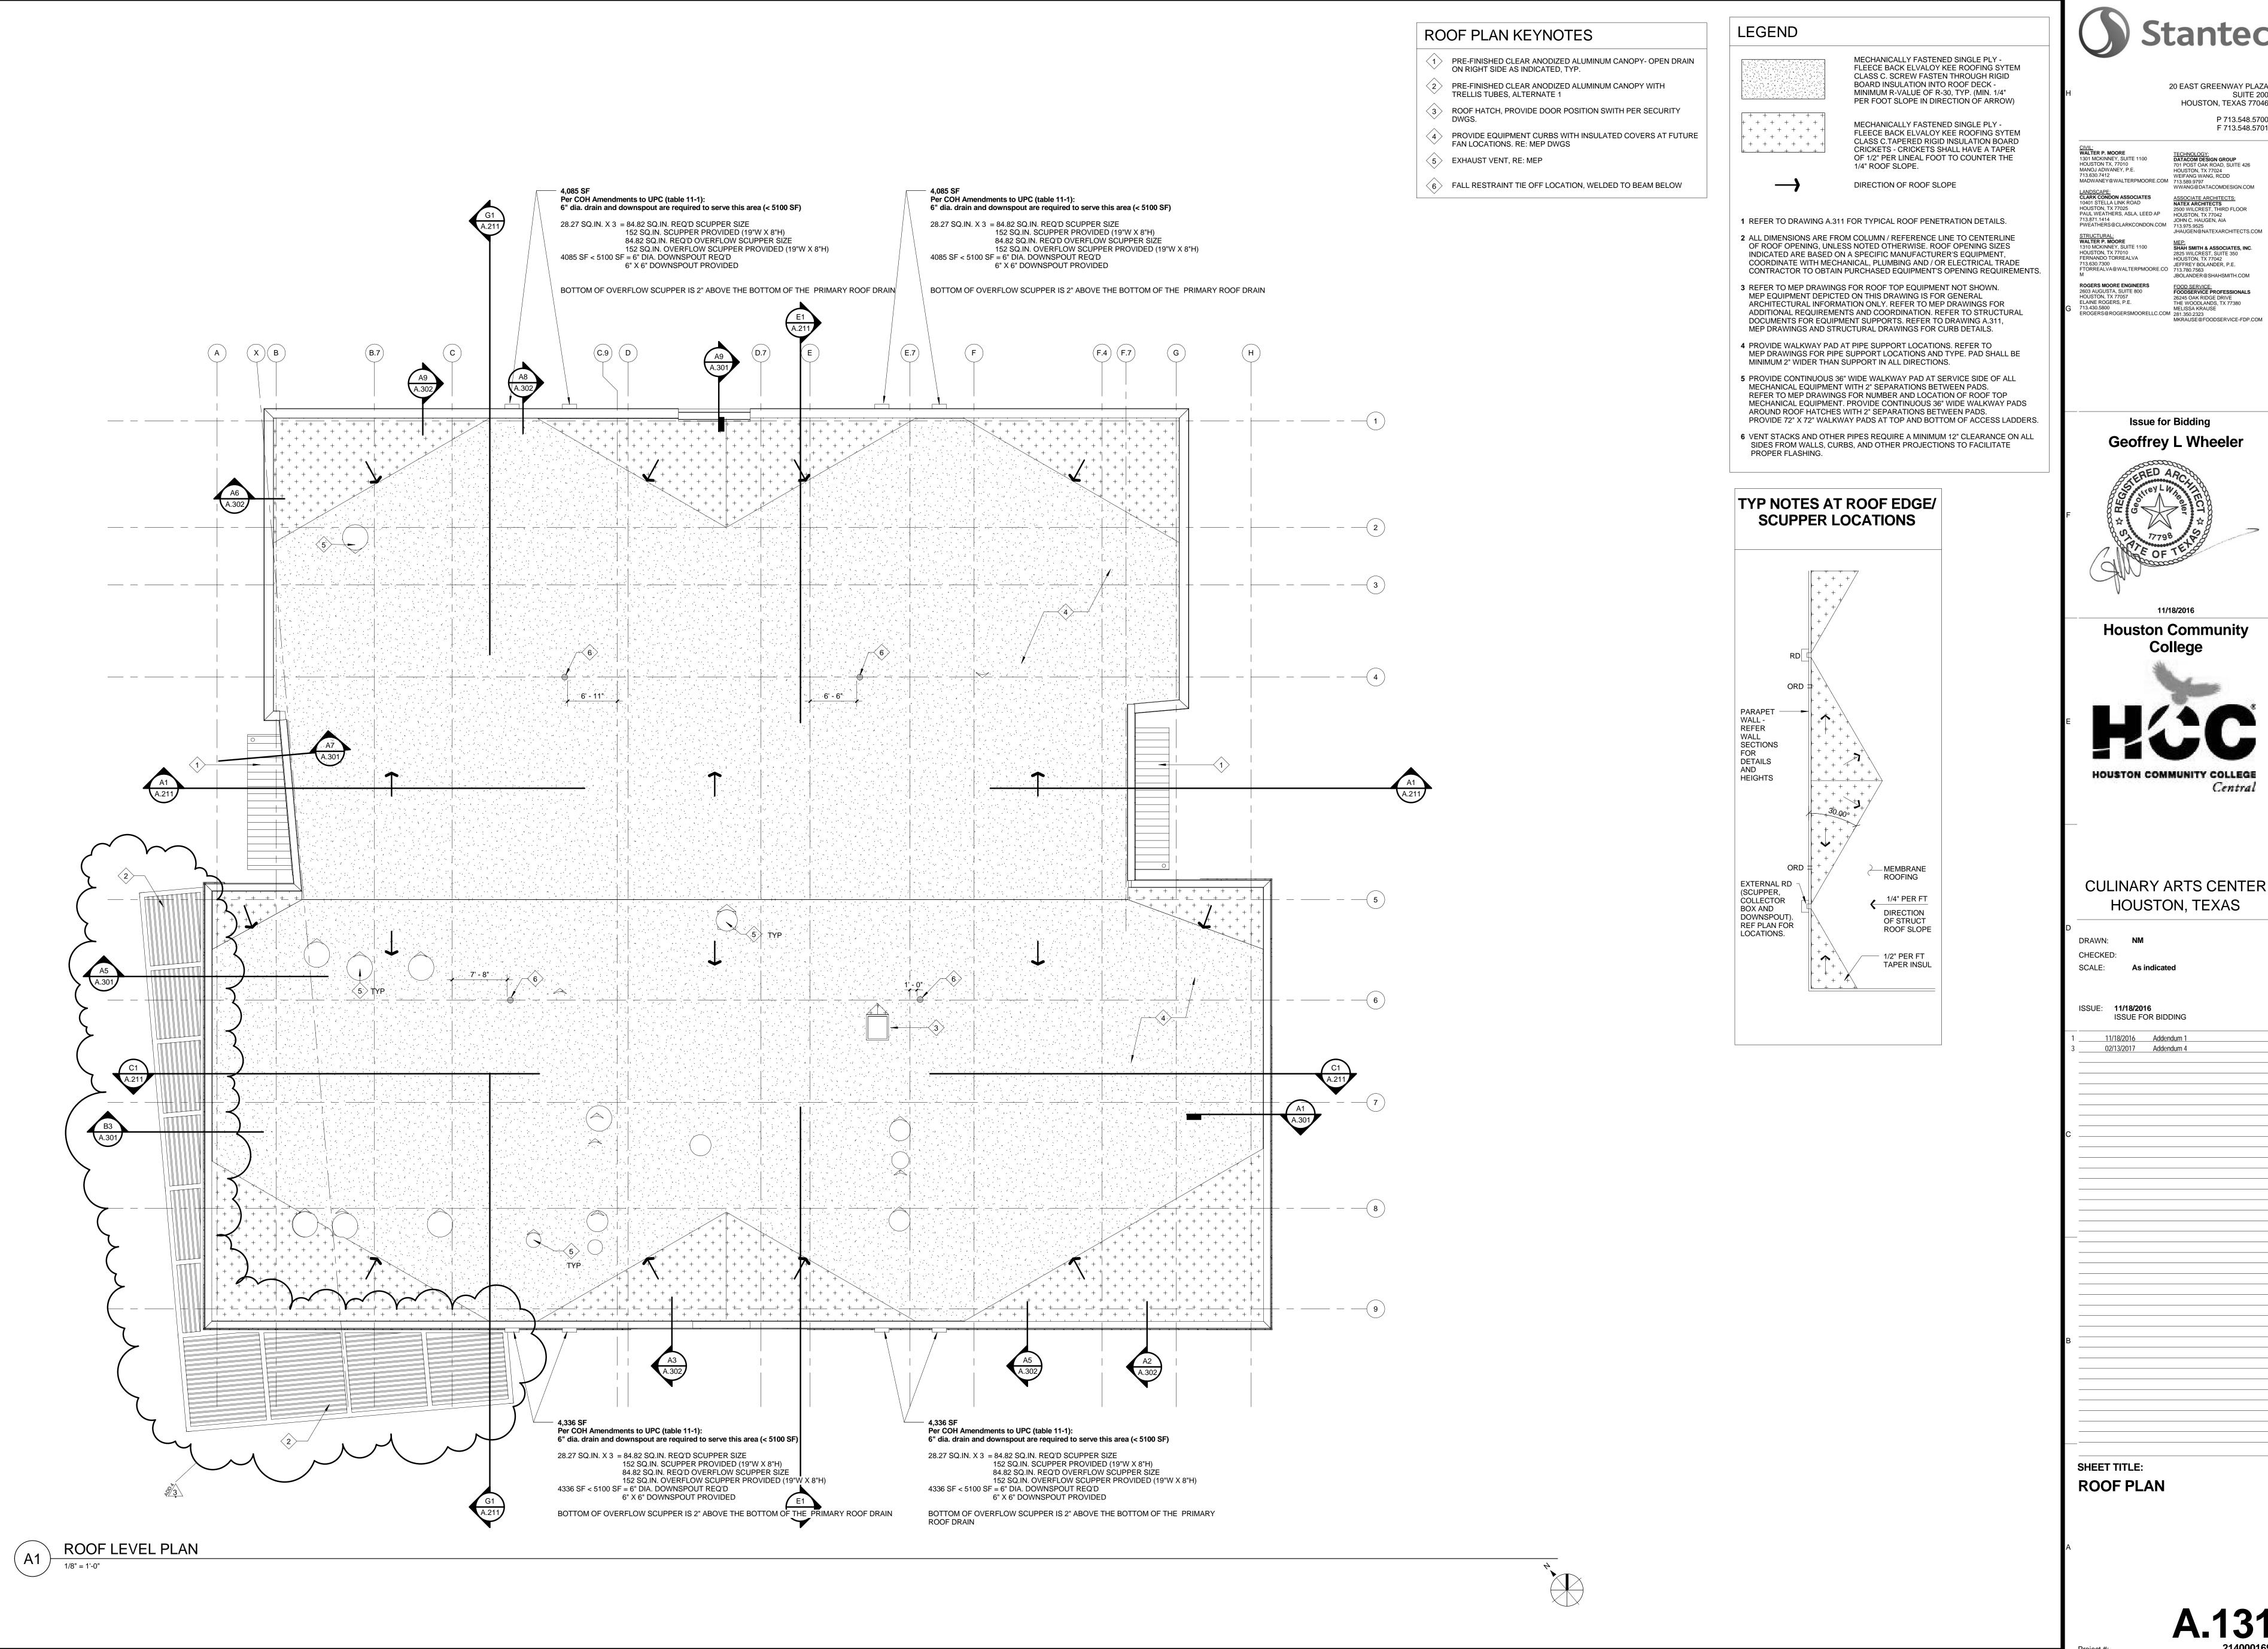
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SITE DETAILS

AS.002



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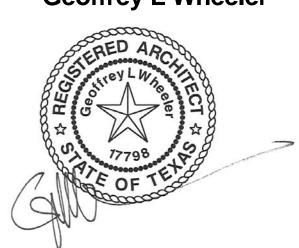
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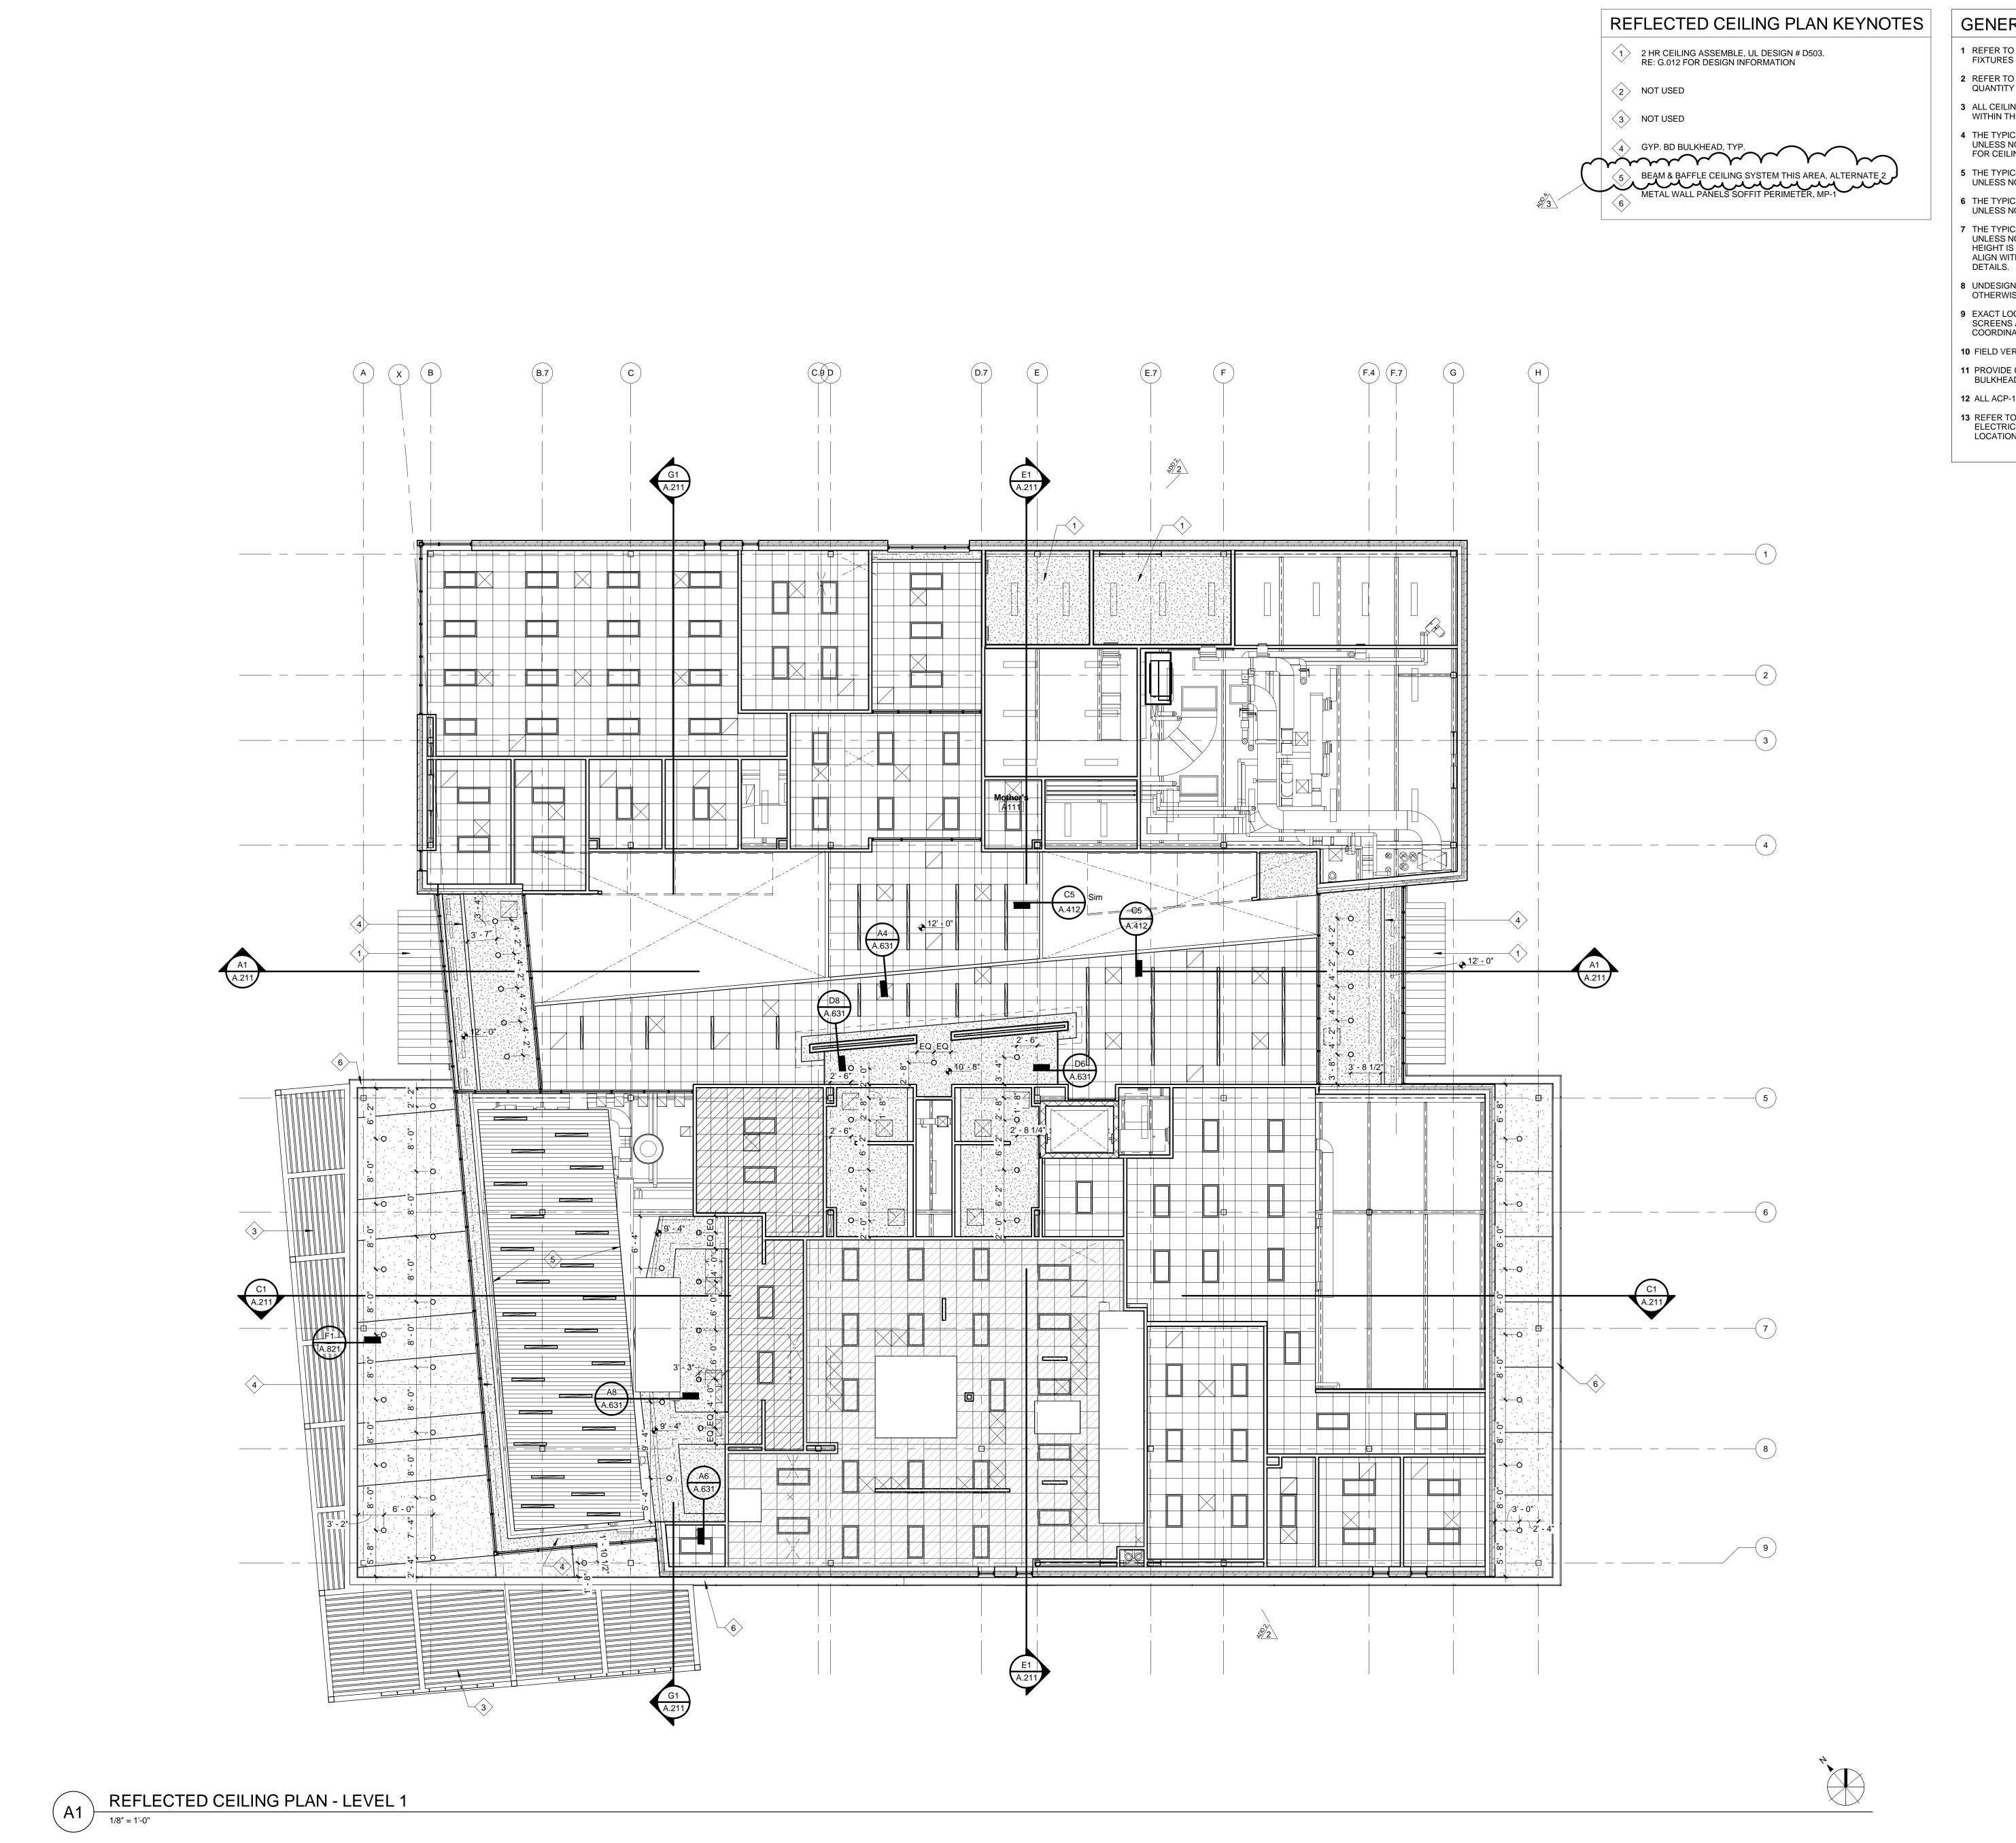
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> 11/18/2016 Addendum 1 02/13/2017 Addendum 4

SHEET TITLE: **ROOF PLAN**



GENERAL CEILING NOTES

1 REFER TO FLOOR PLANS & INTERIOR ELEVATIONS FOR WALL MOUNTED FIXTURES & DEVICES, ETC.

2 REFER TO MECHANICAL, ELECTRICAL & TECHNOLOGY DRAWINGS FOR

QUANTITY & TYPE OF CEILING MOUNTED FIXTURES & DEVICES, ETC.

3 ALL CEILING MOUNTED FIXTURES, DEVICES, ETC ARE TO BE CENTERED WITHIN THE CEILING TILE UNLESS NOTED OTHERWISE.

4 THE TYPICAL HEIGHT FOR SUSPENDED CEILINGS SHALL BE 10' - 0" AFF UNLESS NOTED OTHERWISE. REFER TO ROOM FINISH SCHEDULE FOR CEILING HEIGHTS.

5 THE TYPICAL HEIGHT FOR GYPSUM BOARD CEILINGS SHALL BE 10' - 0" AFF UNLESS NOTED OTHERWISE.


6 THE TYPICAL HEIGHT FOR GYPSUM BOARD BULKHEADS SHALL BE 9' - 6" AFF UNLESS NOTED OTHERWISE. 7 THE TYPICAL HEIGHT FOR GYPSUM BOARD SOFFITS SHALL BE 12' - 0" AFF, UNLESS NOTED OTHERWISE. NOTE: GYPSUM BOARD PERIMETER SOFFIT HEIGHT IS GENERAL IN NATURE, THOSE ABUTTING GLAZING SYSTEMS ARE TO ALIGN WITH THE TOP OR BOTTOM OF MULLION AS INDICATED IN SECTION

8 UNDESIGNATED PAINTED GYPSUM BOARD SOFFITS & CEILINGS UNLESS NOTED OTHERWISE TO BE PAINTED 'PT-1'.

9 EXACT LOCATIONS FOR PROJECTOR MOUNTS & CEILING MOUNTED PROJECTION SCREENS ARE TO BE FIELD VERIFIED TO ACHIEVE THE OPTIMUM PERFORMANCE. COORDINATE WITH TECHNOLOGY TRADE CONTRACTOR.

10 FIELD VERIFY ALL BULKHEAD DIMENSIONS PRIOR TO CONSTRUCTION. 11 PROVIDE CONTROL JOINTS AT 30' - 0" OC MAXIMUM AT ALL GYPSUM BOARD BULKHEADS

12 ALL ACP-1 CLOUDS / PANEL TERMINATIONS TO RECIEVE 4" AXIOM PERIMETER. 13 REFER TO ELECTRICAL SHEET E.001 FOR LUMINAIRE SCHEDULE AND ELECTRICAL LIGHTING PLAN SHEETS FOR LIGHTING FIXTURE TYPES &

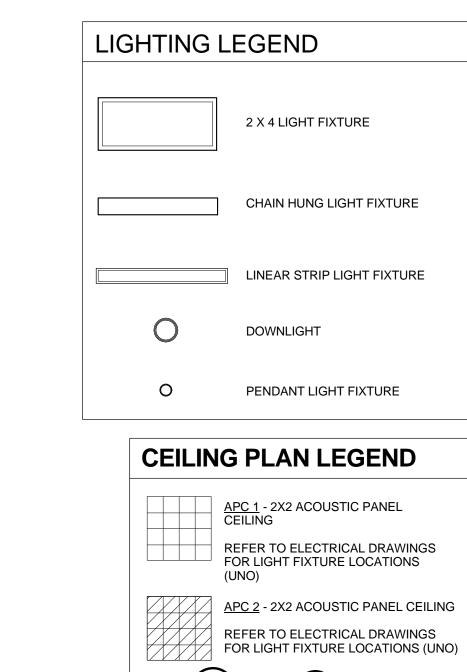

APC 3 - BEAM & BAFFLE SPECIALTY METAL CEILING SYSTEM (ALTERNATE 2)

REFER TO ELECTRICAL DRAWINGS FOR LIGHT FIXTURE LOCATIONS (UON)

GYPSUM BOARD BULKHEAD/CEILING -

REFER TO FINISH SCHEDULE FOR

MORE INFORMATION

ABOVE (PAINTED)

PLASTER SOFFIT

PREFINISHED ALUM CANOPY

EXPOSED TO STRUCTURE

\$3

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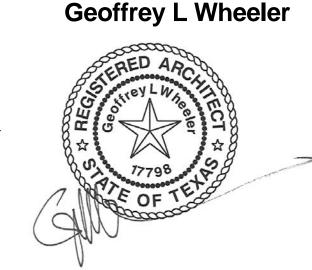
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> 01/23/2017 Addendum 2 02/13/2017 Addendum 4

SHEET TITLE: FIRST LEVEL CEILING **PLAN**

A.601

				CULINARY A	ARTS CENTER CO	OLOR SCHE	DULE		
	ĺ	MRK	MATERIAL	MANUFACTURER	STYLE	MFR. NO.	COLOR	REMARKS	CLASS
	Ī	PT-1	PAINT	SHERWIN WILLIAMS	ACRYLIC	SW7005	PURE WHITE	TYPICAL PAINT - ARCYLIC	
		PT-2	PAINT	SHERWIN WILLIAMS	EPOXY	SW7005	PURE WHITE	TYPICAL PAINT - EPOXY	
		PT-3	PAINT	SHERWIN WILLIAMS	ACRYLIC	SW7017	DORIAN GRAY	ACCENT PAINT	
	الد	PT-4	PAINT	SHERWIN WILLIAMS	ACRYLIC	SW6712	LUAU GREEN	ACCENT COLOR @ WALLS WHERE NOTED	
		PT-5	PAINT	SHERWIN WILLIAMS	ACRYLIC	SW6705	HIGH STRUNG	ACCENT COLOR @ WALLS WHERE NOTED	
	≥[PT-6	PAINT	SHERWIN WILLIAMS	ACRYLIC	SW6711	PARAKEET	ACCENT COLOR @ WALLS WHERE NOTED	
		PT-7	PAINT	SHERWIN WILLIAMS	ACRYLIC	SW6914	EYE CATCHING	ACCENT COLOR @ WALLS WHERE NOTED	
		PT-8	PAINT	SHERWIN WILLIAMS	ACRYLIC	SW6711	PARAKEET	ACCENT - EPOXY	
		PT-9	PAINT	SHERWIN WILLIAMS	ACRYLIC	SW6712	LUAU GREEN	ACCENT - EPOXY	
		PT-10	PAINT	SHERWIN WILLIAMS	ACRYLIC	SW6914	EYE CATCHING	ACCENT - EPOXY	
		PT-11	PAINT	SHERWIN WILLIAMS	ACRYLIC	SW7037	BALANCED BEIGE		
		PT-12	PAINT	SHERWIN WILLIAMS	ACRYLIC	SW7076	CYBERSPACE	ACCENT COLOR @ STAIR STRINGER	
	f	WP-1	WOOD PLANK	TERAGREN	RANDOM PLANKS	BFF-CHSNT-TL2	CHESNUT	VERTICAL SURFACE AT LOBBY WALL WHERE NOTED	С
	ŀ	CT-1	CERAMIC TILE	DALTILE	SEMI-GLOSS, 4 1/4" X 4 1/4"	0135 - GROUP 1	ALMOND	WHERE NOTED ON R.R. WALLS	С
	ŀ								
		FRP-1	FIBERGLASS REINFORCED PANEL	KEMLITE	GLASBORD	85	EMBOSSED WHITE		С
	\dashv	CPT-1	WALK OFF CARPET	TANDUS	ABRASIVE ACTION II	19100	CHARCOAL	ENTRANCE VESTIBULES, CLASS OR II	I OR II
		P CONC	POLISHED CONCRETE	RETROPLATE			CLEAR		
Ƴ│,		S CONC	SEALED CONCRETE	SELECT SEAL			CLEAR		
RIOR	ارد ا	CT-5	CERAMIC FLOOR TILE	DALTILE	KEYSTONES, 2" X 2"	D132 - GROUP 2	UPTOWN TAUPE	ALL RESTROOM FLOORS & INTEGRAL COVE BASE	
ا بی	Ō	CTB-1	CERAMIC TILE BASE	DALTILE	KEYSTONE, 2" X 2"	D132 - GROUP 2	UPTOWN TAUPE	ALL RESTROOM BASE	
	၂	RBR-1	RUBBER BASE	ROPPE	PINNACLE-TYPE-TS RUBBER	114	LUNAR DUST	TYPICAL WALL BASE FOR GYP BD	С
≥ i	ヹ゚゚	RBR-2	RUBBER FLOOR	ROPPE	995 HAMMERED	100	BLACK	@ ELEVATOR	
	ŀ								
		PLAM-1	PLASTIC LAMINATE	WILSONART	PREMIUM AEON	7209K-78	NEPAL TEAK	DOORS	
	ကျ	PLAM-2	PLASTIC LAMINATE	WILSONART		D431	ALABASTER	MILLWORK	
		QTZ-1	QUARTZ COUNTERTOP SURFACE	CAESARSTONE	CLASSICO	2003	CONCRETE	COUNTERTOP IN STUDENT STORAGE & LOUNGE	
از	ㅎ 	QTZ-2	QUARTZ COUNTERTOP SURFACE	CAESARSTONE	CLASSICO	4001	FRESH CONCRETE	COUNTERTOP IN LABS & RESTROOMS	
	$\tilde{\Sigma}$	TP-1	TOILET PARTITION	ACCURATE	SOLID PLASTIC	9205	BLACK	CEILING HUNG	
	<i>(</i>)}	RS	SHADES	MECHOSHADE	TBD	TBD	TBD	MANUAL	
	<u>ن</u>								
'	^					2			
	寸	APC-1	ACOUSTICAL PANEL	ARMSTRONG	CORTEGA	770	2' X 2'	TYPICAL CEILING	С
	ည်	APC-2	ACOUSTICAL PANEL	ARMSTRONG	CLEAN ROOM VL	UNPERFORATED		ALL KITCHENS / LABS, WHITE ALUM CAP ON GRID	С
[الخ	APC-3	BEAM & BAFFLE CEILING SYSTEM	HUNTER DOUGLAS	TAVOLA, 2" W X 6" H		PERF METAL, WD FINISH	WHERE NOTED IN MULTI-PURPOSE	С
		GYP	GYPSUM BOARD				PAINTED, PT-1		С
	三 山	EXPOSED-1	EXPOSED TO STRUCTURE				PAINTED		
	<u>ن</u>								
	ŀ								
EXTERIOR	\dashv	MP-1	METAL WALL PANEL	DRI-DESIGN	SHADOW SERIES 1 1/2" THICK	DRI-008	PNT'D ALUM - CITYSCAPE		
	ļ	MP-2	METAL WALL PANEL	DRI-DESIGN	SHADOW SERIES 3" THICK	DRI-008	PNT'D ALUM - CITYSCAPE		
	Į	MP-3	METAL WALL PANEL	DRI-DESIGN	SHADOW SERIES 1 1/2" THICK	DRI-125	PNT'D ALUM - SILVER		
	<u>^</u>	BK-1	VENEER MASONRY	FORTERRA	MODULAR	Y Y Y	V-225 VELOUR		
	Y	BBK-1	BURNISHED CMU	HEADWATERS	8"	. ۱. ۱۰ ۲۰ ۲۰	723 - TERRA COTTA		
		GL-1	GLAZING	HEADWATERS PPG	SOLARBAN	70XL	723 - TERRA COTTA ATLANTICA		
		PM-1	PREFINISHED METAL					TO MATCH MP-1 / MP-2	
		ALUM	ALUMINUM FRAME	KAWNEER			CLEAR ANODIZED		
-	\vdash			1		1	I .	1	

	GENERAL COLOR SCHEDULE NOTES							
NOTE: ALL COLORS SHOWN IN COLOR SCHEDULES ARE SUBJECT TO CHANGE. FIELD VERIFICATION BY ARCHITECT AND OWNER WILL OCCUR BEFORE FINAL PAINT COLORS ARE SELECTED. CONTRACTOR TO PROVIDE COLOR SAMPLES TO MATCH EXISTING COLORS, TYP. MANUFACTURERS NAMES AND IDENTIFICATION NUMBERS ARE LISTED AS A MEANS OF ESTABLISHING A STANDARD OF								
AL	2. MANUFACTURERS NAMES AND IDENTIFICATION NUMBERS ARE LISTED AS A MEANS OF ESTABLISHING A STANDARD OF TYPE, FUNCTION, COLOR, AND QUALITY. REFER TO PROJECT MANUAL FOR ADDITIONAL MANUFACTURERS & PROCEDURES.							
	3. THE CONTRACTOR SHALL SUBMIT TO THE ARCHITECT A SAMPLE OF ALL FINISH MATERIALS FOR APPROVAL BEFORE							
ENERAL	MATERIALS ARE APPLIED ON THE JOB. 4. PAINT ALL INTERIOR & EXTERIOR EXPOSED PIPING INCLUDING SPRINKLER PIPING. VERIFY COLOR W/ ARCHITECT.							
<u>5</u>	5. PAINT ANY VENTS, GRILLES, PIPING, CONDUIT, ETC SAME COLOR AS ADJACENT WALL OR CEILING.							
	COLORS WILL BE MARKED AS SHOWN. NOTE ALL COLORS MAY NOT BE MARKED ON PLANS. MATERIALS NOT NOTED WILL BE COVERED UNDER GENERAL NOTES OR WILL BE SELECTED ON THE JOB BY THE ARCHITECT.							
	1. ALL INTERIOR STEEL DOOR FRAMES TO BE PT-1.							
~	2. ALL EXTERIOR STEEL DOOR FRAMES AND DOORS TO BE PT-11.							
TERIOR	3. ALL INTERIOR PLASTIC LAMINTATE FACED WOOD DOORS TO BE PLAM-1.							
~	4. ALL TOILET PARTITIONS SHALL BE MARK TP-1.							
įΞ	5. ALL COUNTERTOPS SHALL BE AS DESIGNATED QTZ-1, U.N.O.							
与	6. ALL WALLS BEHIND DRINKING FOUNTAINS TO BE EPOXY PAINT, PT-2.							
Z	7. ALL CASEWORK DOOR, DRAWER, AND SHELF EDGES AND COUNTERTOPS ARE TO HAVE 3MM PVC EDGEBANDING. THIS IS TO BE A CUSTOM MATCH TO THE COLOR, PATTERN, AND TEXTURE OF ADJACENT LAMINATE ON ALL SURFACES.							
	8. ALL WET AREAS TO HAVE EPOXY PAINT, PT-2, U.N.O.							
	9. ALL INTERIOR EXPOSED CONCRETE TO BE SEALED AND POLISHED, TYPICAL, U.N.O.							
	10. ALL EXPOSED STEEL STRUCTURAL MEMBERS AND DECK TO BE PAINTED PT-1, PROPERLY PREPARE STEEL FOR PAINT. 11. AT ALL SUSPENDED CLOUD CEILINGS, 4" AXIOM EDGE TRIM IS TO BE INSTALLED AT ALL PERIMETER EDGES U.N.O.							
	11. AT ALL SUSPENDED CLOUD CEILINGS, 4 AXIOM EDGE TRIM IS TO BE INSTALLED AT ALL PERIMETER EDGES U.N.O. 12. PROVIDE FRP WAINSCOT TO 4'-0" AFF & 8'-0" MAXIMUM HORIZONTALLY AT WALL BEHIND MOP SINK. EPOXY PAINT AT ALL OTHER WALLS, TYF							
	13. ALL INT. WALL & CLG FINISHES HAVE A MINIMUM CLASS C RATING							
	14. WALK-OFF CARPET TO HAVE A CLASS I OR II RATING							
	1. ALL EXTERIOR STEEL LINTELS SHALL BE GALVANIZED.							
~	2. ALL ALUM. STOREFRONT WINDOWS & DOOR FRAMES SHALL BE CLEAR ANODIZED; EXTERIOR GLAZING TO BE PPG SOLARBAN 70XL, ATLANTICA, U.N.O.							
<u>o</u>	3. ALL EXTERIOR LETTERING SHALL BE CLEAR ANODIZED.							
EXTERIO	4. ALL EXTERIOR METAL SHALL BE FINISHED AS FOLLOWS:							
2	PM-1 - METAL COPING, AND FLASHING NOTED ON COLOR SCHEDULE AND EXTERIOR ELEVATIONS.							
\times	PM-1 - ALL UNDESIGNATED PRE-FINISHED METAL							
ш	5. ALL EXT COUNTER FLASHING, PIPE SUPPORTS AND MISC. FLASHING TO COORDINATE WITH EXTERIOR WALL FINISH. COLORS TO BE VERIFIED BY ARCHITECT							
	5. ALL EXT COUNTER FLASHING, PIPE SUPPORTS AND MISC. FLASHING TO COORDINATE WITH EXTERIOR WALL FINISH. COLORS TO BE VERIFIED BY ARCHITECT.							

				ROOM SO	CHEDULE - FIRST	LEVEL					
					W	ALLS		CEIL	ING		ASIGNED
ROOM#	ROOM NAME	FLOOR	BASE	NORTH	EAST	SOUTH	WEST	HEIGHT	FINISH	REMARKS	ROOM #
			T								
A100	Work Stations	P. CONC	RBR-1	PT-3	PT-1	PT-1	PT-1		APC-1		
A101	Office	P. CONC	RBR-1	PT-1	PT-1	PT-3	PT-1		APC-1		
A102	Cons	P. CONC	RBR-1	PT-1	PT-1	PT-3	PT-1		APC-1		
A103	Cons	P. CONC	RBR-1	PT-1	PT-1	PT-3	PT-1		APC-1		
A104	Cons	P. CONC	RBR-1	PT-1	PT-1	PT-3	PT-1		APC-1	2	
A105	Storage	S. CONC	RBR-1	PT-1	PT-1	PT-1	PT-1		EXP		
A106	Rec	P. CONC	RBR-1	PT-1	PT-1	PT-1	PT-6		APC-1		
A107	Lounge	P. CONC	RBR-1	PT-1	PT-1	PT-1	PT-5		APC-1		
A108	Conf	P. CONC	RBR-1	PT-1	PT-4	PT-1	PT-1		APC-1		
A109	Em Elec	S. CONC	RBR-1	PT-1	PT-1	PT-1	PT-1		EXP		
A110	MDF	S. CONC	RBR-1	PT-1	PT-1	PT-1	PT-1		EXP		
A111	Mother's	S. CONC	RBR-1	PT-1	PT-1	PT-1	PT-1		APC-1		
A112	Jan	S. CONC	RBR-1	PT-2, FRP	PT-2, FRP	PT-2	PT-2		EXP	4	
A113	Main Elec	S. CONC	RBR-1	PT-1	PT-1	PT-1	PT-1		EXP		
A114	Fire Pump	S. CONC	RBR-1	PT-1	PT-1	PT-1	PT-1		EXP		
A115	Mech	S. CONC	RBR-1	PT-1	PT-1	PT-1	PT-1		EXP		
A116	Student Lounge/Resource	P. CONC	RBR-1	PT-3, PT-4	PT-1	WP-1	PT-1		APC-1	2,5	
A117	Vestibule	CPT-1	RBR-1	-	PT-1	-	PT-1		GYP		
A118	Cooler	S. CONC	RBR-1	PT-1	PT-1	PT-1	PT-1		EXP		
A119	Cooler	S. CONC	RBR-1	PT-1	PT-1	PT-1	PT-1		EXP		
A120	Freezer	S. CONC	RBR-1	PT-1	PT-1	PT-1	PT-1		EXP -	\$ 2	
A121	Staging	S. CONC	RBR-1	PT-1	PT-1	PT-1	PT-1		EXP		
A123	Cooler	S. CONC	RBR-1	PT-1	PT-1	PT-1	PT-1		EXP		
A124	Receive	P. CONC	RBR-1	PT-2	PT-2	PT-2	PT-2		APC-1	1	
A125	Off	P. CONC	RBR-1	PT-1	PT-1	PT-1	PT-1		APC-1		
A126	Off	P. CONC	RBR-1	PT-1	PT-1	PT-1	PT-1		APC-1		
A127	Liquor Stor	S. CONC	RBR-1	PT-1	PT-1	PT-1	PT-1		APC-1		
A128	Store Lab	P. CONC	RBR-1	PT-2	PT-2	PT-2	PT-2		APC-1		
A129	Dry Storage	S. CONC	RBR-1	PT-1	PT-1	PT-1	PT-1		APC-1		
A130	Specialty Lab	P. CONC	RBR-1	PT-2	PT-2	PT-2	PT-2		APC-2		
A131	Recycle	S. CONC	RBR-1	PT-1	PT-1	PT-1	PT-1		APC-1		
A132	Elev. Equip.	S. CONC	RBR-1	PT-1	PT-1	PT-1	PT-1		EXP		
A133	Elevator	RBR-2	-	-	-	-	-				
A134	Women	CT-5	CTB-1	CT-1	PT-8	CT-1	CT-1	9' - 0"	GYP	6	
A135	Mech	S. CONC	RBR-1	PT-1	PT-1	PT-1	PT-1		EXP		
A136	Men	CT-5	CTB-1	CT-1	CT-1	CT-1	PT-10	9' - 0"	GYP	6	
A137	China Room	S. CONC	RBR-1	PT-1	PT-1	PT-1	PT-1		APC-2		
A138	Staging	P. CONC	RBR-1	PT-2	PT-2	PT-2	PT-2		APC-2		
A139	Dishes	P. CONC	RBR-1	PT-2	-	PT-2	PT-2		APC-2		
A140	Storage	S. CONC	RBR-1	PT-1	PT-1	PT-1	PT-1		APC-1		
A141	Multipurpose	P. CONC	RBR-1	PT-2	WP-1	PT-2	PT-2		GYP, APC-3	2	
A142	Vestibule	CPT-1	RBR-1	-	PT-1	PT-1	PT-1		GYP		
A143	Demo Kitchen	P. CONC	RBR-1	PT-2	PT-2	PT-2	PT-2		GYP		

				ROOM SCH	IEDULE - SE	COND LEVEL					
					,	WALLS		C	EILING		ASIGNED ROOM#
ROOM#	ROOM NAME	FLOOR	BASE	NORTH	EAST	SOUTH	WEST	HEIGHT	FINISH	REMARKS	
A200	Pastry Lab 1	P. CONC	RBR-1	PT-2	PT-8	PT-2	PT-2		APC-2		
A201	Student Storage	P. CONC	RBR-1	PT-1	PT-1	PT-1	PT-1		APC-1		
A202	Elec	S. CONC	RBR-1	PT-1	PT-1	PT-1	PT-1		EXP		
A203	IDF	S. CONC	RBR-1	PT-1	PT-1	PT-1	PT-1		EXP		
A204	Pastry Lab 2	P. CONC	-	-	-	-	-				
A205	Lobby	P. CONC	RBR-1	PT-1	PT-1	WP-1	PT-1		GYP, APC-1	2	
A206	Elevator	RBR-2	-	-	-	-	-				
A208	Storage	S. CONC	RBR-1	PT-1	PT-1	PT-1	PT-1		EXP		
A209	Culinary Lab 2	P. CONC	-	-	-	-	-				
A210	Dish	P. CONC	RBR-1	PT-1	PT-1	PT-1	PT-1				
A211	Boiler	S. CONC	RBR-1	PT-1	PT-1	PT-1	PT-1				
A212	Mech	S. CONC	RBR-1	PT-1	PT-1	PT-1	PT-1		EXP		
A213	Women's	CT-5	CTB-1	CT-1	PT-8	CT-1	CT-1	9' - 0"	GYP	6	
A214	Men's	CT-5	CTB-1	CT-1	CT-1	CT-1	PT-10	9' - 0"	GYP	6	
A215	Jan	S. CONC	RBR-1	PT-2	PT-2	PT-2, FRP	PT-2, FRP		EXP	4	
A216	Storage	S. CONC	RBR-1	PT-1	PT-1	PT-1	PT-1		APC-1		
A217	Dish	P. CONC	RBR-1	PT-2	PT-2	PT-2	PT-2		APC-2		
A218	Culinary Lab 1	P. CONC	RBR-1	PT-2	PT-8	PT-2	PT-2		APC-2	3	
A219	Mech	S. CONC	RBR-1	PT-1	PT-1	PT-1	PT-1		EXP		

LOCATIONS

(GENERAL NOTES:	
1	UNLESS NOTED OTHERWISE, INTERIOR UNDESIGNATED PAINTED: GYPSUM BOARD WALLS PT-1 GYPSUM BOARD SOFFITS & BULKHEADS HOLLOW METAL DOOR & FRAMES EXPOSED STEEL (COLUMNS, BEAMS, LINTELS, ETC) EXPOSED STEEL (GUARD & HANDRAILS) PT-1	PT-1 PT-1 PT-1
2	UNLESS NOTED OTHERWISE, EXTERIOR UNDESIGNATED PAINTED: HOLLOW METAL DOORS & FRAMES PT-11 ROOF TOP EQUIPMENT (MECH EQUIP, SPEAKERS, ETC) GUARD RAILS, POSTS, SCREENS	PT-11 PT-11
3	ELEVATOR CAB FINISHES (UNLESS NOTED OTHERWISE): FLOOR FINISH WALLS CEILING	RBR-2 SS SS
4	ALL INTERIOR FLOORS TO BE POLISHED CONCRETE U.N.O.	
5	ALL INTERIOR CONCRETE FLOORS TO HAVE 1/4" WIDE x ONE-FOUR OF SLAB DEPTH, SEALANT FILLED SAW CUT CONTROL JOINTS. MAX CJ SPACING: 4" SLAB = 10'-0", 5" SLAB = 11'-0", 6" SLAB = 12 CONTRACTOR TO SUBMIT CJ LAYOUT FOR APPROVAL.	
6	ALL WALL BASES TO BE RBR-1 U.N.O.	

8 ALL OUTSIDE GYP BD CORNERS TO HAVE CORNER GUARDS, TYP.

9 ALL MARKER BOARDS TO BE OWNER FURNISHED CONTRACTOR INSTALLED, TYP.

REMARKS: 1 IMPACT RESISTANT GYP. BD. TO 4'-0." 2 REFER TO A900 SHEETS FOR WP-1 LOCATION
3 REFER TO A.900 SHEETS FOR ACCENT PAINT LOCATION
4 PROVIDE FRP-1 TO 4'-0" A.F.F. AT WALLS EITHER SIDE OF MOP SINK 5 IMPACT RESISTANT GYP. BD. TO WALLS UNDER STAIRS 6 CERAMIC TILE BASE TO EXTEND 4" UP WALL & TO HAVE INTEGRAL COVE
7 PROVIDE STAINLESS STEEL PANELS BEHIND ALL HOODS. STAINLESS STEEL
TO EXTEND FROM BOTTOM OF HOOD TO FINISHED FLOOR RE: A. 702 FOR

20 EAST GREENWAY PLAZA SUITE 200 HOUSTON, TEXAS 77046 P 713.548.5700 F 713.548.5701

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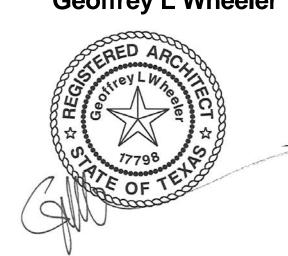
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> Issue for Bidding **Geoffrey L Wheeler**



Houston Community




CULINARY ARTS CENTER HOUSTON, TEXAS

DRAWN: **NM** CHECKED: SCALE: **12" = 1'-0"**

ISSUE: 11/18/2016
ISSUE FOR BIDDING 01/23/2017 Addendum 2 3 <u>02/13/2017</u> Addendum 4

SHEET TITLE:

MATERIAL AND FINISH SCHEDULES

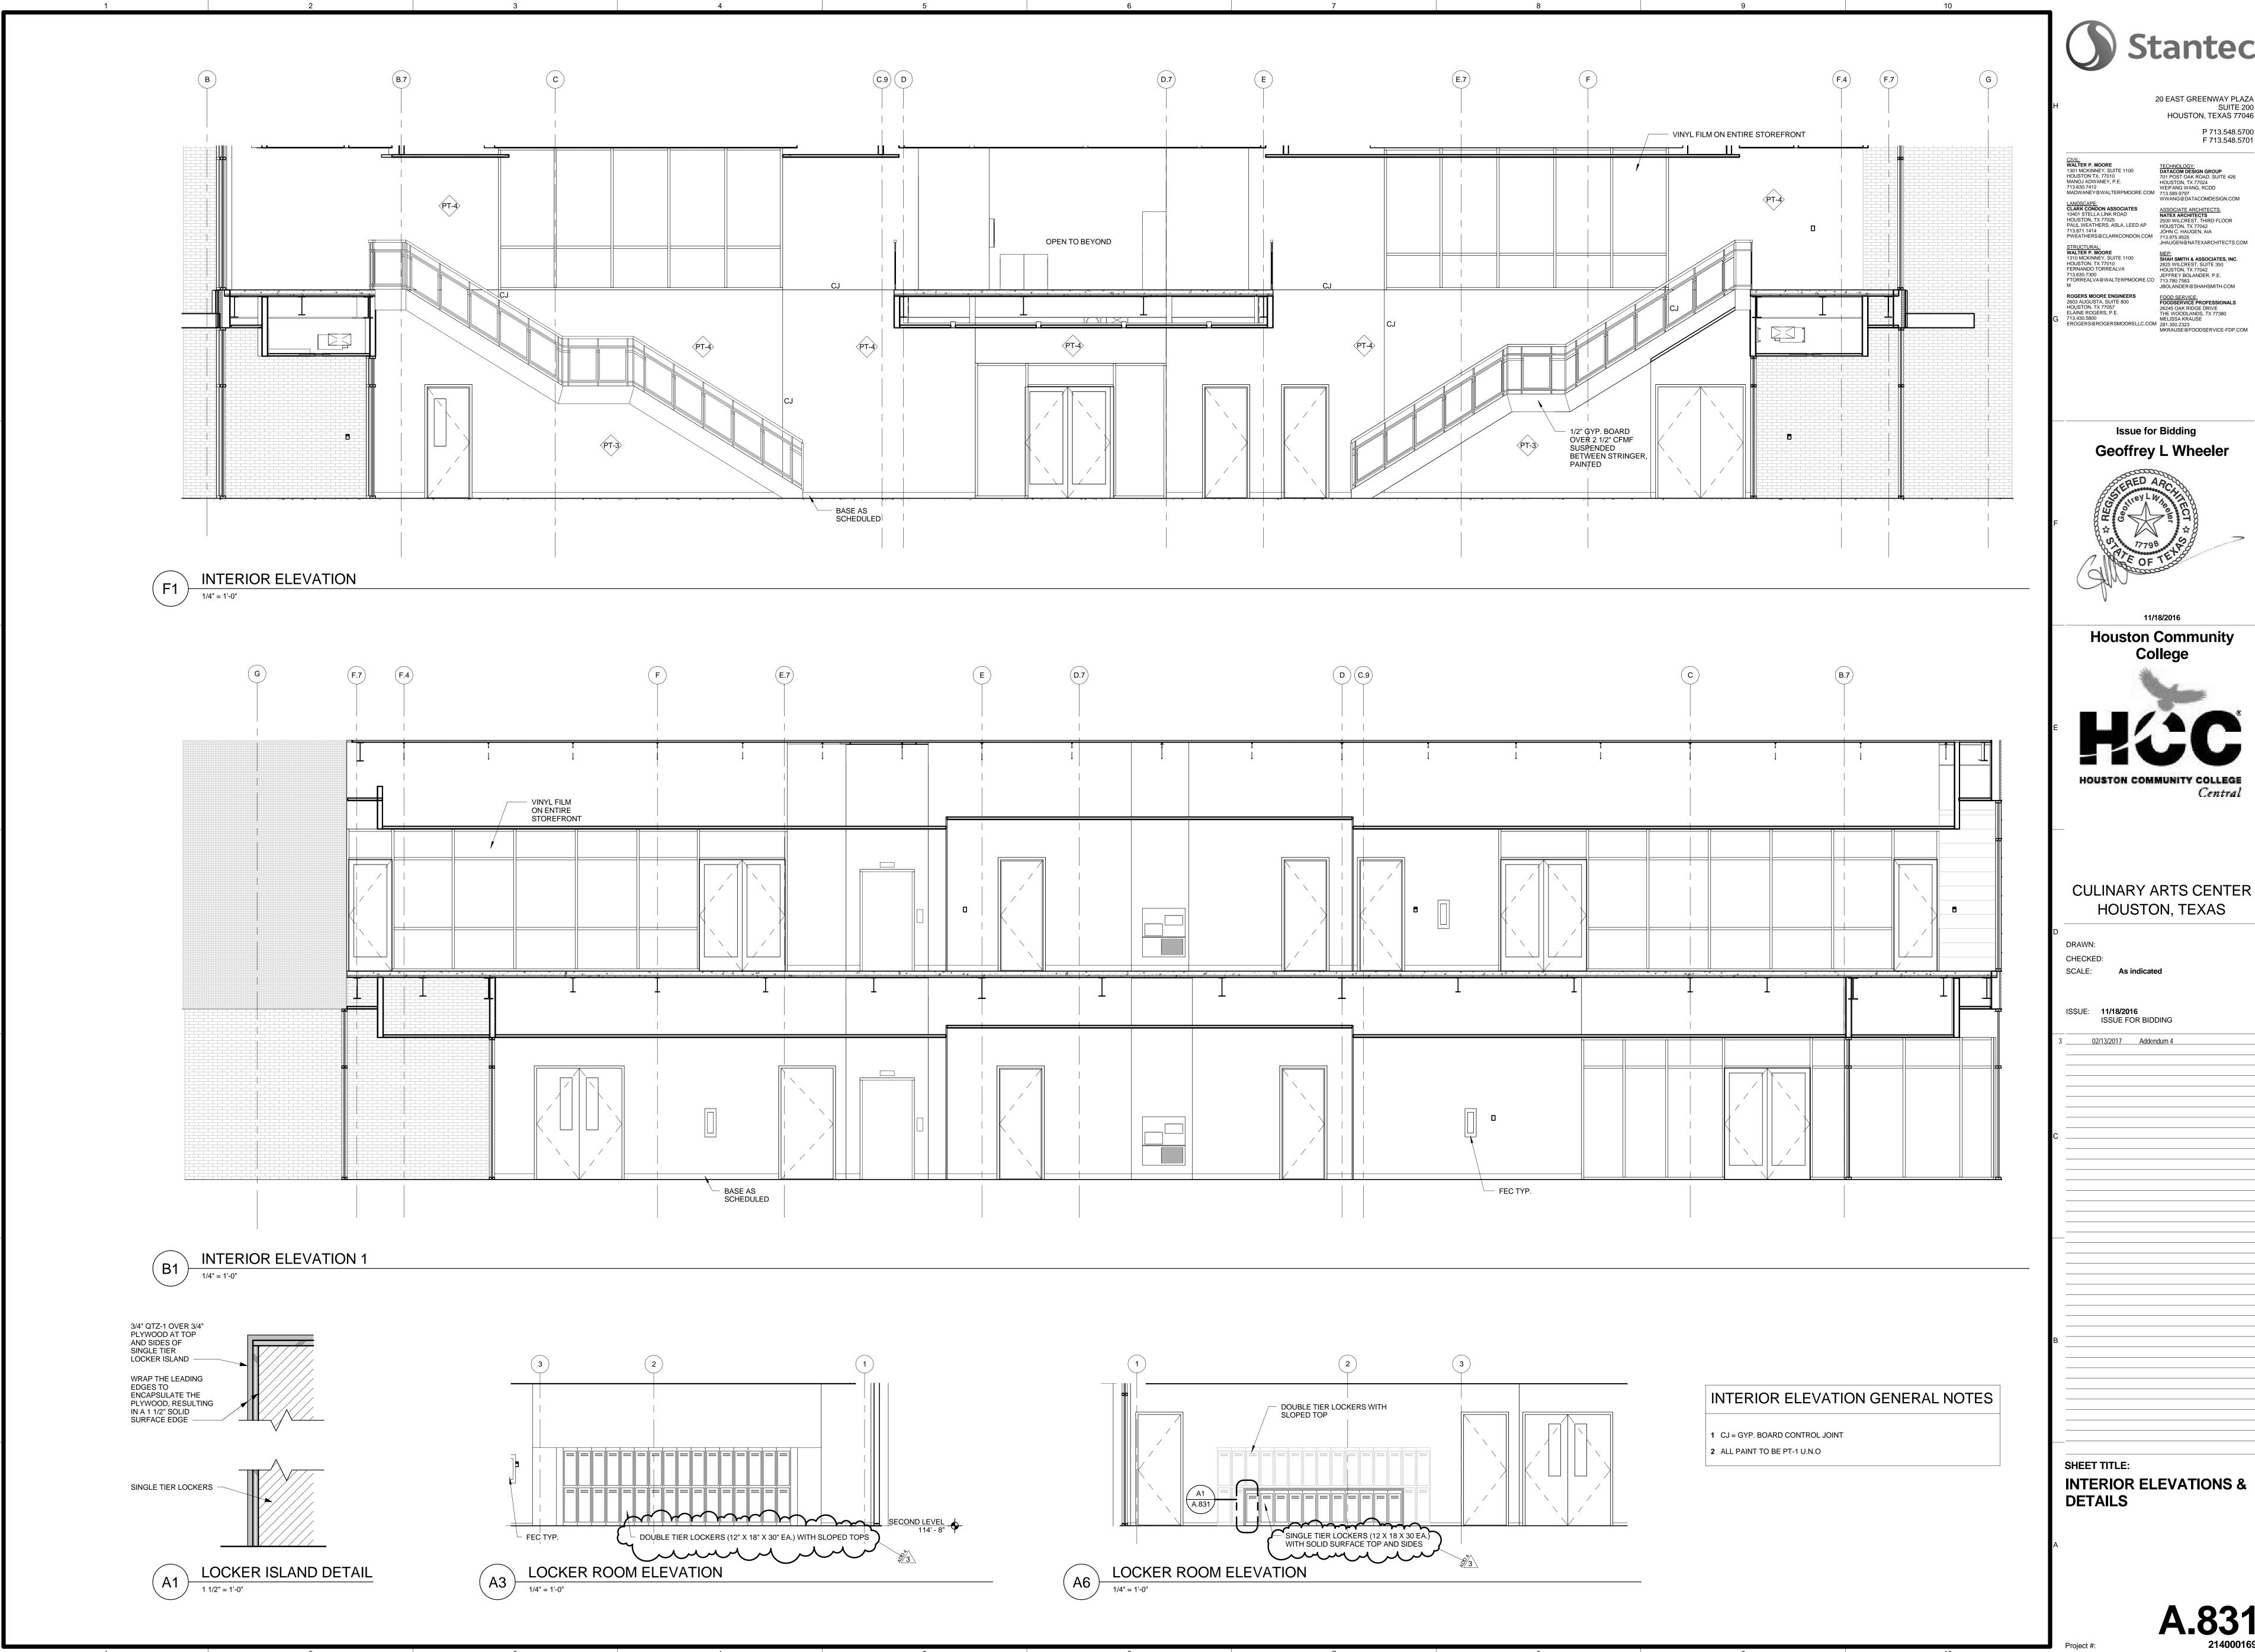



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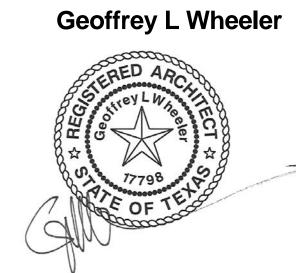
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INTERIOR ELEVATIONS & DETAILS