

# Houston Community College System

Contact: Reynaldo J. Pradia, Sr. 3100 Main Street 12th Floor **Houston, Texas 77002** reynaldo.pradia@hccs.edu T. 713.718.5168 F. 713.718.2339

#### Chancellor


Dr. Mary Spangler


#### Central College President

Dr. William W. Harmon

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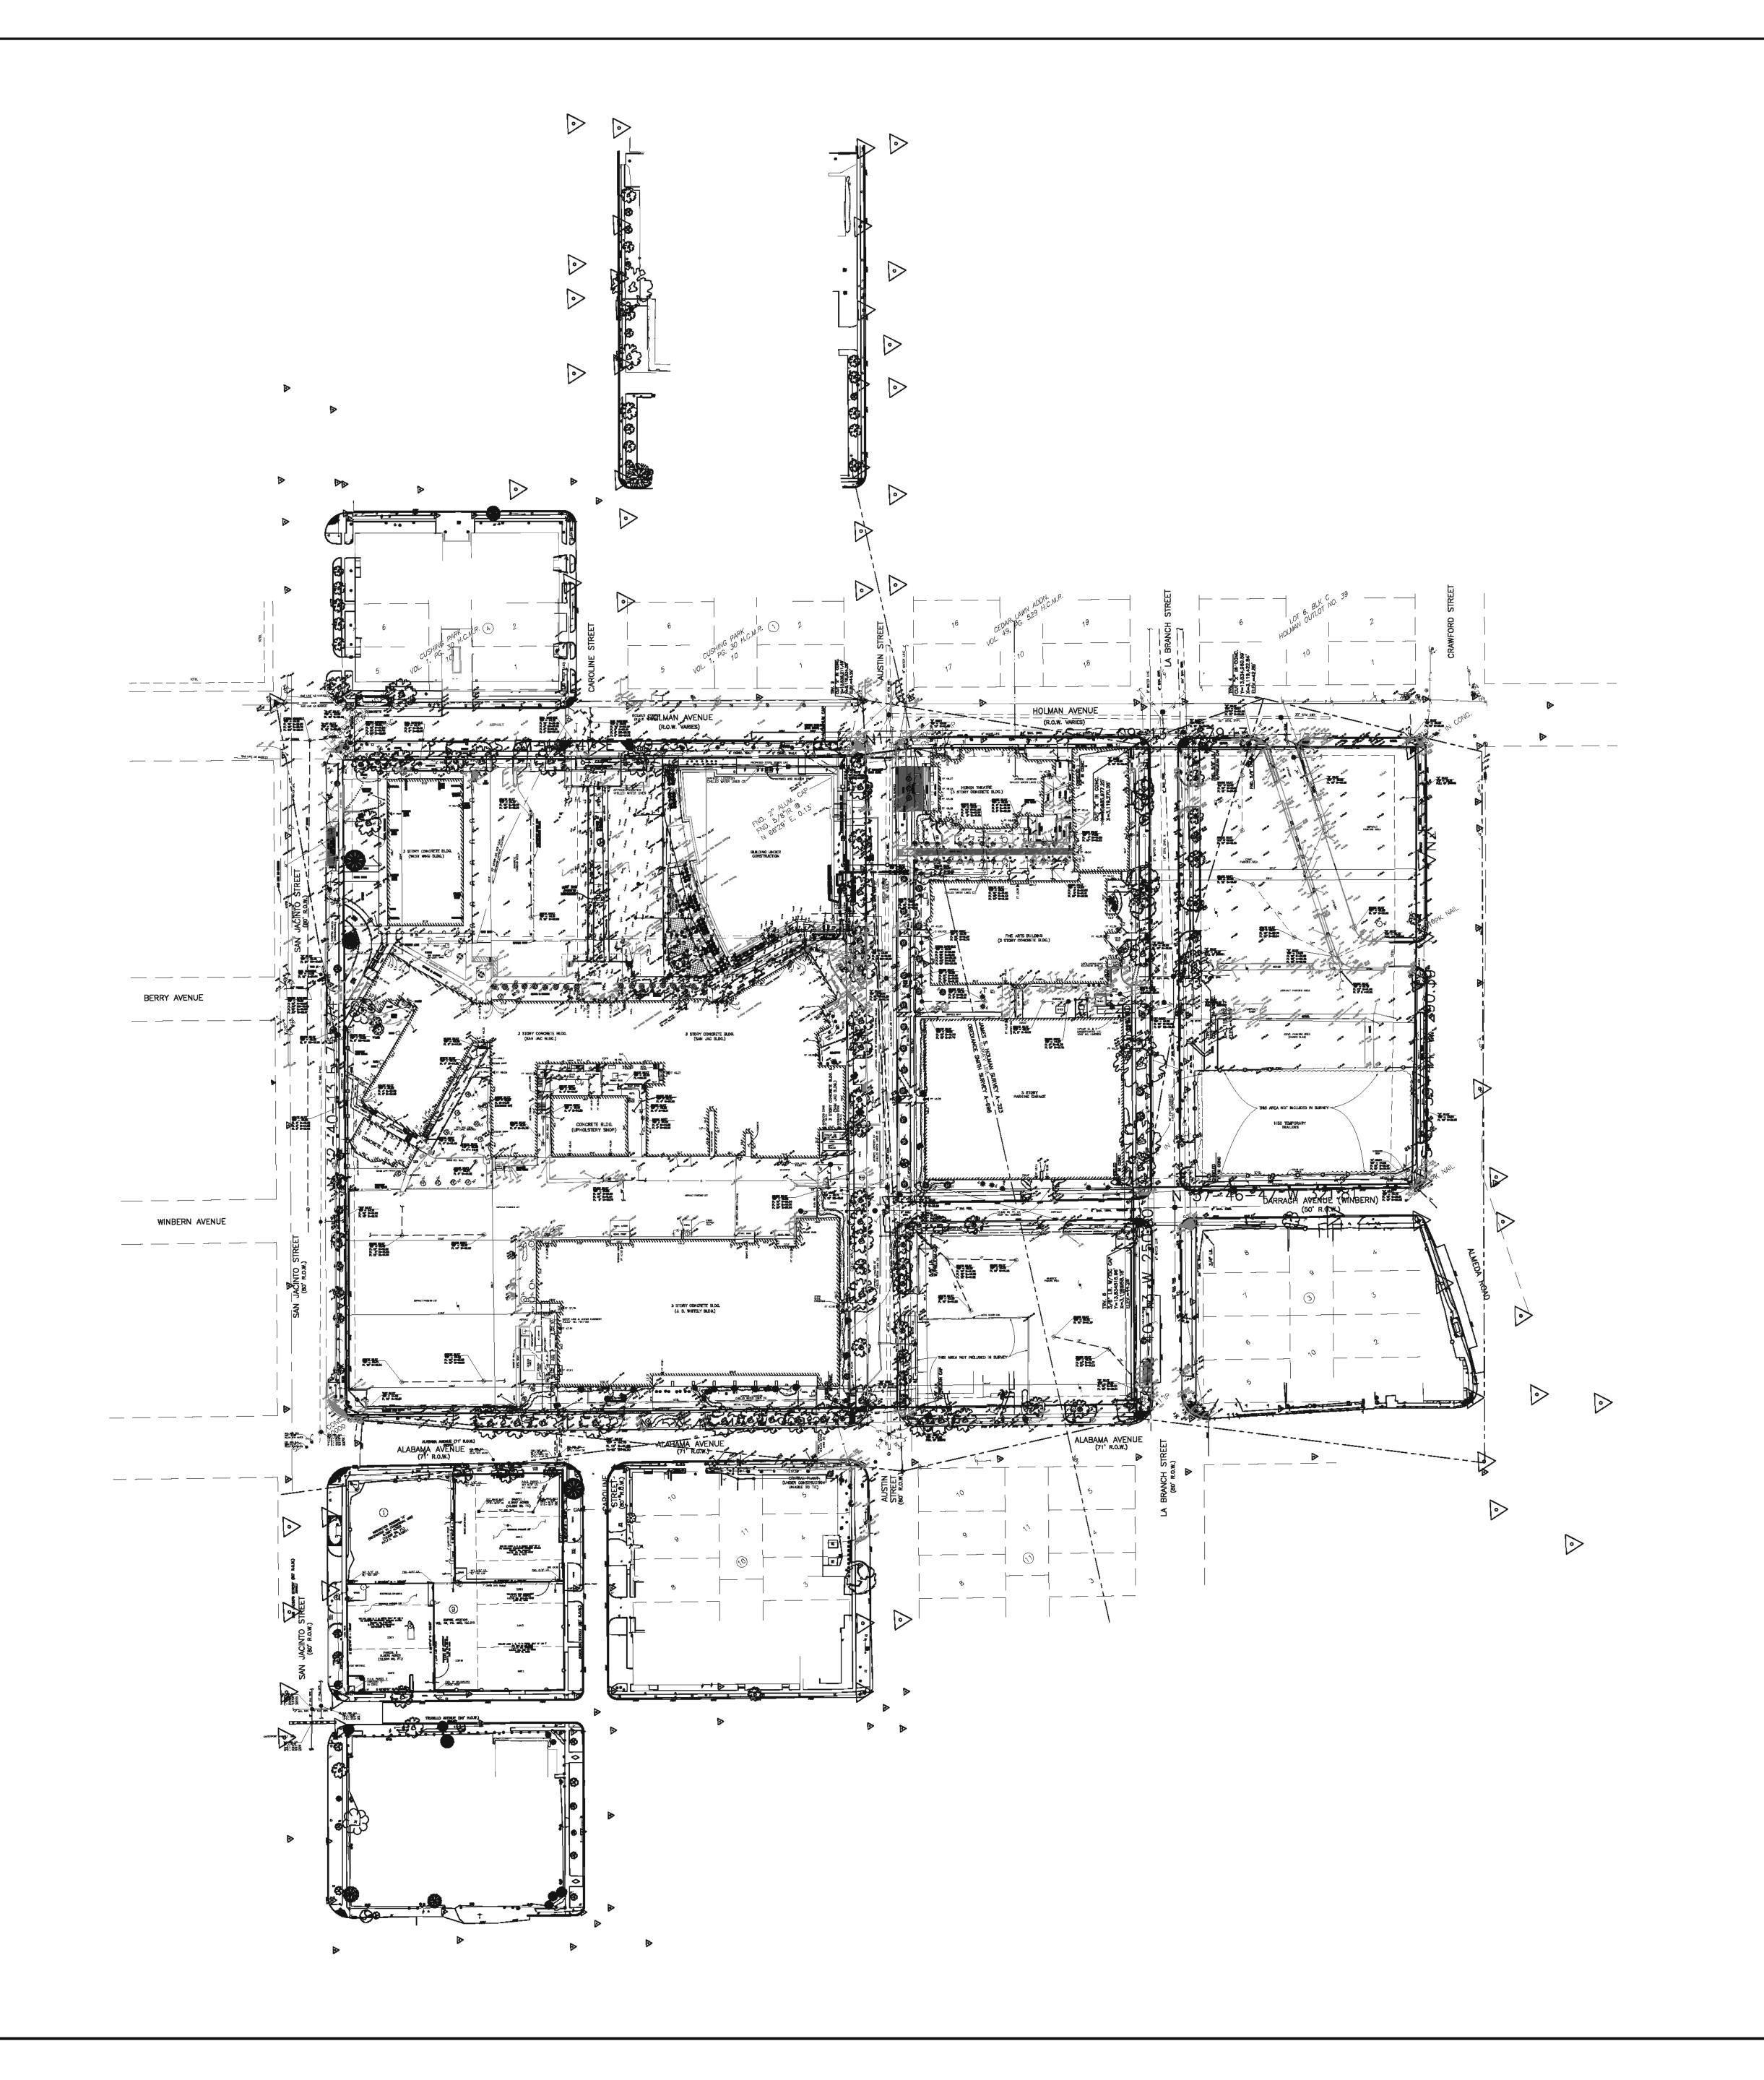
> STUDIO OF RICHARD JETER MFA LIGHTING DESIGNER 15903 PEBBLE BEND DR. HOUSTON, TEXAS 77068

E&C Engineers & Consultants Inc. 1010 Lamar, #650 Houston, Texas 77002 713.580.8800 713.580.8888 Fax

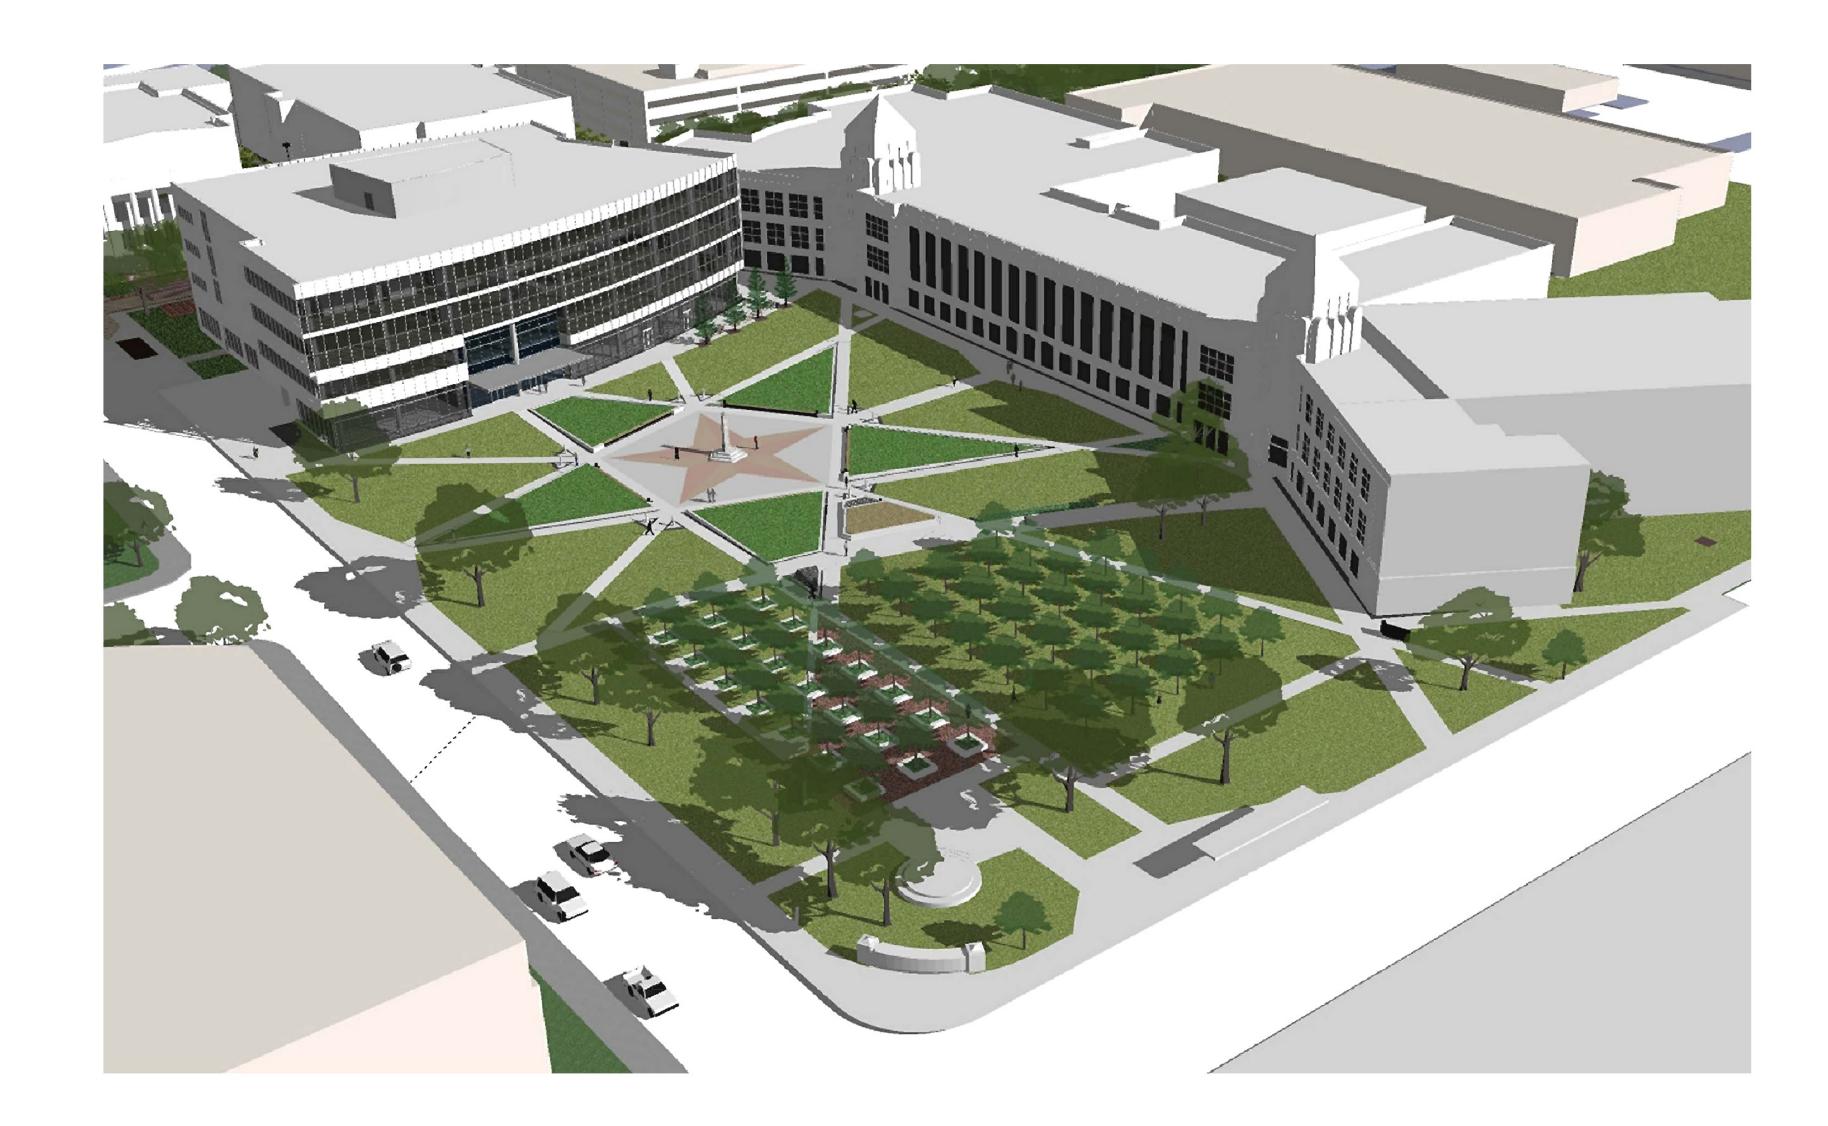**New Construction For:** 
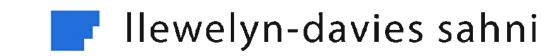
# **Central Campus**

**Issued for Bid** 





HCC - Construction Department 3100 Main, 12th Floor Houston, Texas, 77002 Voice: 713.718.5168 reynaldo.pradia@hccs.edu

Issue/Revision:				
REV	DESCRIPTION	DATE	BY	
1	ISSUED FOR BID & CONSTRUCTION	05/09/11	JA	



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STUDIO OF RICHARD JETER MFA LIGHTING DESIGNER 15903 PEBBLE BEND DR. HOUSTON, TEXAS 17063



Central Campus
Parking Lot Improvements

1300 Holman Street Houston, TX 77004

Contract No.:

Drawn By: XX

Checked By:

A/E Project No.:

Date: XX/XX/XX

Date:


Ownership of Instruments of Service:

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Survey

Scale: 1" = 80'-0"

S-001

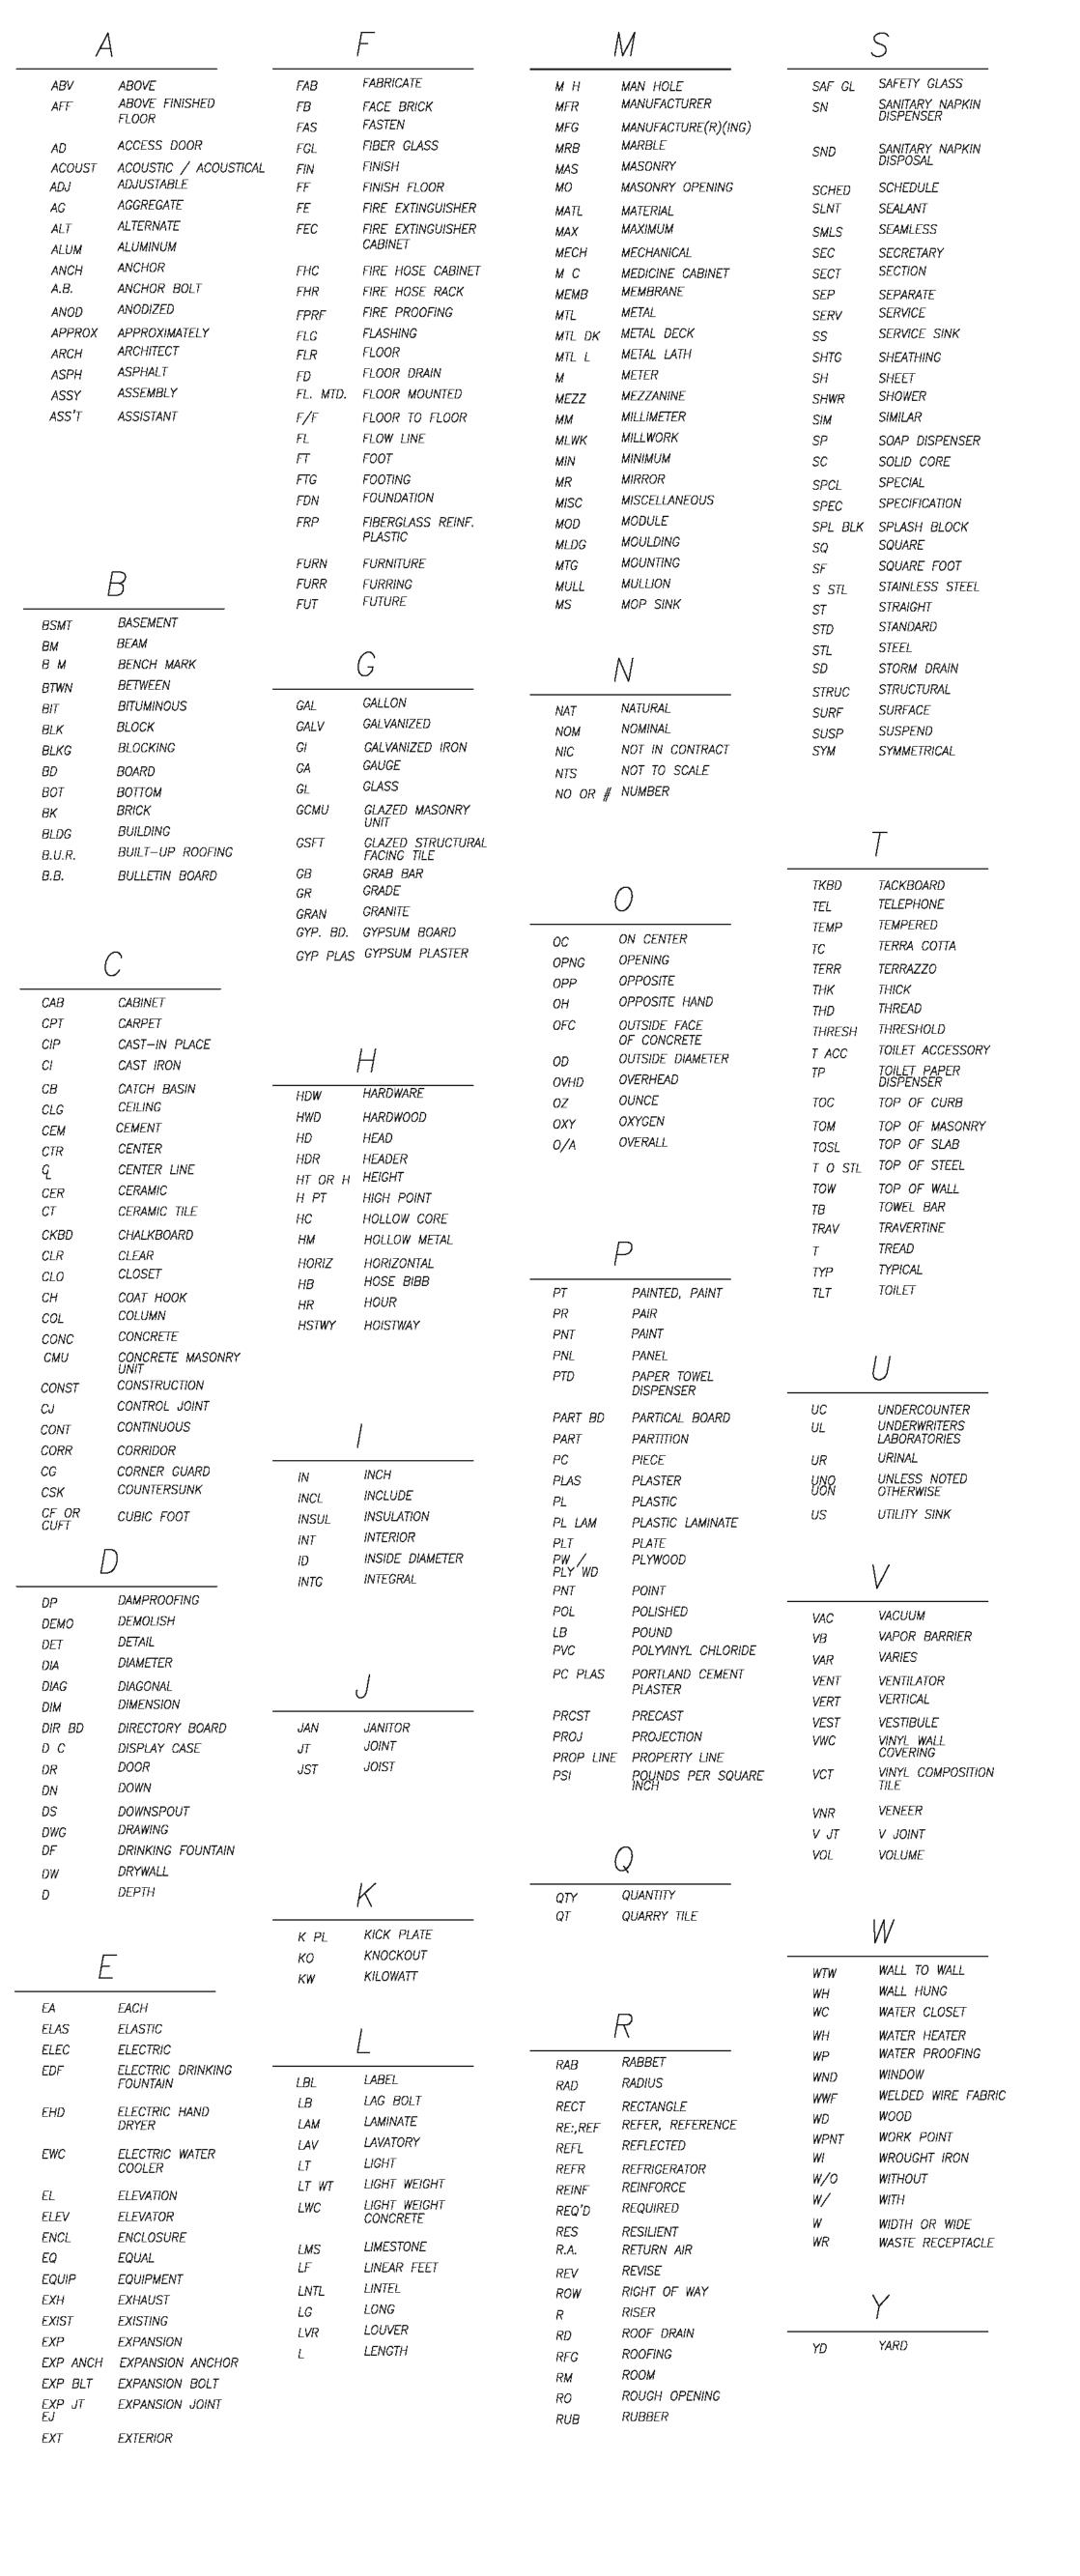

**ABBREVIATIONS** 

Scale: N.T.S

ROOM/SPACE NUMBER	124
GOOM NAME ANNADED	ADMIN
ROOM NAME/NUMBER	(A-1)
EQUIPMENT NUMBER  REVISION	$\overline{\Lambda}$
REVISION CLOUD	
EXTERIOR ELEVATION	
INTERIOR ELEVATION	TD 1 da
TEST BORING	TB−1 <b>⊕</b>
NEW OR REQUIRED POINT ELEVATION	+461.00
EXISTING POINT ELEVATION	
NEW CONTOURS (ELEV. NOTED ON HIGH SIDE)	320
EXISTING CONTOURS (ELEV. NOTED ON HIGH SIDE)	318
REFERENCE OR LEVEL LINE	25'-11" TOP OF ROOF
₩EVED NOTES	
KEYED NOTES	
COLUMN REFERENCE GRIDS	- — (A)
SECTION/DETAIL WITH SHEET REFERENCE	0 A-000
BUILDING SECTION	
WALL SECTION	A-000
PARTITION TYPE	—— A
0 A-000	
ENLARGED PLAN REFERENCE	
(A-	0
ENLARGED DETAIL REFERENCE	
	(
PLAN NORTH ARROW	
	7
TRUE NORTH	/
DOOR NUMBER	124
FLOOR LINES IN EXTERIOR ELEVATION,	
BREAK LINE	Ŋ
PROPERTY LINES, BOUNDARY TINES	
MATCH LINE	

	Scale: N.T.S		
ACOUSTICAL TIL	<u>.</u>	STONE	
BRICK		PLASTER	
CONCRETE	γ; γ σ σ σ γ γ γ γ φ σ φ σ φ σ σ σ σ σ σ σ	PLYWOOD	
CONCRETE MASONRY UNIT	s	METAL	
EARTH		TERRAZZO	
GLASS		TILE CERAMIC OR QUARRY	
GYPSUM WALL BOARD	* . * . * . * . * . * . * . * . *	WOOD BLOCKING OR SHIMS	
INSULATION BATT/BLANKET		WOOD- FINISHED	
INSULATION — RIGID		WOOD- ROUGH	
		SAND	
EQ000	EQUIPMENT IS CO CONTRACTOR INS	ONTRACTOR FURNIS TALLED	SHED/
EQ000	EQUIPMENT IS OF CONTRACTOR INS	WNER FURNISHED/ TALLED	,
EQ000	T EQUIPMENT IS OF CONTRACTOR INS	WNER FURNISHED/ TALLED	,

PROJECT SUMMARY:

DRAWING SUMMARY Scale: N.T.S

LOCATION. HCC — CENTRAL CAMPUS 1300 HOLMAN STREET HOUSTON, TX 77004

> OWNER ADDRESS: 3100 MAIN ST., 12TH FLOOR HOUSTON, TX 77002

REFER TO MAIN BUILDING CERTIFICATE OF OCCUPANCY

2003 INTERNATIONAL BUILDING CODE

CODE SUMMARY Scale: N.T.S

713.718.5168

PARKING.

**GENERAL NOTES:** 

<u>COVERSHEET</u>

S-001 SURVEY

I-1.00 GENERAL INFORMATION

LEGENDS / ABBREVIATIONS

CONSTRUCTION SEQUENCING PLAN

TOPOGRAPHIC SURVEY

DEMOLITION SITE PLAN

CIVIL GRADING PLAN

C-10.0 STORM SEWER LAYOUT

C-12.0 MISCELLANEOUS DETAILS

C-14.0 GENERAL NOTES TCP

C-15.0 HOLMAN AVENUE TCP

C-17.0 WINBERN AVENUE TCP

C-16.0 CRAWFORD AVENUE TCP

S-1.00 SITE STRUCTURAL DETAILS

AS-0.10 EXISTING SITE PLAN

AS-1.00 SITE DEVELOPMENT PLAN

AS-1.02 ARCHITECTURAL SITE PLAN

AS-1.03 ARCHITECTURAL LIGHTING PLAN

AS-6.00 SOIL AMENDMENT & TREE PROTECTION PLAN

SE-000 ELEC. SYMBOLS / ABBREVIATIONS

LANDSCAPE PLAN & DETAILS

DRAWING INDEX

GENERAL NOTE.

IRRIGATION PLAN & DETAILS

SE-100 ELEC. DEMOLITION PLAN

SE-300 ELEC. SCHEDULES

SE-301 ELEC. DETAILS

SE-200 ELEC. ALTERATION SITE PLAN

AS-1.01 SITE DEMOLITION PLAN

AS-1.04 ENLARGED SITE PLAN

AS-1.05 ENLARGED SITE PLAN

AS-1.06 ENLARGED SITE PLAN

AS-1.20 DETAIL PLANS

AS-1.21 DETAIL PLANS

AS-1.22 DETAIL PLANS

AS-6.01 SITE DETAILS AS-6.02 SITE DETAILS

<u>ELECTRICAL</u>

<u>LANDSCAPE</u>

HORIZONTAL CONTROL

DRAINAGE AREA MAP

C-1.0 GENERAL NOTES

C-6.0 CIVIL SITE PLAN

C-13.0 SWPP DETAILS

<u>SURVEY</u>

<u>CIVIL</u>

C - 5.0

C-8.0

C - 9.0

C-11.0 SWPP


<u>STRUCTURAL</u>

<u>ARCHITECTURAL</u>

PROJECT LOCATION

**GENERAL NOTES** 

VICINITY MAP

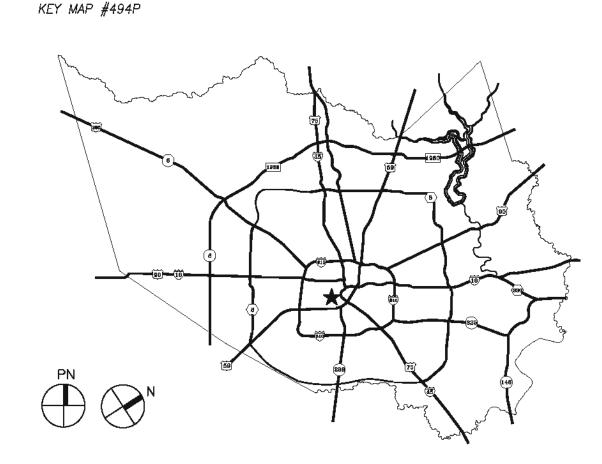




STREET MAP Scale: N.T.S

Houston Community College

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Ilewelyn-davies sahni architecture + planning + design
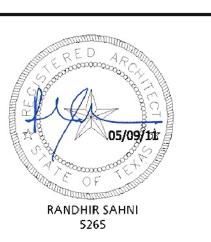
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Central Campus Parking Lot Improvements

1300 Holman Street Houston, TX 77004

Contract No.: A/E Project No.: Drawn By:

Date: XX/XX/XX Date: Approved By:


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Information

Scale: No Scale


I-1.00

MATERIAL DESIGNATIONS Scale: N.T.S

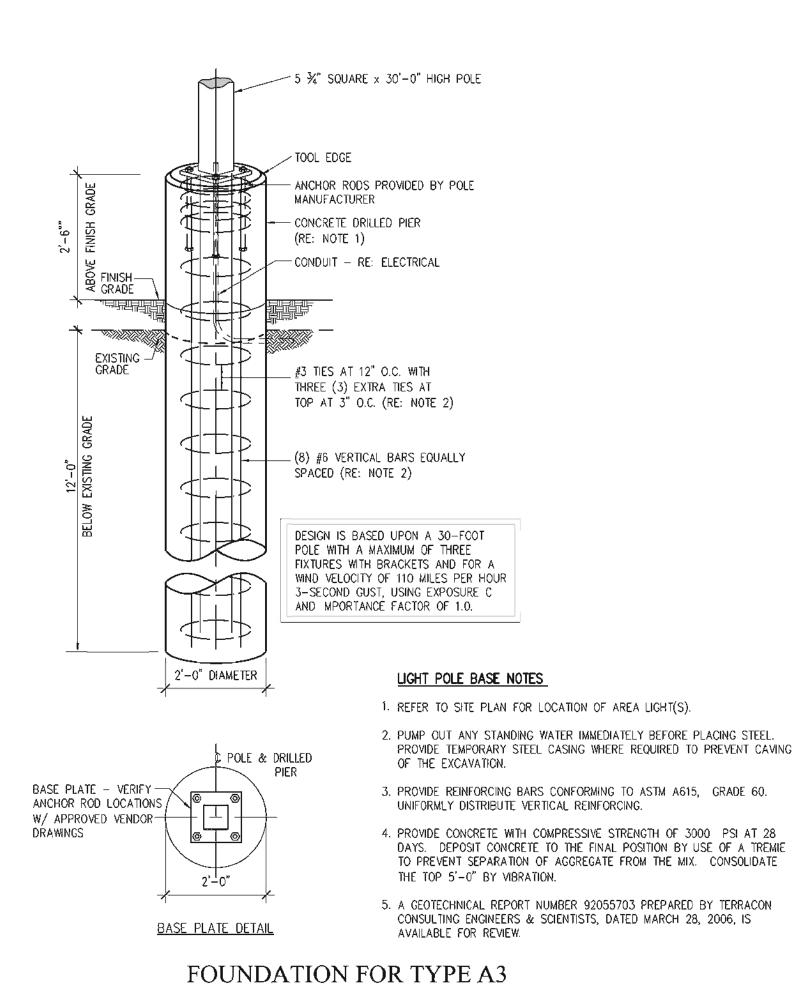

30 FT. HIGH LIGHT POLE BASE

1/2"=1'-0"

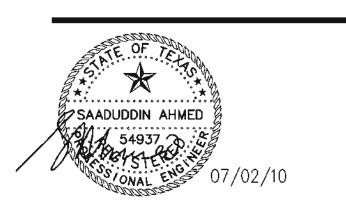

ASA DALLY Inc.
1155 Dairy Ashford #111, Houston TX 77079

CENTRAL CAMPUS
HOUSTON, TX 77004

SHEET NO.: **SK-1**DATE: JULY 02, 2010

Houston

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Site Structural Details

Scale: As Noted

S-1.00

#### CONSTRUCTION NOTES

- 1. IT SHALL BE THE RESPONSIBILITY OF THE CONTRACTOR TO NOTIFY THE LOCAL AUTHORITY OR GOVERNING AGENCY OF THE BEGINNING DATE OF CONSTRUCTION AND SHALL BE THE RESPONSIBILITY OF THE CONTRACTOR TO SEE THAT NO WORK IS DONE WITHOUT THE PROPER INSPECTIONS AND PERMITS BY THE LOCAL AUTHORITY OR GOVERNING AGENCY.
- 2. THE CONTRACTOR WILL BE RESPONSIBLE FOR APPLYING FOR AND PAYING FOR ALL PERMITS AND APPROVALS UNLESS NOTIFIED OTHERWISE.
- 3. ANY POWER POLES, SIGNS, VALVES, ETC. THAT ARE LOCATED IN AN AREA DESIGNATED FOR CONSTRUCTION SHALL BE REMOVED AND/OR RELOCATED AS DIRECTED BY AGENCY HAVING JURISDICTION OVER SUCH ITEMS UNLESS NOTED OTHERWISE. COST FOR SUCH ITEMS SHALL BE PART OF CONTRACT BID PRICE.
- 4. ALL BRUSH, ORGANIC TOPSOIL AND OTHER OBJECTIONABLE MATERIAL SHALL BE REMOVED AND DISPOSED OF AT AN OFF-SITE LOCATION. ADDITIONAL SUITABLE FILL MATERIAL SHALL BE BROUGHT ONTO THE SITE, IF NECESSARY. AREAS WHICH ARE TO BE FILLED SHALL BE COMPACTED IN ACCORDANCE WITH THE SOILS REPORT.
- 5. THE CONTRACTOR SHALL VERIFY THE DIMENSIONS SHOWN ON THE CONSTRUCTION PLANS WITH THOSE MEASURED IN THE FIELD PRIOR TO COMMENCING CONSTRUCTION. ANY DISCREPANCIES SHALL BE BROUGHT TO THE ATTENTION OF THE ENGINEER IMMEDIATELY
- 6. EXISTING UNDERGROUND FACILITIES HAVE BEEN PLOTTED FROM AVAILABLE SURVEYS AND PLANS PROVIDED TO ESPA CORP. THEREFORE THEIR LOCATION MUST BE CONSIDERED APPROXIMATE ONLY. VERIFICATION, SUCH AS LOCATION AND ELEVATION, OF EACH FACILITY SHOWN OR NOT SHOWN, SHALL BE THE RESPONSIBILITY OF THE CONTRACTOR, PRIOR TO COMMENCING CONSTRUCTION.
- 7. AT LEAST 48 HOURS BEFORE EXCAVATING IN STREET RIGHT-OF-WAY OR EASEMENTS, CALL UTILITY COORDINATING COMMITTEE (1-800-245-4545) OR DIG-TESS AT 1-800-344-8377.
- 8. THIS SITE IS NOT WITHIN THE 100-YEAR FLOOD PLAIN.
- 9. CONTRACTOR SHALL NOTIFY THE CITY OF HOUSTON, DEPARTMENT OF PUBLIC WORKS AND ENGINEERING, ENGINEERING CONSTRUCTION DIVISION (TELEPHONE NO. 713/863-1450) 48 HOURS BEFORE STARTING WORK ON THIS PROJECT.

#### UTILITY NOTES

- 1. ALL TRENCHES UNDER PROPOSED PAVEMENT SHALL BE BACKFILLED TO SUBGRADE ELEVATION WITH COMPACTED APPROVED GRANULAR MATERIALS. IF USED IN LANDSCAPE OR GRASS AREAS, BACKFILL TO A POINT ONE FOOT BELOW FINISHED GRADE WITH THE REMAINDER BEING HAND TAMPED EXCAVATED SOIL.
- 2. IT SHALL BE THE DUTY AND RESPONSIBILITY OF THE CONTRACTOR AND ALL OF ITS SUBCONTRACTORS TO BE FAMILIAR AND COMPLY WITH ALL REQUIREMENTS OF PUBLIC LAW 91-596, 29 U.S.C. SECS. 651 ET. SEQ., THE OCCUPATIONAL SAFETY AND HEALTH ACT OF 1970, (OSHA) AND ALL AMENDMENTS THERETO, AND TO ENFORCE AND COMPLY WITH ALL OF THE PROVISIONS OF THIS ACT.
- 3. BEFORE COMMENCING ANY TRENCH EXCAVATION WHICH WILL EXCEED DEPTH OF FIVE (5) FEET, CONTRACTOR WILL PROVIDE OWNER WITH DETAILED PLANS AND SPECIFICATIONS REGARDING THE SAFETY SYSTEMS TO BE UTILIZED. SAID PLANS AND SPECIFICATIONS SHALL INCLUDE A CERTIFICATION FROM A REGISTERED PROFESSIONAL ENGINEER INDICATING FULL COMPLIANCE WITH THE OSHA PROVISIONS NOTED ABOVE.
- 4. ESPA CORP SHALL NOT BE HELD LIABLE OR OTHERWISE RESPONSIBLE FOR ANY INJURIES, LOSSES OR DAMAGE RESULTING FROM CONSTRUCTION.
- 5. WATER LINES, WASTEWATER COLLECTION SYSTEMS AND DRAINAGE SYSTEMS SHALL BE CONSTRUCTED IN ACCORDANCE WITH THE CITY OF HOUSTON, DEPARTMENT OF PUBLIC WORKS AND ENGINEERING'S "STANDARD CONSTRUCTION SPECIFICATIONS," LATEST REVISION, AND STANDARD CONSTRUCTION DETAILSFOR WASTEWATER COLLECTION SYSTEMS, WATER LINES, STORM DRAINAGE AND STREET PAVING "DATED OCTOBER 2002 WITH ALL SUBSEQUENT AMENDMENTS ADDED THERETO UNLESS OTHERWISE NOTED AND APPROVED ON THESE PLANS.
- 6. THE CONTRACTOR SHALL BE FULLY RESPONSIBLE FOR ANY AND ALL DAMAGE TO THE EXISTING PUBLIC OR PRIVATE PAVEMENTS AND UTILITY LINES, INCLUDING BUT NOT LIMITED TO PAVING, WATER LINES, WASTEWATER COLLECTION SYSTEMS AND STORM SEWERS, DURING CONSTRUCTION. ALL DAMAGES SHALL BE REPAIRED IN ACCORDANCE WITH THE CITY OF HOUSTON, DEPARTMENT OF PUBLIC WORKS AND ENGINEERING "STANDARD CONSTRUCTION SPECIFICATIONS" WITH LATEST ADDENDA AND AMENDMENTS THERETO, WITH NO COST TO THE THE OWNER.
- 7. THIS PROJECT IS SUBJECT TO CITY OF HOUSTON STREET CUT ORDINANCE.

#### PAVING CONSTRUCTION NOTES

OWNER, NO SEPARATE PAY.

- 1. ALL ROAD WIDTHS, CURB RADII, AND CURVE ALIGNMENT SHOWN INDICATE BACK OF CURB OR EDGE OF PAVEMENT IF THERE IS NO CURB. ELEVATIONS SHOWN INDICATE TOP OF CURB ELEVATIONS ON CURBED STREETS, OR TOP OF PAVEMENT ELEVATION ON NON-CURBED STREETS.
- 2. ALL CURB RADII TO VARY TO FACE OF CURB IN ACCORDANCE WITH THE PLANS WITH A MINIMUM ONE (1%) PERCENT GRADE, UNLESS OTHERWISE NOTED. FOR MACHINE—LAID CURB, OMIT MORTAR FINISH BUT MAINTAIN SAME OUTSIDE DIMENSIONS.
- 3. GUIDELINES SET FORTH IN THE TEXAS MANUAL ON UNIFORM TRAFFIC CONTROL DEVICES SHALL BE OBSERVED.
- 4. CURBS ARE TO BE 6-INCH CONCRETE CURBS, UNLESS OTHERWISE NOTED.
- 5. CONCRETE PAVEMENT TO BE MINIMUM 5 SACK MIX. REINFORCING STEEL TO CONFORM TO ASTM A-615, GRADE 60, INCLUDING CRSI 63 AND 65, PROVIDE 15-INCH LAP.
- 6. PAVING SUBGRADE PREPARATION SHALL INCLUDE LIME STABILIZATION IN ALL AREAS.
- REFER TO SOIL REPORT.

  7. PAVING CONTRACTOR TO PROTECT WATER, SEWER AND DRAINAGE FACILITIES AND WILL REPLACE AT HIS EXPENSE ANY FACILITIES DAMAGED DURING PAVING OPERATIONS. ALL MANHOLES AND VALVES FALLING WITHIN PAVEMENT ARE TO BE ADJUSTED TO FINISHED

GRADE BY PAVING CONTRACTOR WITHOUT THE USE OF BLOCKOUTS, WHEN DIRECTED BY

8. SUITABLE ROADWAY EXCAVATION SHALL BE PLACED IN FILL AREAS DESIGNATED BY THE OWNER AND COMPACTED IN MAXIMUM 8—INCH LAYERS TO 95% STANDARD PROCTOR DENSITY AT OPTIMUM MOISTURE CONTENT OR DISPOSED OF AS DIRECTED BY OWNER. CONTRACTOR SHALL REMOVE MUCK AND UNSUITABLE MATERIAL FROM FILL AREAS PRIOR TO PLACING FILL. SURPLUS EXCAVATED MATERIAL AND UNSUITABLE MATERIAL SHALL BE DISPOSED OF AS DIRECTED BY OWNER. ROADWAY FILL SHALL BE SUITABLE MATERIAL PLACED AND COMPACTED IN ACCORDANCE WITH THE GEOTECHNICAL REPORT. MATERIAL WHICH CAN NOT BE COMPACTED TO THE REQUIRED DENSITY SHALL BE REMOVED AND

REPLACED WITH ACCEPTABLE MATERIAL THAT WILL MEET THE SPECIFIED REQUIREMENTS.

#### STORM SEWER CONSTRUCTION NOTES

- 1. STORM SEWERS WITHIN THE CITY RIGHT-OF-WAY SHALL BE REINFORCED CONCRETE PIPE, C-76, CLASS III, AND SHALL BE INSTALLED, BEDDED, AND BACKFILLED IN ACCORDANCE WITH CITY OF HOUSTON DRAWING NOS. 02317-03, 02317-04, 02317-09, AS APPLICABLE, UNLESS SHOWN OTHERWISE ON DRAWINGS.
- 2. ALL PROPOSED PIPE STUB OUTS FROM MANHOLES OR INLETS ARE TO BE PLUGGED WITH 8-INCH BRICK UNLESS OTHERWISE NOTED.
- 3. CONTRACTOR TO USE NYLOPLAST DRAIN CATCH BASIN FOR COVER CLEARANCES LESS THAN 1 FOOT. 12" DRAIN CATCH BASINS WILL BE USED WITH ALL HDPE/PVC BODIES AND INLET AND OUTLET ADAPTERS 6" THROUGH 12". STANDARD GRATES WITH H-20 HEAVY DUTY RATING SHALL BE USED AND MATERIAL SHALL CONFORM TO ASTM A48-CLASS 30B, CAST IRON. CASTINGS TO BE FURNISHED WITH BLACK PAINT AND A LOCKING DEVICE WILL BE INSTALLED PER DRAIN CATCH BASIN INLET GRATE.
- 4. ALL SEWER TRENCHES, INCLUDING TRENCHES FOR LEADS AND STUBS, SIZES 48—INCH DIAMETER AND SMALLER, UNDER PAVEMENT AND TO A POINT 1—FOOT BACK OF ALL CURBS SHALL BE BACKFILLED WITH CEMENT—STABILIZED SAND AS PER SPECIFICATIONS, TO A POINT IMMEDIATELY BELOW THE SUBGRADE TREATMENT. THE REMAINING DEPTH OF TRENCH SHALL BE BACKFILLED WITH SUITABLE EARTH MATERIAL IN 6—INCH LAYERS AND MECHANICALLY COMPACTED TO A DENSITY OF NOT LESS THAN 95 PERCENT OF THE MAXIMUM DRY DENSITY AS DETERMINED BY THE STANDARD PROCTOR COMPACTION TEST (ASTM DESIGNATION D—698, AASHTO T99). MOISTURE CONTENT OF BACKFILL SHALL BE IN ACCORDANCE WITH THE REQUIREMENTS OF THE CEMENT STABILIZED SAND SPECIFICATION.

#### SWPPP CONSTRUCTION NOTES

- 1. CONTRACTOR SHALL INPLEMENT INLET PROTECTION DEVICES AND REINFORCED FILER FABRIC BARRIER ALONG ROAD AND SIDE DITCHES AT LOCATIONS SHOWN ON THE TYPICAL STORM WATER POLLUTION PREVENTION (SWPPP) PLANS TO KEEP SILT AND OR EXCAVATED MATERIAL FROM
- 2. ENTERING INTO THE STORM WATER INLETS AND DITCHES EVENTUALLY POLLUTING THE RECEIVING STORM.
- DURING THE EXCAVATION PHASE OF THE PROJECT. CONTRACTOR SHALL SCHEDULE THE WORK IN SHORT SEGMENTS SO THAT EXCAVATION MATERIAL CAN BE QUICKLY HAULED AWAY FROM THE SITE AND TO PREVENT IT FROM STAYING UNCOLLECTED ON THE EXISTING PAVEMENT. ANY LOOSE EXCAVATED
- MATERIAL WHICH FALLS ON PAVEMENTS OR DRIVEWAYS SHALL BE SWEPT BACK INTO THE EXCAVATED AREA.
- CONTRACTOR SHALL CLEAN UP THE EXISTING STREET INTERSECTIONS AND DRIVEWAYS DAILY, AS NECESSARY, TO REMOVE ANY EXCESS MUD, SILT OR 5. ROCK TRACKED FORM THE EXCAVATED AREA.
- CONTRACTOR SHALL FOLLOW GOOD HOUSEKEEPING PRACTICES DURING THE CONSTRUCTION OF THE PROJECT, ALWAYS CLEANING UP DIRT AND LOOSE MATERIAL AS CONSTRUCTION PROGRESSES.
- 6. CONTRACTOR TO INSPECT AND MAINTAIN THE AREAS LISTED BELOW AT LEAST ONCE EVERY FOURTEEN (14) CALENDER DAYS AND WITHIN 24 HOURS OF THE END OF A STORM EVENT OF 0.5 INCHES OR GREATER.

  \* DISTURBED AREAS OF THE CONSTRUCTION SITE THAT HAVE NOT BEEN FINALLY STABILIZED.

  \* AREAS USED FOR STORAGE OF MATERIALS THAT ARE EXPOSED TO PRECIPITATION.
- \* STRUCTURAL CONTROL MEASURES.
  \* LOCATIONS WHERE VEHICLES ENTER OR EXIT THE SITE.
- CONTRACTOR TO BE RESPONSIBLE TO MAINTAIN EXISTING DITCHES AND OR CULVERTS FOR UNOBSTRUCTED DRAINAGE AT ALL TIMES. WHERE SODDING IS DISTURBED BY EXCAVATION ON BACKFILLING OPERATIONS, SUCH AREAS SHALL BE REPLACED BY SEEDING OR SODDING. SLOPES 4:1 OR STEEPER SHALL BE REPLACED BY BLOCK SODDING.

#### TRAFFIC NOTES

- CONTRACTOR SHALL PROVIDE AND INSTALL TRAFFIC CONTROL DEVICES IN CONFORMANCE WITH PART VI OF THE TEXAS MANUAL ON UNIFORM TRAFFIC CONTROL DEVICES (TEXAS MUTCD, MOST RECENT EDITION WITH REVISIONS) DURING CONSTRUCTION.
- 2. NOT USED.
- 3. CONTRACTOR SHALL MAINTAIN TRAFFIC LANE(S) ACCORDING TO TRAFFIC CONTROL PLAN(S) DURING WORKING HOURS.
- 4. CONTRACTOR SHALL COVER OPEN EXCAVATIONS WITH STEEL PLATES ANCHORED PROPERLY DURING NON-WORKING HOURS, AND OPEN LANES FOR NORMAL TRAFFIC WHEN LANES ARE BLOCKED.
- 5. OFF DUTY UNIFORMED POLICE OFFICER(S)/FLAGGER(S) IS/ARE REQUIRED TO DIRECT TRAFFIC WHEN LANES ARE BLOCKED.
- 6. IN THE EVENT WHEN NO "TRAFFIC CONTROL PLANS" EXIST AS PART OF CONTRACT DRAWINGS, CONTRACTOR MAY PREPARE THE PLANS\* AND SUBMIT TO TRAFFIC AND SIGNAL ENGINEERING SECTION, FOR APPROVAL TEN WORKING DAYS PRIOR TO IMPLEMENTATION.
- \*THESE PLANS SHALL BE DRAWN TO SCALE ON REPRODUCIBLE MYLARS AND SEALED BY A LICENSED ENGINEER IN THE STATE OF TEXAS. PLANS WILL BECOME A PART OF THE CONTRACT DRAWINGS.
- 7. APPROVED COPIES OF "TRAFFIC CONTROL PLANS" AND LANE/SIDEWALK CLOSURE SHALL BE AVAILABLE FOR INSPECTION AT JOB AT ALL TIMES. CONTRACTOR MUST SECURE"LANE/SIDEWALK CLOSURE PERMIT" FROM CITY'S TRAFFIC MANAGEMENT AND MAINTENANCE BRANCH BEFORE CLOSING A LANE/SIDEWALK. THE REQUEST MUST BE MADE AT LEAST THREE BUSINESS DAYS PRIOR TO THE DATE FOR WHICH THE CLOSURE IS SOUGHT. NOTE THAT WORKING HOURS MAY BE RESTRICTED OR THE REQUEST MAY BE DENIED. CALL CALL 713-837-7280 FOR AN APPLICATION.

#### AT&T NOTES

- THE LOCATION OF AT&T FACILITIES ARE SHOWN IN AN APPROXIMATE WAY ONLY. THE CONTRACTOR SHALL DETERMINE THE EXACT LOCATION BEFORE COMMENCING WORK. HE AGREES TO BE FULLY RESPONSIBLE FOR ANY AND ALL DAMAGES WHICH MIGHT BE OCCASIONED BY THIS FAILURE TO EXACTLY LOCATE AND PRESERVE THESE UNDERGROUND UTILITIES.
- 2. THE CONTRACTOR SHALL CALL 1-800-344-8377 A MINIMUM OF 72 HOURS PRIOR TO CONSTRUCTION TO HAVE UNDERGROUND LINES FIELD LOCATED.
- 3. WHEN EXCAVATING WITHIN EIGHTEEN INCHES (18") OF THE INDICATED LOCATION OF AT&T FACILITIES, ALL EXCAVATIONS MUST BE ACCOMPLISHED USING NON-MECHANIZED EXCAVATION PROCEDURES. WHEN BORING THE CONTRACTOR SHALL EXPOSE THE AT&T
- 4. WHEN AT&T FACILITIES ARE EXPOSED, THE CONTRACTOR SHOULD PROVIDE SUPPORT TO PREVENT DAMAGE TO THE CONDUIT DUCTS OR CABLES. WHEN EXCAVATING NEAR TELEPHONE POLES THE CONTRACTOR SHALL BRACE THE POLE FOR SUPPORT.

#### CENTERPOINT ENERGY NOTES

#### CAUTION: UNDERGROUND GAS FACILITIES

LOCATIONS OF CENTERPOINT ENERGY MAIN LINES (TO INCLUDE UNIT GAS TRANSMISSION AND/OR INDUSTRIAL GAS SUPPLY CORPORATION WHERE APPLICABLE) ARE SHOWN IN AN APPROXIMATE LOCATION ONLY. SERVICE LINES ARE USUALLY NOT SHOWN. THE CONTRACTOR SHALL CONTACT THE UTILITY COORDINATING COMMITTEE AT (713)223-4567 OR 1-800-669-8344 A MINIMUM OF 48 HOURS PRIOR TO CONSTRUCTION TO HAVE MAIN AND SERVICE LINES FIELD LOCATED.

- WHEN CENTERPOINT ENERGY PIPE LINE MARKINGS ARE NOT VISIBLE, CALL
   (713)967-8037 (7:00 A.M. TO 4:30 P.M.) FOR STATUS OF LINE LOCATION REQUEST
   BEFORE EXCAVATION BEGINS.
- WHEN EXCAVATING WITHIN EIGHTEEN INCHES (18") OF THE INDICATED LOCATION OF CENTER POINT ENERGY FACILITIES, ALL EXCAVATION MUST BE ACCOMPLISHED USING NON-MECHANIZED EXCAVATION PROCEDURES.
- WHEN CENTERPOINT ENERGY FACILITIES ARE EXPOSED, SUFFICIENT SUPPORT MUST BE PROVIDED TO THE FACILITIES TO PREVENT EXCESSIVE STRESS ON THE PIPING.

THE CONTRACTOR IS FULLY RESPONSIBLE FOR ANY DAMAGES CAUSED BY HIS FAILURE TO EXACTLY LOCATE AND PRESERVE THESE UNDERGROUND FACILITIES.

CENTERPOINT ENERGY ASSUMES NO RESPONSIBILITY FOR THE OWNERSHIP FOR OR THE ACCURACY OF THE ABANDONED GAS LINES SHOWN ON THESE PLANS. THE CONTRACTOR SHALL NOTIFY CENTERPOINT ENERGY AT (713)-672-4816 AFTER EXPOSING ANY ABANDONED OR ACTIVE GAS LINES. THE GAS LINES SHALL NOT BE DISTURBED BY THE CONTRACTOR UNTIL CENTERPOINT ENERGY HAS VERIFIED THE STATUS OF THE LINE.


#### WARNING: OVERHEAD ELECTRICAL FACILITIES

OVERHEAD LINES MAY EXIST ON THE PROPERTY. WE HAVE NOT ATTEMPTED TO MARK THOSE LINES SINCE THEY ARE CLEARLY VISIBLE, BUT THE CONTRACTOR SHOULD LOCATE THEM PRIOR TO BEGINNING ANY CONSTRUCTION. TEXAS LAW, SECTION 752, HEALTH & SAFETY CODE, FORBIDS ALL ACTIVITIES IN WHICH PERSONS OR THINGS MAY COME WITHIN SIX (6) FEET OF LIVE OVERHEAD HIGH VOLTAGE LINES. PARTIES RESPONSIBLE FOR THE WORK, INCLUDING CONTRACTORS, ARE LEGALLY RESPONSIBLE FOR THE SAFETY OF CONSTRUCTION WORKERS UNDER THIS LAW. THIS LAW CARRIES BOTH CRIMINAL AND CIVIL LIABILITY. TO ARRANGE FOR LINES TO BE TURNED OFF OR REMOVED CALL CENTER POINT ENERGY AT 713-207-2222.



#### Houston Community College


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281-759-1513 ph

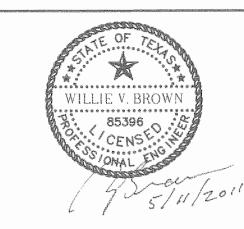E&C Engineers & Consultants Inc. 1010 Lamar, #650 Houston, Texas 77002 713.580.8880 713.580.8888 Fax

## Central Campus Parking Lot Improvements

1300 Holman Street Houston, TX 77004

Contract No.: A/E Project No.

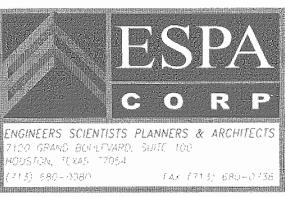Drawn By: Date:

Checked By: Date:

Approved By: Date:

Ownership of Instruments of Service:

All reports, plans, specifications, computer files, field data, notes & other documents and instruments prepared for Houston Community College as instruments of service shall become the property of Houston Community College. Houston Community College shall gain all common law, statutory and other reserved rights, including the copyright thereto.

**GENERAL NOTES** 

Scale: N.T.S.


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F:\2166-024\C1.0 General Notes.dwg Plotted: May 11, 2011 - 10:36am by lloyd

					ABBRE	VIATIONS					
0	4415		DEODEE OF OUR			MAX	MAXIMUM MULTIPLE CONDUIT DUCT	PROTECT	PROTECTION		
&	AND	DEG OR °	DEGREE OF CURVE (ARC) DEFINITION	FL	FLOW LINE	MCD	MULTIPLE CONDUIT DUCT	PS	PUMP STATION	- Constitution of the Cons	TANGENT/ TELEPHONE
©	AT	DIA OR Ø	DIAMETER	FLG	FLANGE	MFR	MANUFACTURER	PSI	POUNDS PER SQUARE INCH	T/	TOP OF
AC	ACRE	DIP	DUCTILE IRON PIPE	FLR	FLOOR	MH	MANHOLE	PVC	POLYVINYL CHLORIDE	TBM	TEMPORARY BENCH MARK
ADJ	ADDROVINATE	DIST	DISTANCE	FM FT	FORCE MAIN FEET	MIN	MINIMUM	PVMT	PAVEMENT	TC	TOP OF CURB
APPROX	APPROXIMATE	DR	DRIVE	FTG	FOOTING	MJ	MECHANICAL JOINT	PW	PLANT WATER OR POTABLE WATER	TEMP	TEMPORARY
APTS	APARTMENTS	DRN	DRAIN	FIG for	YIELD STRENGTH (PSI)	MON	MONUMENT	D	DADILIS OF CIRCUITAR CURVE	THK	THICK
ASPH	ASSEMBLY	DTL	DETAIL	ıy	HELD SIKENGIA (PSI)	MTD	MULTI TILE DUCT MATERIAL	κ PCD	RADIUS OF CIRCULAR CURVE	TXDOT	TEXAS DEPARTMENT OF
ASSY	ASSEMBLY	D/W	DRIVEWAY			MTL	MATERIAL	RCP	REINFORCED CONCRETE PIPE		TRANSPORTATION
AVE	AVENUE	DWG	DRAWING	G	GAS		NODTLI	RD OR RD.	ROAD	TG	TOP OF GRATE
AVG	AVERAGE			GAL	GALLON	N N	NORTH—SOUTH	RE: OR REF	REFERENCE	TMUTCD	TEXAS MANUAL ON UNIFOR
				GALV	GALVANIZED GALLONS PER MINUTE	N-S		RED	REDUCER  REINEORGED REINEORGING		TRAFFIC CONTROL DEVICES
B/	BOTTOM OF	E	EAST/ ELEC.	GPM GV W/BOX	GATE VALVE AND BOX	NA	NOT APPLICABLE	REINF	REINFORCED, REINFORCING OR REINFORCEMENT	TOC	TOP OF CONCRETE
B/C	BACK OF CURB	EA	EACH	,	O/(12	NG	NATURAL GROUND	DEO'D		TP	TOP OF PAVEMENT
BL	BASE LINE	ECC	ECCENTRIC			NGS	NATIONAL GEODETIC SURVEY	REQ'D	REQUIRED	TRAF	TRAFFIC
BEG	BEGINNING	EDB	ELECTRIC DUCT BANK	LID	LIACE DIDD	NTS	NOT TO SCALE	ROW	RIGHT OF WAY	TRAV	TRAVERSE
	BLIND FLANGE		EFFLUENT	HB	HOSE BIBB	NIC	NOT IN CONTRACT	RT	RIGHT	TY	TYPE
BFP	BACKFLOW PREVENTER	ELECT	ELECTRIC	HP	HIGH PRESSURE (GAS LINE), HORSE POWER	NO. OR #	NUMBER	RTR	RADAR TOWER	TYP	TYPICAL
BH	BORE HOLE	ELEV OR EL						RWW	RAW WASTERWATER		
BLDG	BUILDING	ELL.	ELBOW	HL&P OR HLP	HOUSTON LIGHTING & POWER CO	OD	OUTSIDE DIAMETER			U/G	UNDERGROUND
BLVD	BOULEVARD	EMB	EMBANKMENT	HORIZ	HORIZONTAL	OC	ON CENTER	S	SOUTH	,	
		EOP	EDGE OF PAVEMENT	HWL	HIGH WATER LEVEL	O/E	OVERHEAD ELECTRIC	SAN	SANITARY	VAR	VARIABLE
		EXIST.	EXISTING	HWY	HIGHWAY	ОН	OVERHEAD	SCH OR SCHD	SCHEDULE	VCP	VITRIFIED CLAY PIPE
CC	CENTER OF CURVE	EXP	EXPANSION					SD	STORM DRAIN	VOL	VOLUME
C-C	CENTER TO CENTER	L/\(\)		ID	INSIDE DIAMETER	PC	POINT OF CURVATURE	SWR	SEWER	¥ Sur boss	V 000 01 1 1 1 100
CEM	CEMENT			IN	INCH	. •		SF	SQUARE FEET	141	WEST
CF	CUBIC FEET			INF	INFLUENT SEWER	P & ID	PROCESS AND INSTRUMENT DIAGRAM	SH	STATE HIGHWAY	VV	WEST
Cl	CAST IRON			INV OR IE	INVERT ELEVATION			SHT	SHEET	W/	WITH
CIP	CAST IRON PIPE			IP	IRON PIPE OR INTERMEDIATE	PE	PLAIN END	SIG	SIGNAL	W/0	WITHOUT
CITY	CITY OF HOUSTON	hoose dans?		11	PRESSURE (GAS LINE)	PG	PAGE	SPEC	SPECIFICATION	WL	WATER LINE
€ OR CL	CENTERLINE	FB	FIELD BOOK	IR	IRON ROD	P/L	PROPERTY LINE OR PIPE LINE	SQ	SQUARE	WWF	WOVEN OR WELDED WIRE FABRIC
CLEAR OR CLR		fc'	COMPRESSIVE STRENGTH (PSI)			PGL	PROFILE GRADE LINE	SR	SHORT RADIUS		
CMP	CORRUGATED METAL PIPE	FCA	FLANGED COUPLING ADAPTER		10117	PI	POINT OF INTERSECTION	SS	STAINLESS STEEL/ SANITARY SEWER		
CO	CLEAN OUT	FF OR F-F	FACE TO FACE	JT	JOINT	PL.	PLATE	ST	STREET		
COH	CITY OF HOUSTON	FH	FIRE HYDRANT			PP	POWER POLE	STA	STATION ALONG BASELINE		
CONC	CONCRETE	FIG	FIGURE			臣	PROPERTY LINE		OR CENTERLINE		
COND	CONDUIT			LBS	POUNDS	PROP	PROPOSED	STAB	STABILIZED		
CONN	CONNECTION				LINEAR FEET	PT	POINT OF TANGENT	STD	STANDARD		
CONSTR	CONSTRUCTION				LANE			STL	STEEL		
CONT	CONTINUOUS			LP	LOW POINT			STM	STORM		
CORR	CORROSION			LR	LONG RADIUS			SBC	SOUTHWESTERN BELL		
CTB	CONCRETE TRAFFIC BARRIER			LS	LUMP SUM				CORPORATION		
				LT	LEFT OR LIGHT			S/W	SIDEWALK		
				LWL	LOW WATER LEVEL			SY	SQUARE YARD		




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#### Central Campus Parking Lot Improvements

1300 Holman Street Houston, TX 77004

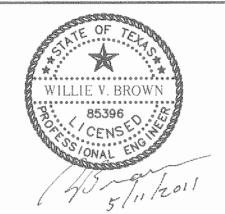A/E Project No.: Contract No.: Drawn By: Date: Checked By: Approved By:


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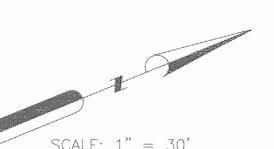
#### **LEGEND AND ABBREVIATIONS**

Scale: N.T.S.

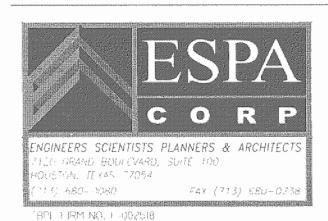C-2.0

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LEGEND

WATER VALVE POWER POLE B OR BB INLET

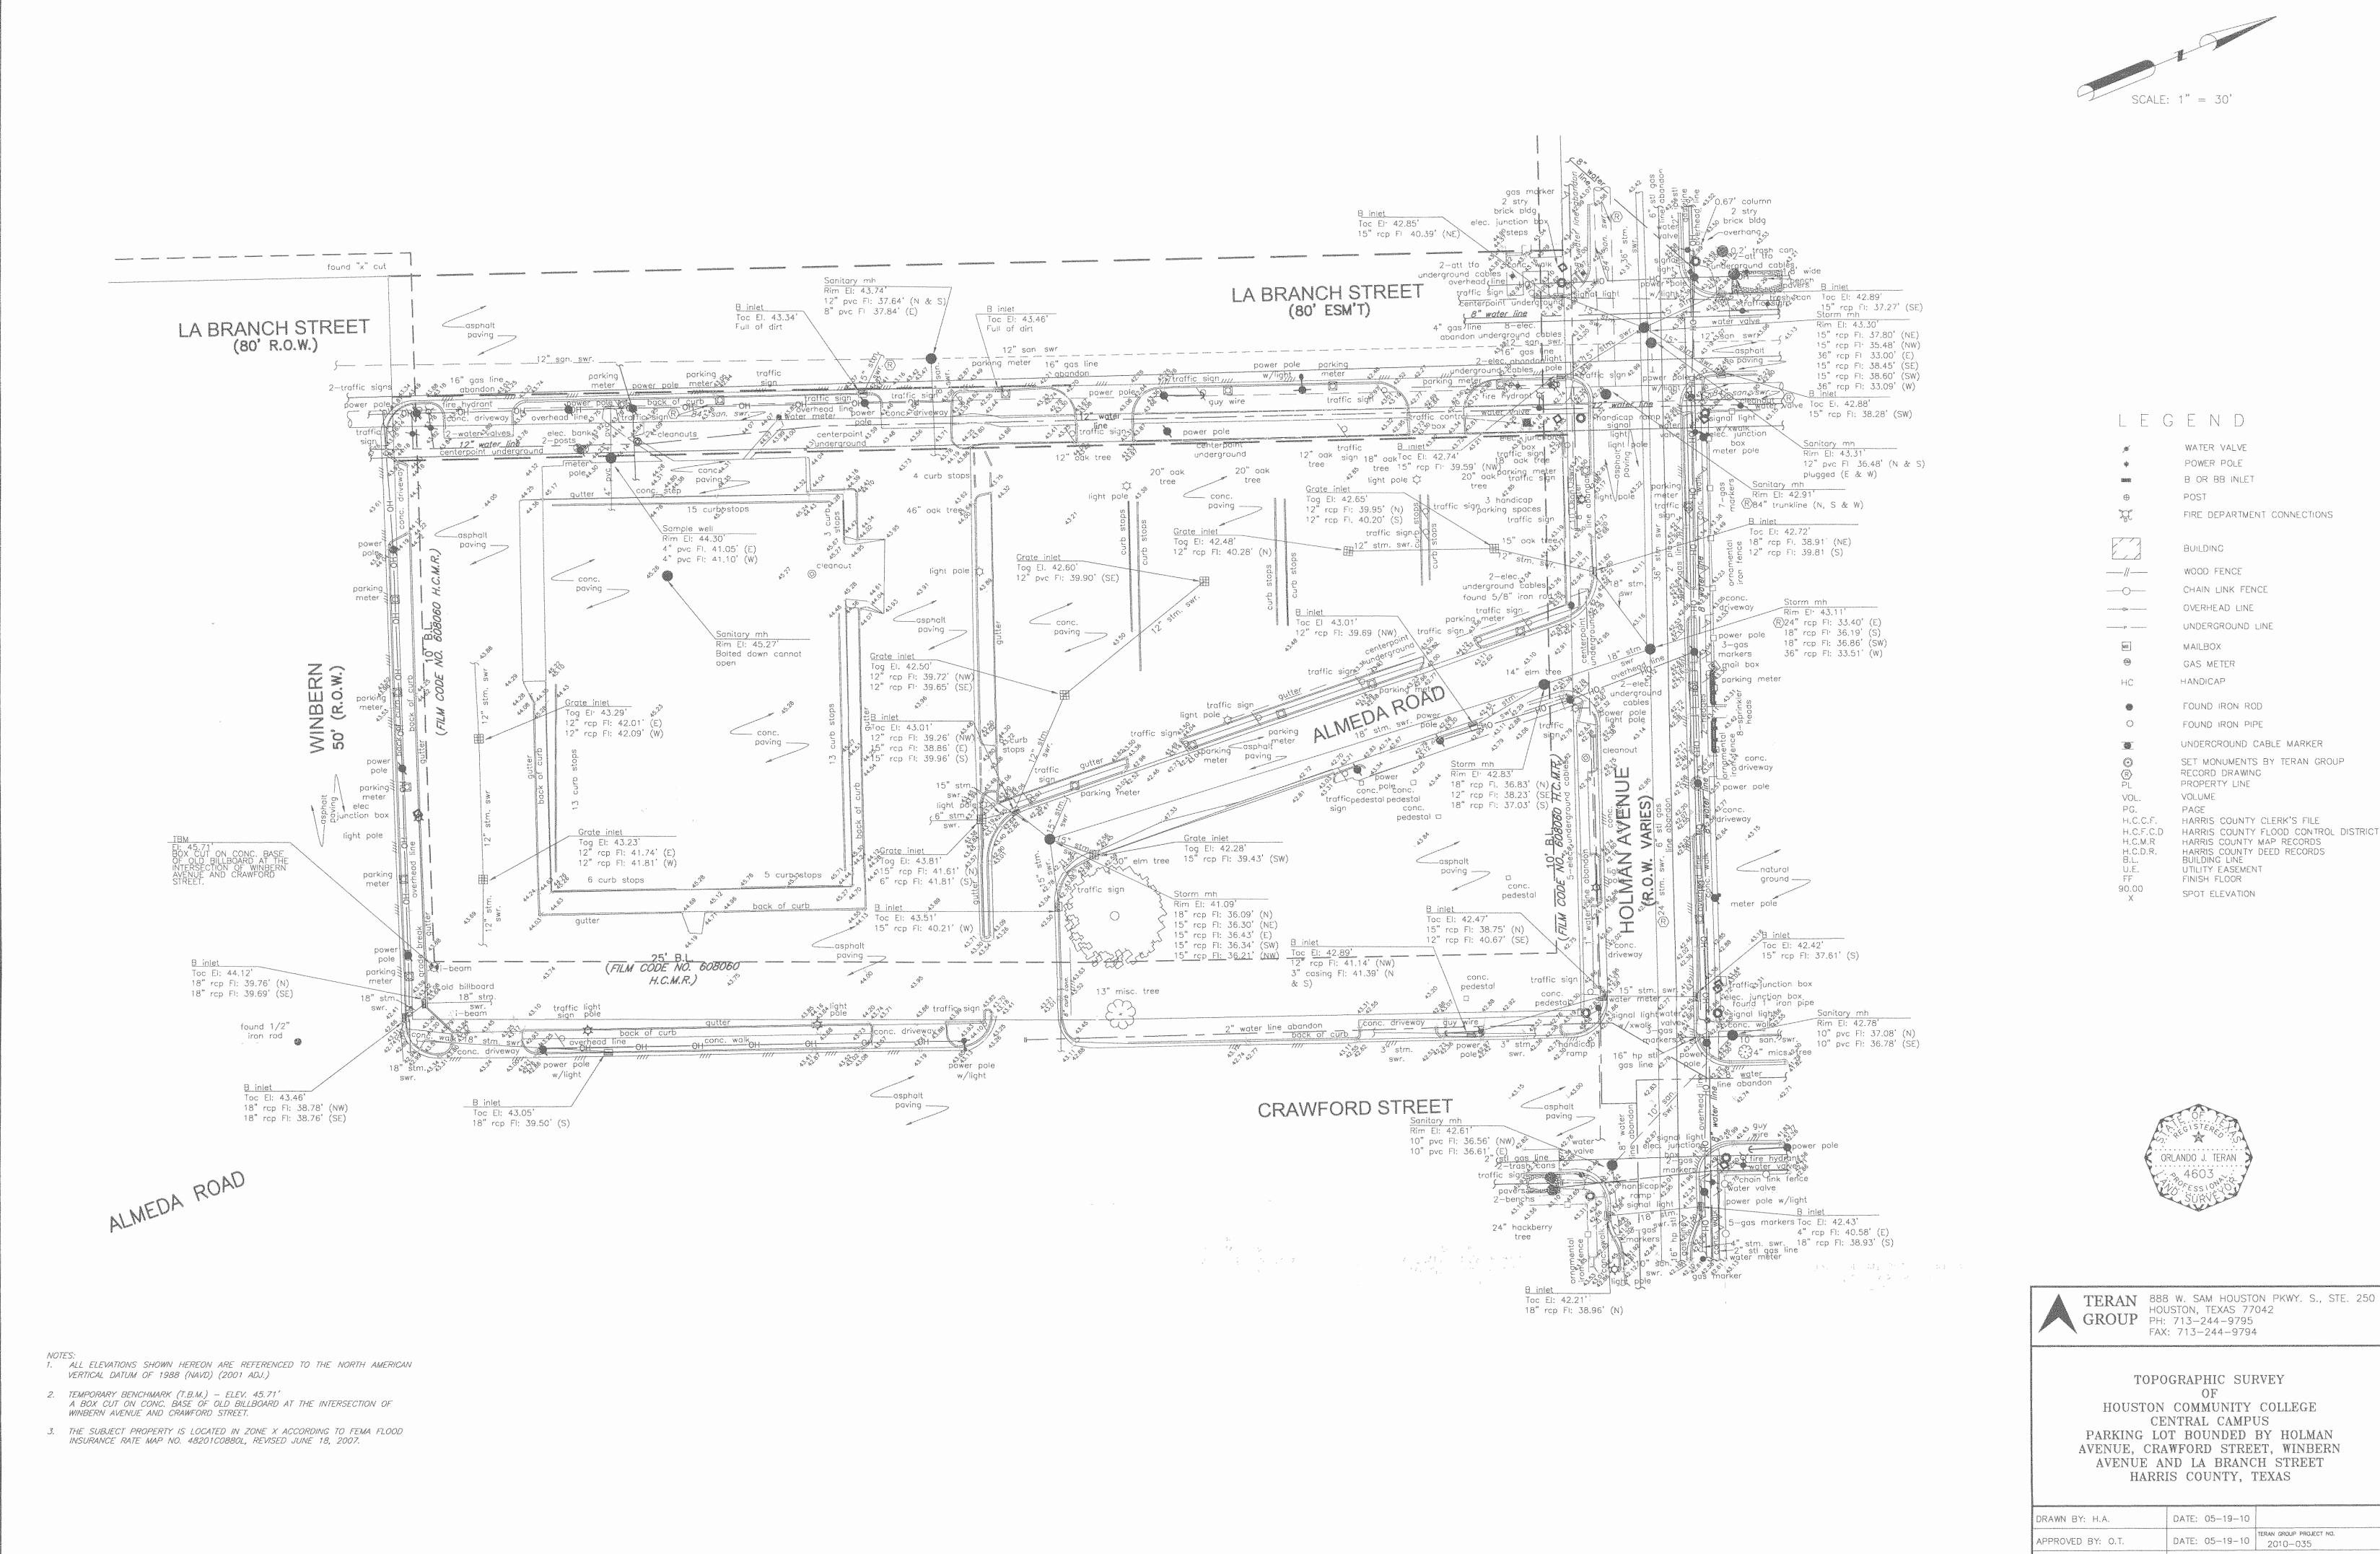FIRE DEPARTMENT CONNECTIONS

WOOD FENCE CHAIN LINK FENCE

SCALE: 1'' = 20'

OVERHEAD LINE UNDERGROUND LINE MAILBOX GAS METER

> HANDICAP FOUND IRON ROD FOUND IRON PIPE UNDERGROUND CABLE MARKER

SET MONUMENTS BY TERAN GROUP RECORD DRAWING PROPERTY LINE VOLUME PAGE HARRIS COUNTY CLERK'S FILE

SHEET NO 1 OF 1

H.C.F.C.D HARRIS COUNTY FLOOD CONTROL DISTRICT HARRIS COUNTY MAP RECORDS HARRIS COUNTY DEED RECORDS BUILDING LINE UTILITY EASEMENT FINISH FLOOR SPOT ELEVATION

> STUDIO OF RICHARD JETER MEA Lighting Designer 19409 PEBBLE BEND DR. HOUSTON, TEXAS TTOSS

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Issue/Revision:

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ENGINEERS SCIENTISTS PLANNERS & ARCHITECTS

(213, 680-1080 (213) 680 C

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architecture + planning + design

5120 Woodway, Suite 8010

Houston, TX 77056

p: 713.850.1500

f: 713.850.1023

e: info@theldnet.com

E&C Engineers & Consultants Inc 1010 Lamar, #650 Houston, Texas 77002 713 580.8800 713.580.8888 Fax

281-759-1723 tx

Central Campus Parking Lot Improvements

Houston

Community

College

**HCC - Construction Department** 3100 Main, 12th Floor Houston, Texas, 77002 Voice: 713.718.5168 reynaldo.pradia@hccs.edu

1300 Holman Street Houston, TX 77004


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**TOPOGRAPHIC SURVEY** 

C-3.0

F:\2166-024\C3.0 Topographic-Survey.dwg Plotted: May 11, 2011 - 10:44am by lloyd



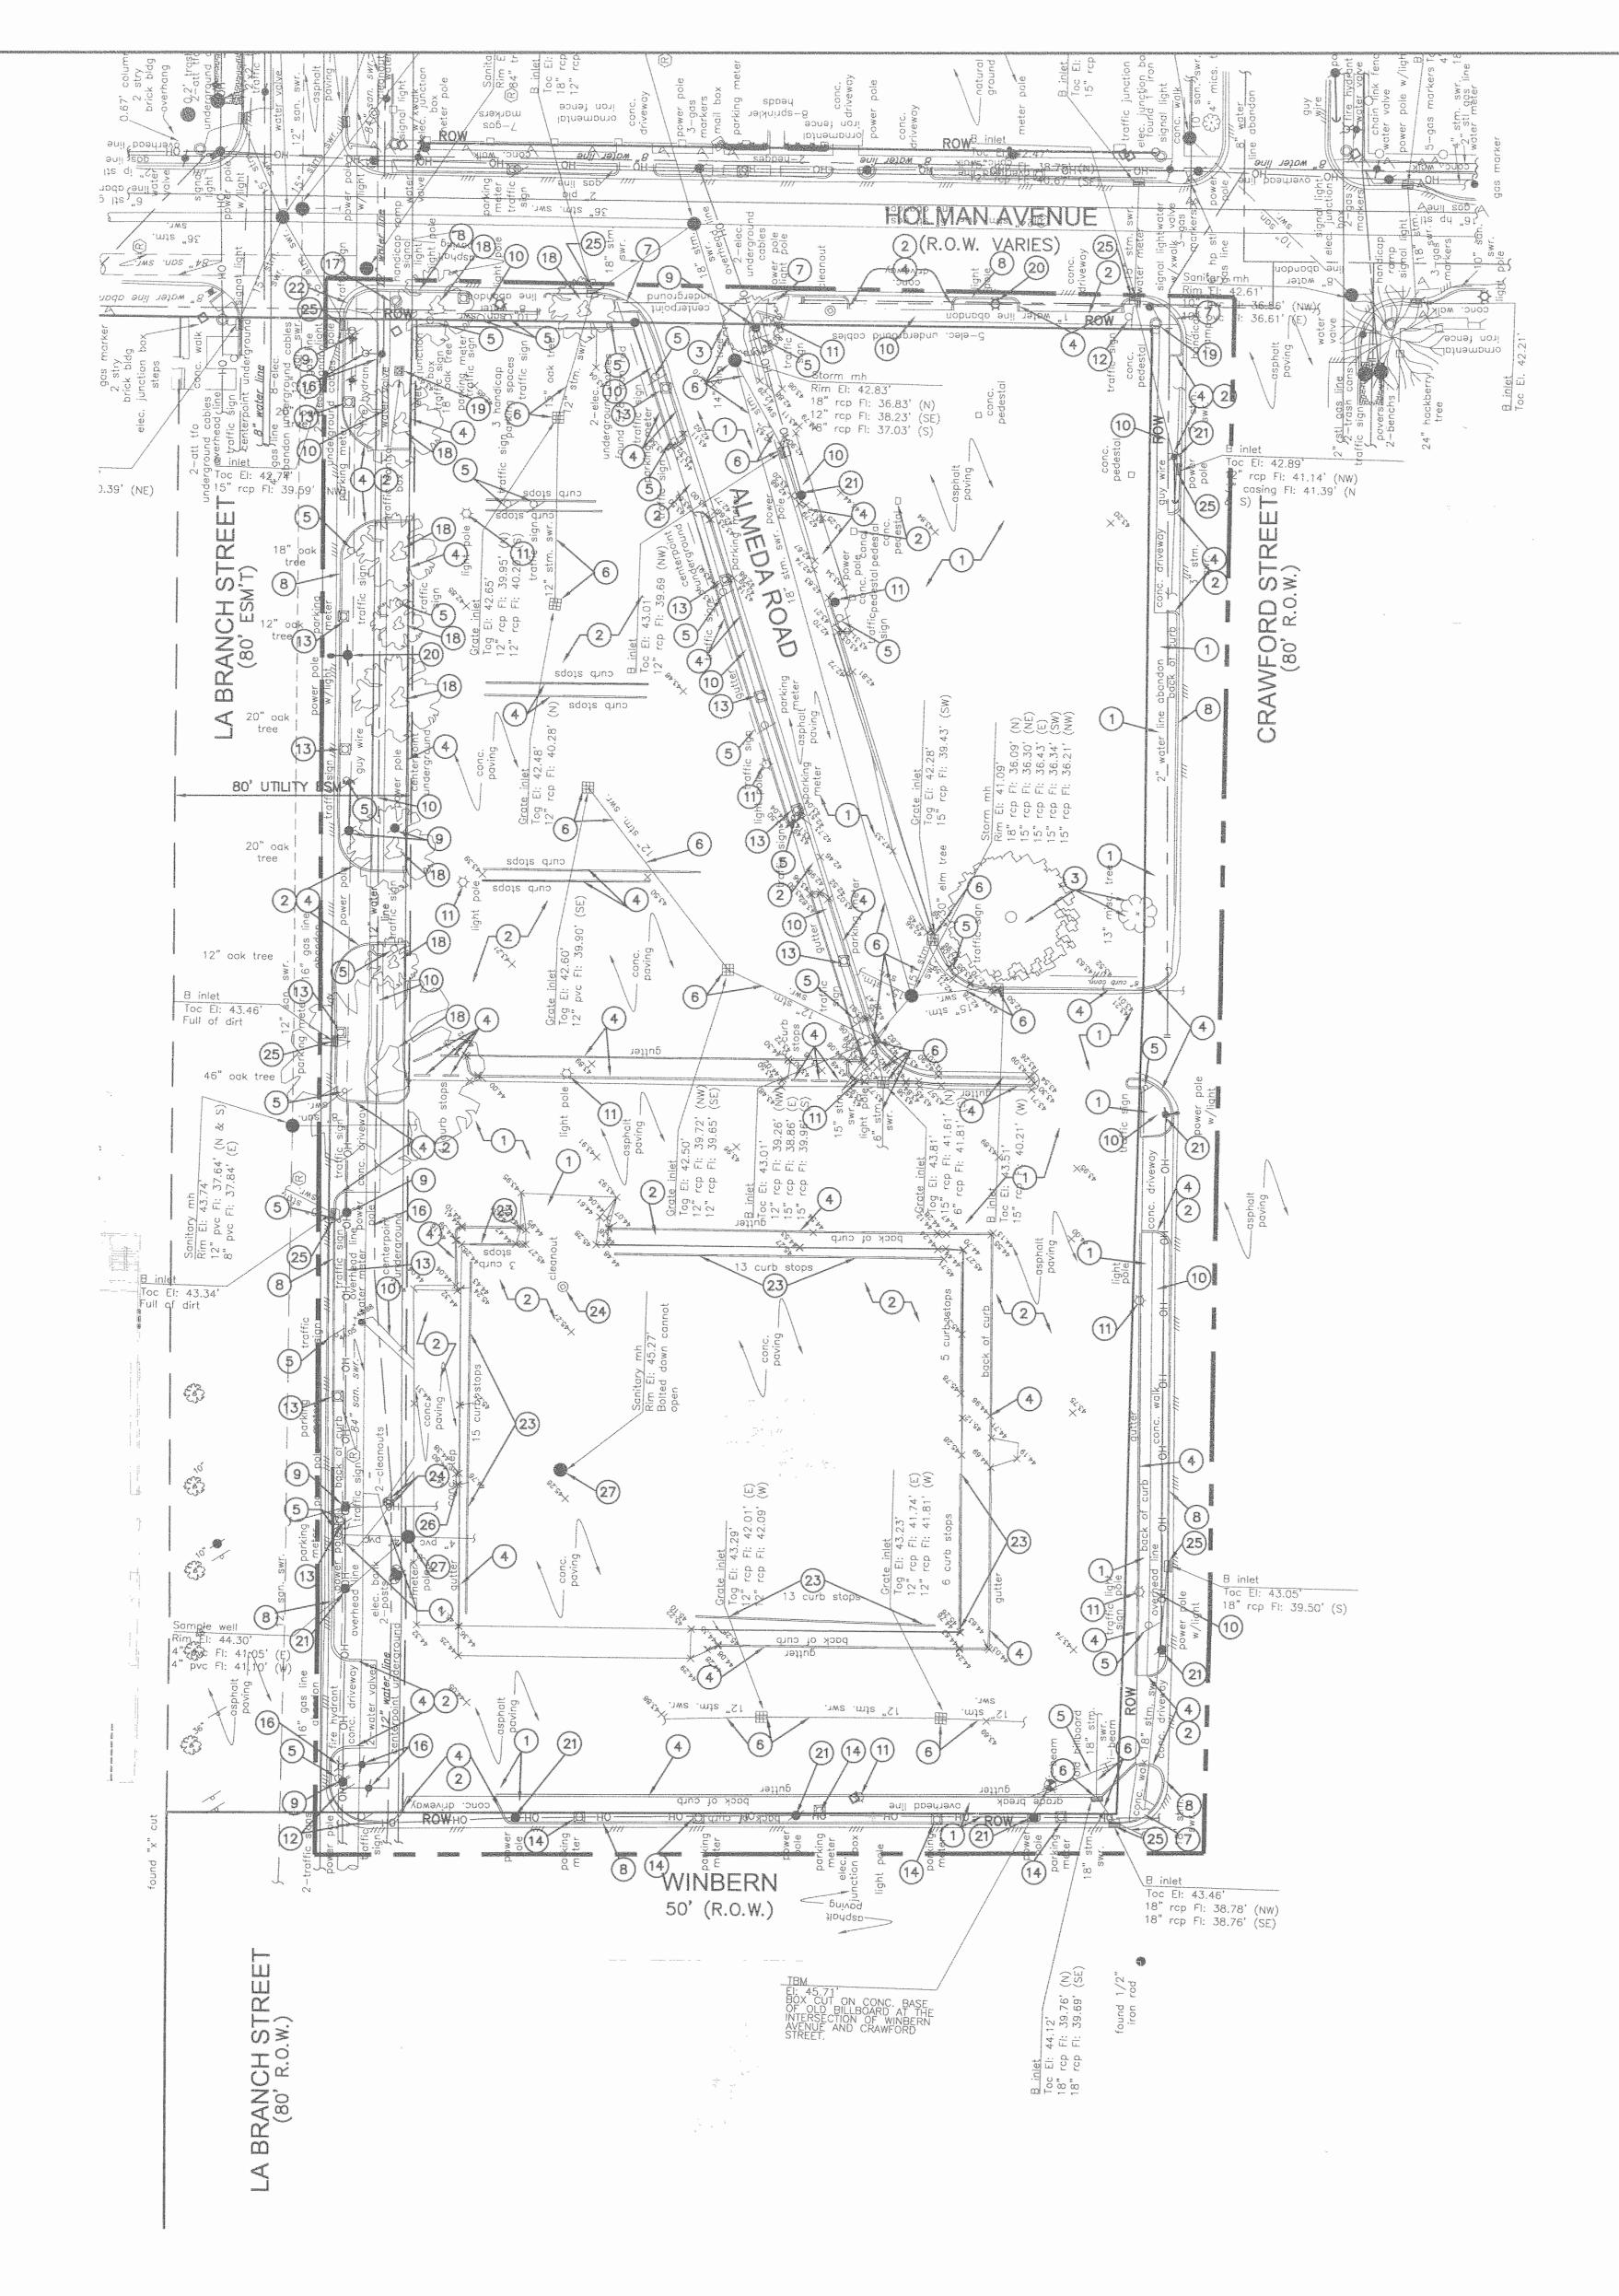

#### LEGEND:

EXIST STM SWR MH EXIST TYPE "A" INLET

SCALE: 1"=30'

EXIST SAN SWR MH POWER POLE B OR BB INLET FIRE DEPARTMENT

CONNECTIONS BUILDING WOOD FENCE CHAIN LINK FENCE OVERHEAD LINE UNDERGROUND LINE

MAILBOX GAS METER HANDICAP

FOUND IRON PIPE UNDERGROUND CABLE MARKER

SET MONUMENTS BY TERAN GROUP PARKING METER

FOUND IRON ROD

HARRIS COUNTY CLERK'S FILE HARRIS COUNTY FLOOD CONTROL DISTRICT HARRIS COUNTY MAP RECORDS BUILDING LINE

UTILITY EASEMENT FINISH FLOOR FROM RECORD DRAWINGS

ELECTRICAL UNDERGROUND CABLES WERE UNABLE TO BE LOCATED

UNDERGROUND CABLES TO BUILDING, UNABLE TO LOCATE UNDERGROUND WATER LINES WERE UNABLE TO BE LOCATED

UNABLE TO LOCATE ANY UNDERGROUND LINE

#### LIMITS OF DISTURBANCE

#### DEMOLITION KEY NOTES 1) REMOVE EXISTING ASPHALT PAVEMENT AND BASE MATERIAL

(2) REMOVE EXISTING CONCRETE PAVEMENT, CONCRETE DRIVEWAY APRONS AND CONCRETE PEDESTALS

3 REMOVE TREES WITH COMPLETE ROOT STRUCTURE TO BELOW 6'-0" SEE GEOTECHNICAL REPORT

4) REMOVE EXISTING CONCRETE CURB

(5) REMOVE EXISTING SIGNS INCLUDING OVERHEAD SIGNS

(6) REMOVE EXISTING AREA INLETS, TYPE "B" INLET, MANHOLE, AND STORM SEWERS

(7) REMOVE EXISTING CONCRETE HC RAMP

(8) EXIST CONCRETE CURB TO REMAIN

(9) COORDINATE WITH CENTERPOINT ENERGY FOR REMOVAL

AND RELOCATION EXISTING POWER POLES (10) REMOVE EXISTING SIDEWALK

(11) EXISTING LIGHT STANDARDS & PARKING LOT LIGHT TO BE

REMOVED (12) EXISTING STREET SIGNS IN PUBLIC R.O.W. TO BE REMOVED DURING CONSTRUCTION AND RE-INSTALLED. CONTRACTOR

TO COORDINATE WITH CITY OF HOUSTON. (13) EXISTING PARKING METERS TO BE REMOVED

(14) EXISTING PARKING METER IN A PUBLIC R.O.W. TO BE REMOVED DURING CONSTRUCTION AND RE-INSTALLED. CONTRACTOR TO COORDINATE WITH CITY OF HOUSTON BEFORE THE REMOVAL OF METERS.

(15) NOT USED

(16) EXISTING FIRE HYDRANT AND WATER VALVE TO REMAIN CONTRACTOR TO ADJUST EXIST FIRE HYDRANT AND WATER VALVES TO PROP FINISHED GRADE

17) RELOCATE EXISTING TRAFFIC SIGNAL CONTROL BOX. CONTRACTOR TO COORDINATE WITH THE CITY OF HOUSTON.

(18) EXISTING TREES TO REMAIN

19 RELOCATE EXISTING TRAFFIC SIGNAL POLE. CONTRACTOR TO COORDINATE WITH THE CITY OF HOUSTON.

(20) EXISTING LIGHT STANDARDS TO REMAIN

(21) EXISTING POWER POLE TO REMAIN

(22) EXISTING CONCRETE HC RAMP TO REMAIN


(23) REMOVE EXISTING CURB STOPS

(24) REMOVE EXISTING CLEANOUT

(25) EXISTING INLET TO REMAIN IN PLACE


(26) REMOVE EXISTING CONCRETE STEP

(27) REMOVE EXISTING SANITARY SEWER MANHOLE, SAMPLE WELL, AND PLUG EXISTING PIPES

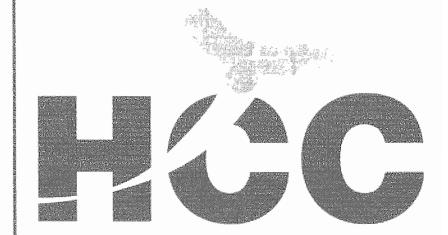

#### Houston Community College


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281-759-1513 ph

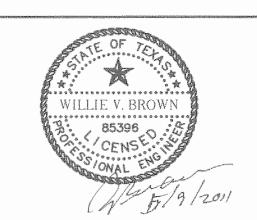1010 Lamar, #650 Houston, Texas 77002 713 580.8800 713.580.8888 Fax

281 - 759 - 1723 fx

#### Central Campus Parking Lot Improvements

1300 Holman Street Houston, TX 77004

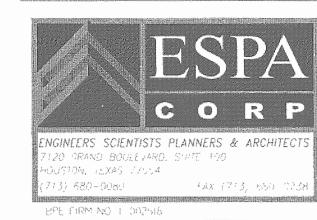Contract No.:	A/E Project No.
Drawn By:	Date:
Checked By:	Date:
Approved By:	Date:

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#### **DEMOLITION PLAN**

Scale: 1"=30'

C-4.0

#### SITE DRAINAGE SHALL BE MAINTAINED ACROSS THE ENTIRE SITE. NO PONDING OR WATER ENTRAPMENTS SHALL BE ALLOWED. 6. DRAINAGE DITCHES OR SWALES AT THE STREETS SHALL HAVE THE FLOWLINES AND SLOPES OF SHOULDERS MAINTAINED TO PROVIDE FLOW OR STORM DRAINAGE; REMOVE

ANY TRASH OR DEBRIS

THE COMPLETED DEMOLITION SITE.

GENERAL NOTES

END PAVEMENT AND CURB REMOVAL AT THE "LIMITS OF DEMOLITION" LINE. SAW-CUTTING METHOD SHALL BE USED AT THESE LOCATIONS. 8. THE DEMOLITION CONTRACTOR SHALL SUBMIT CONSTRUCTION/DEMOLITION SCHEDULE (SIMPLE BAR CHART) TO THE ARCHITECT/ENGINEER WITHIN TWO (2) WEEKS OF NOTICE TO PROCEED. THE DEMOLITION CONTRACTOR SHALL BE RESPONSIBLE FOR

7. THE LIMITS OF DEMOLITION ARE INDICATED ON THIS SHEET. THE CONTRACTOR SHALL

1. CONTRACTOR SHALL COMPLY WITH ALL CITY REGULATIONS AND SECURE NECESSARY PERMITS REQUIRED BY CITY OF HOUSTON FOR DEMOLITION AND REMOVAL OF

CONTRACTOR SHALL PROTECT ALL ADJACENT STREETS FROM DAMAGE DUE TO HEAVY EQUIPMENT OR JOB RELATED VEHICLES.

3. CONTRACTOR SHALL REMOVE ALL MAN-MADE ITEMS (DEBRIS AND GARBAGE) FROM


4. PROVIDE PEDESTRIAN PROTECTION AS REQUIRED BY THE CITY OF HOUSTON.

SITE SECURITY ONCE DEMOLITION STARTS. 9. DEMOLITION DOCUMENTS TO BE MAINTAINED ON SITE DURING THE WORK-DRAWINGS, SPECIFICATIONS, ADDENDA, ETC. RECORD ANY SIGNIFICANT CHANGES AND TURN IN


AT THE COMPLETION OF THE PROJECT AS-BUILT DRAWINGS.

10. ALL EXISTING DRIVEWAY NOT TO BE USED AND EXISTING DRIVEWAY SIDEWALK AND CULVERTS TO BE REMOVED. THIS AREA TO BE REGARDED TO PROVIDE POSITIVE

F: \2166-024\C4.0 Demolition Plan.dwg Plotted: May 12, 2011 - 3:06pm by lloyd

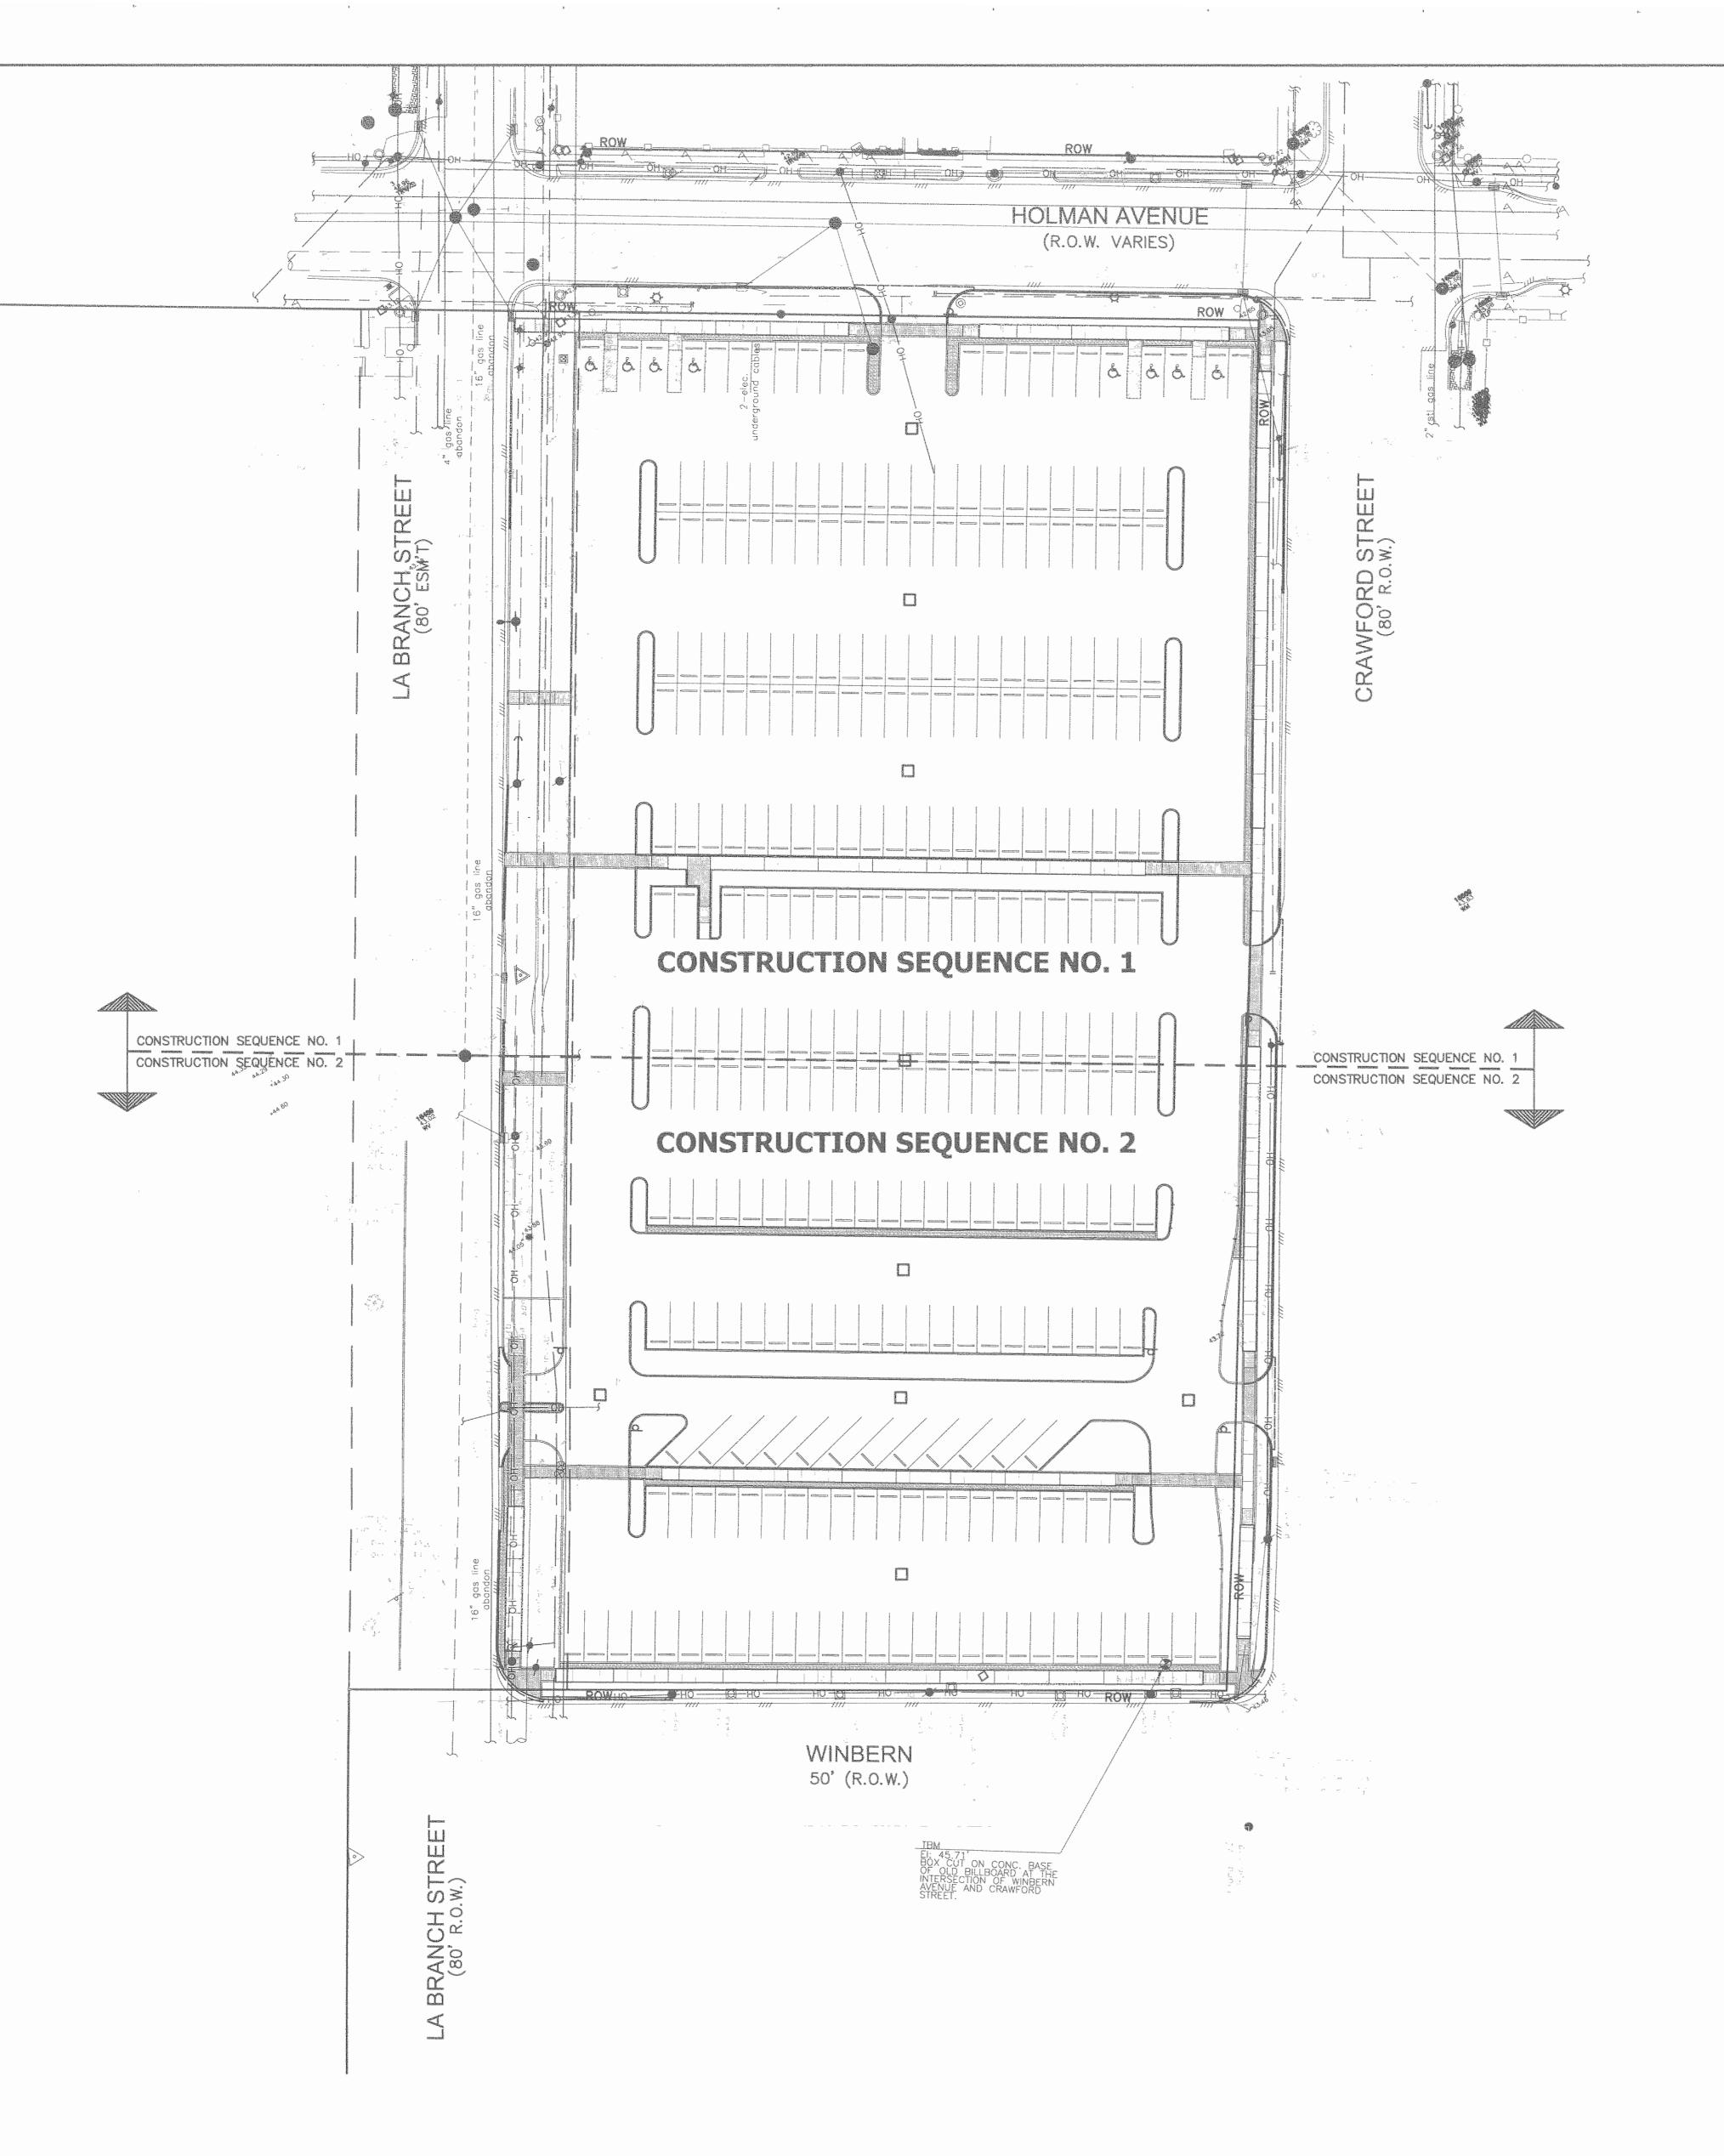


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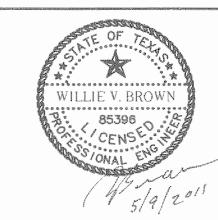
#### BENCHMARK:

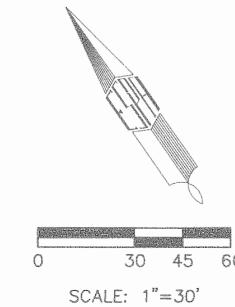- 1. ALL ELEVATIONS SHOWN HEREON ARE REFERENCED TO THE NORTH AMERICAN VERTICAL DATUM OF 1988 (NAVD) (2001 ADJ.)
- 2. TEMPORARY BENCHMARK (T.B.M ) ELEV. 45.71' A BOX CUT ON CONC. BASE OF OLD BILLBOARD AT THE INTERSECTION OF WINBERN AVENUE AND CRAWFORD STREET
- 3. THE SUBJECT PROPERTY IS LOCATED IN ZONE X ACCORDING TO FEMA FLOOD INSURANCE RATE MAP NO. 48201C0880L, REVISED JUNE 18, 2007



# Houston Community College

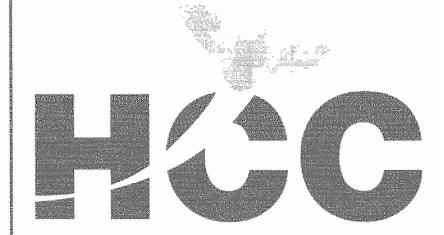
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#### II llewelyn-davies sahni

architecture + planning + design
5120 Woodway, Suite 8010
Houston, TX 77056
p: 713.850.1500
f: 713.850.1023
e: info@theldnet.com



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E&C Engineers & Consultants Inc 1010 Lamar, #650 Houston, Texas 77002 713:580:8880 713:580:8888 Fax

# Central Campus Parking Lot Improvements

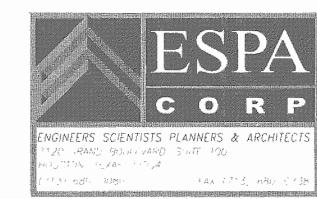1300 Holman Street Houston, TX 77004

3		
	Contract No	A/E Project No.:
	Drawn By:	Date:
	Checked By:	Date:
	Approved By:	Date:


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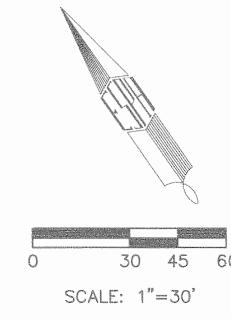
CONSTRUCTION SEQUENCE PLAN

Scale: 1"=30'

C-5.0



F:\2166-024\C6.0 Civil Site Plan.dwg Plotted: May 12, 2011 - 3:05pm by lloyd

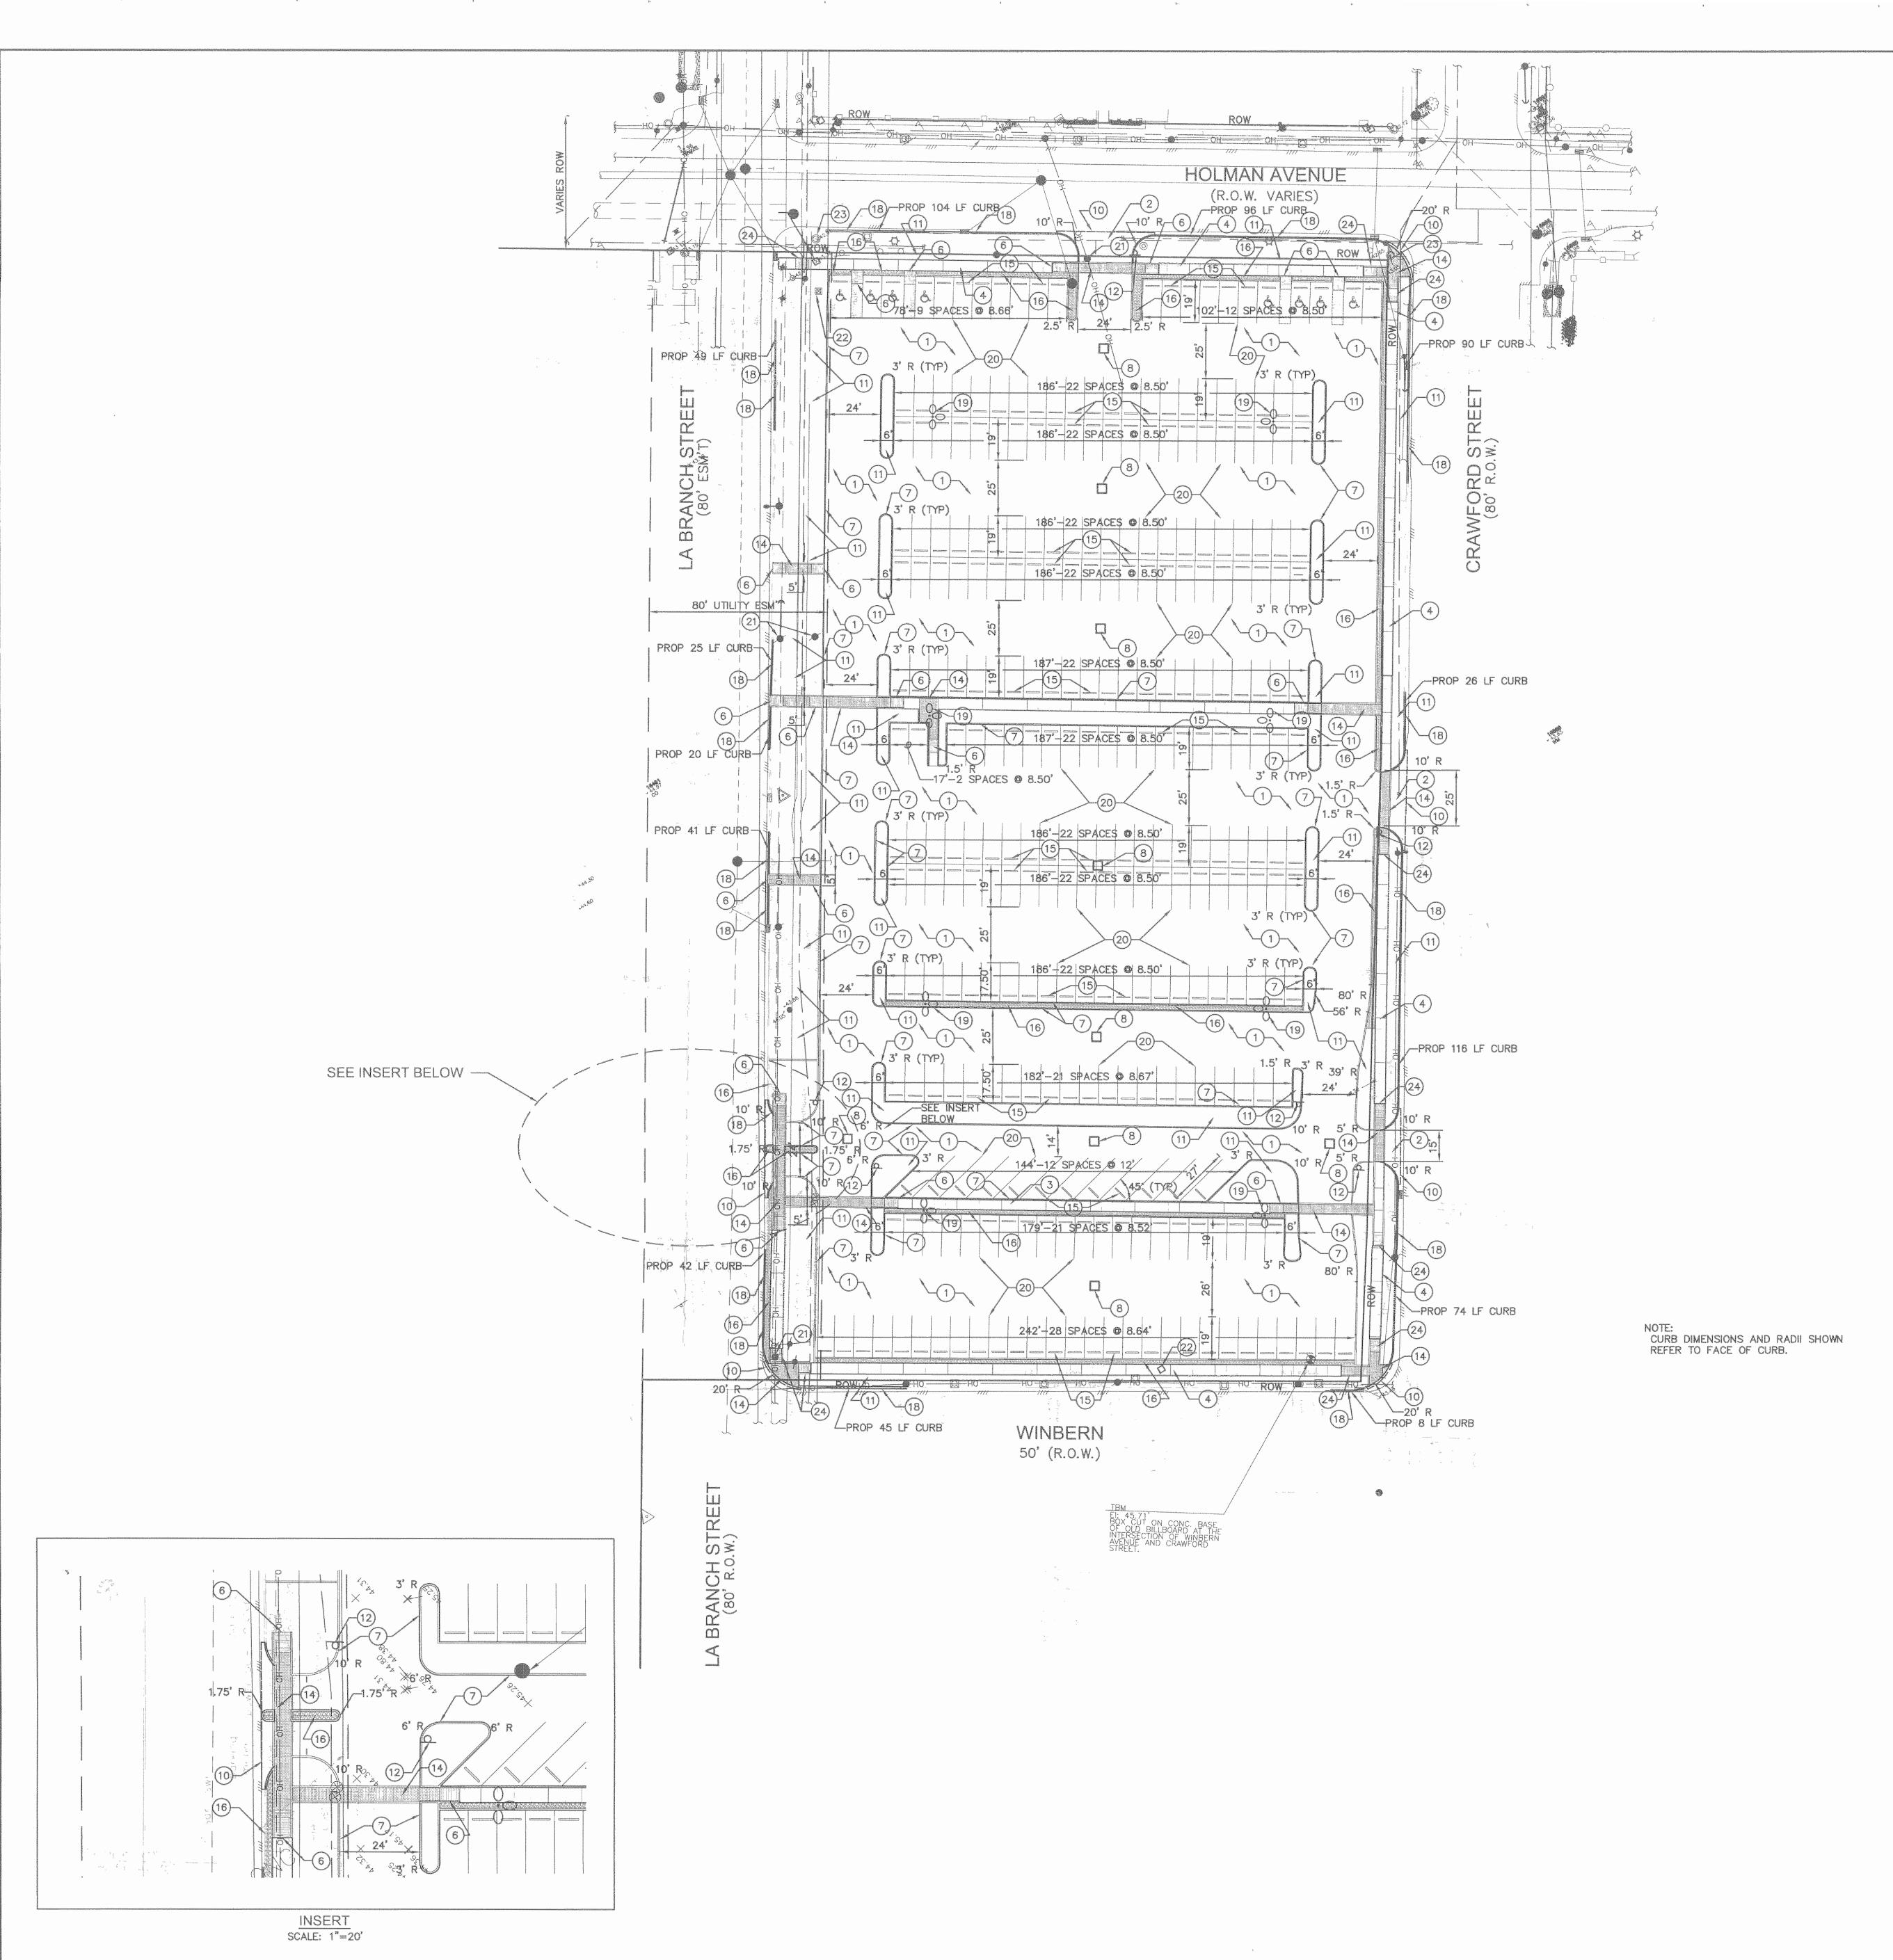

#### LEGEND:

guerroran Barroran Barroran	PROP AREA INLET
	EXIST STM SWR MH
	EXIST TYPE "A" INLET
*	EXIST SAN SWR MH  POWER POLE  B OR BB INLET
<b>⊕</b>	POST
PC.	FIRE DEPARTMENT CONNECTIONS
	BUILDING
	WOOD FENCE CHAIN LINK FENCE
	OVERHEAD LINE
eminence P ministration	UNDERGROUND LINE
(GM)	MAILBOX GAS METER
HC	HANDICAP
<ul><li>O</li></ul>	FOUND IRON ROD FOUND IRON PIPE
H.C.M.R. H.C.D.R. B.L. U.E. FF	HARRIS COUNTY FLOOD CONTROL DISTRICT HARRIS COUNTY MAP RECORDS HARRIS COUNTY DEED RECORDS BUILDING LINE UTILITY EASEMENT FINISH FLOOR FROM RECORD DRAWINGS
<u>(1)</u>	ELECTRICAL UNDERGROUND CABLES WERE UNABLE TO BE LOCATED UNDERGROUND CABLES TO BUILDING,
<u>(2)</u>	UNDERGROUND CABLES TO BUILDING, UNABLE TO LOCATE UNDERGROUND WATER LINES WERE UNABLE
(3)	TO BE LOCATED
<u>4</u>	UNABLE TO LOCATE ANY UNDERGROUND LINE

#### KEY NOTES

2	PROP 7" CONC APRON DRIVEWAY; REF SHT C12.1
3	PROP 4' WIDE CONC SIDEWALK; REF SHT C12.0-A10
4	PROP 5' WIDE CONC SIDEWALK; C12.0-A10
(5)	EXIST CONC CURB TO REMAIN
6	PROP ADA HANDICAP RAMP; REF SHT C12.0-A4
7	PROP 6" CONC CURB; REF SHT C12.0-A9
8	PROP TYPE "A" AREA INLET; REF C12.0-A2
9	NOT USED
10)	PROP 1 FT SAWCUT
(11)	PROP GRASS/LANDSCAPE AREA
12	PROP STOP SIGN-R1-1
13)	RE-INSTALL EXIST PARKING METERS
14)	PROP SIDEWALK CONC PAVERS; REF SHT C12.0-A12
15)	PROP CONCRETE WHEEL STOP; REF SHT C12.0-A7
16	PROP BLACK STAR GRAVEL; REF SHT C12.0-A5
17)	PROP PAVEMENT STRIPING
18)	PROP CONC CURB AND GUTTER FOR MISSING CURB AND GUTTER; REF SHT C12.0-A8
19	PROP LIGHT POLE
20	PROP REFLECTORIZED 4" WHITE SOLID PAVEMENT MARKING
21)	COORDINATE WITH CENTERPOINT ENERGY FOR REMOVAL AND RELOCATION EXISTING POWER POLES
(22)	RELOCATE EXISTING TRAFFIC SIGNAL CONTROL BOX. CONTRACTOR TO COORDINATE WITH THE CITY OF HOUSTON.
	is sectioning to it it it is will be investig

RELOCATE EXISTING TRAFFIC SIGNAL POLE. CONTRACTOR TO COORDINATE WITH THE CITY OF HOUSTON.


PROP COH CURB RAMP DETAIL; REF SHT C12.0-A13

PROP 2 1/2" ASPHALT PAVEMENT; REF SHT C12.0-A6



#### Houston Community College


HCC - Construction Department 3100 Main, 12th Floor Houston, Texas, 77002 Voice: 713.718.5168 reynaldo.pradia@hccs.edu

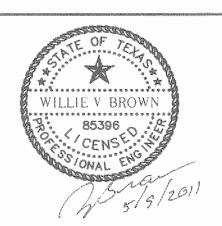

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İssu	Issue/Revision:					
REV	DESCRIPTION	DATE	BY			
1	ISSUED FOR BID & CONSTRUCTION	05/09/11	JA			
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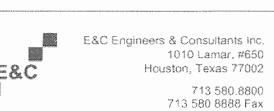
## Ilewelyn-davies sahni architecture + planning + design

architecture + planning + design
5120 Woodway, Suite 8010
Houston, TX 77056
p: 713.850.1500
f: 713.850.1023
e: info@theldnet.com

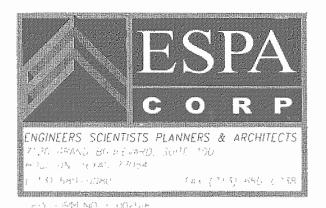

ENVIRONMENTS & co ARCHITECTURE \* INTERIORS \* LANDSCAPE \* PLANNING 21550 Provincial Blvd., Blag. 4, #413 Katy, Texas 77450 281-759-1513 ph 281-759-1723 fx

> STUDIO OF RICHARD LETER MFA LIGHTING DESIGNER 15903 PEBBLE BEND DR. HOUSTON, TEXAS TIOGO



Central Campus

Parking Lot Improvements

1300 Holman Street Houston, TX 77004

Contract No	A/E Project No.:
Drawn By:	Date:
Checked By	Date:
Approved By:	Date:


Ownership of Instruments of Service:


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CIVIL SITE PLAN

Scale: 1"=30'

C-6.0



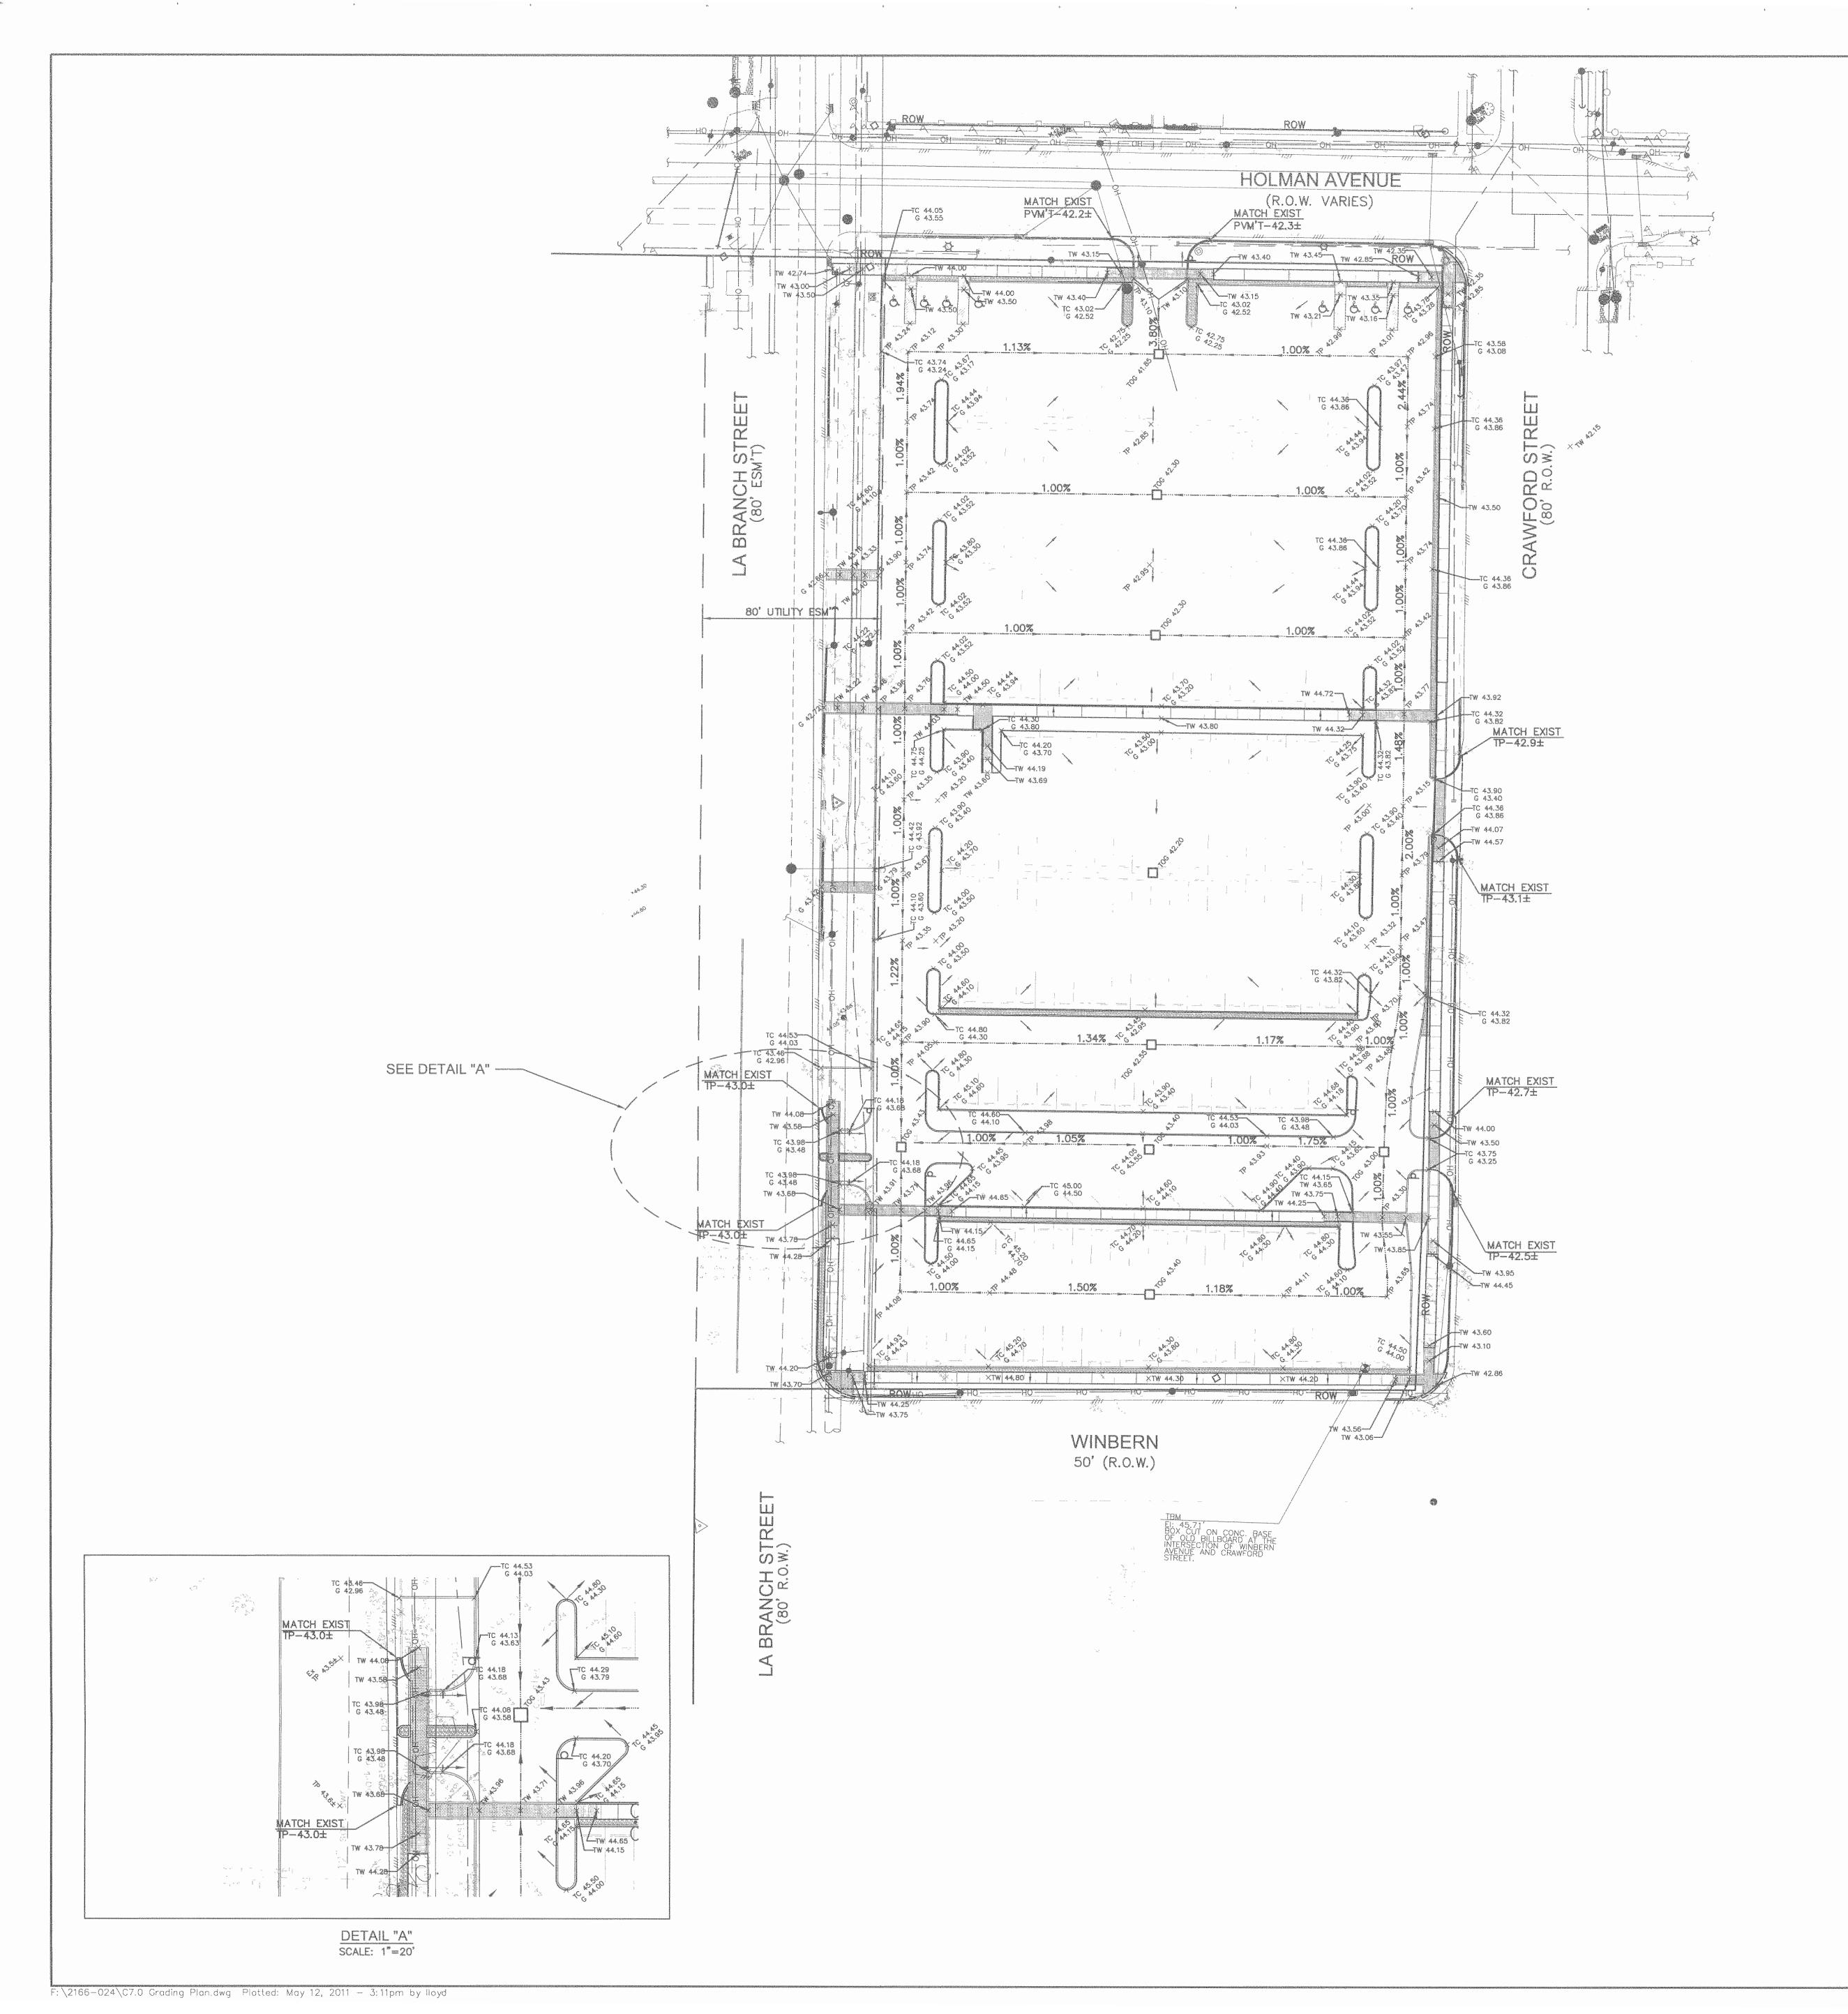
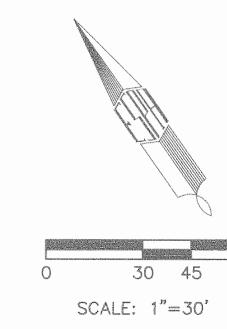
#### BENCHMARK:

- 1. ALL ELEVATIONS SHOWN HEREON ARE REFERENCED TO THE NORTH AMERICAN VERTICAL DATUM OF 1988 (NAVD) (2001 ADJ.)
- TEMPORARY BENCHMARK (T.B.M.) ELEV. 45.71' A BOX CUT ON CONC BASE OF OLD BILLBOARD AT THE INTERSECTION OF WINBERN AVENUE AND CRAWFORD STREET
- 3 THE SUBJECT PROPERTY IS LOCATED IN ZONE X ACCORDING TO FEMA FLOOD INSURANCE RATE MAP NO 48201C0880L, REVISED JUNE 18, 2007

ALL SIDEWALKS AND WALKWAYS SHALL HAVE A 2% MAXIMUM CROSS SLOPE.

#### LEGEND:

	PROP AREA INLET
TW	TOP OF WALK
TP	TOP OF PAVEMENT
TC	TOP OF CURB
TOG	TOP OF GRATE
G	GUTTER
	PROP TYPE "A" GRATE INLET

#### PROP ELEVATIONS

G	
	EXIST STM SWR MH
	EXIST TYPE "A" INLET
	EXIST SAN SWR MH
•	POWER POLE
	B OR BB INLET
$\oplus$	POST
Ŗ	FIRE DEPARTMENT CONNECTIONS

WOOD FENCE
CHAIN LINK FENCE
OVERHEAD LINE
UNDERGROUND LINE
MAILBOX

BUILDING

GAS METER

HC HANDICAP

FOUND IRON ROD

FOUND IRON PIPE

UNDERGROUND CABLE MARKER

SET MONUMENTS BY TERAN GROUP

PARKING METER

PL PROPERTY LINE
VOL. VOLUME
PG. PAGE
H.C.C.F. HARRIS COUNTY

H.C.C.F. HARRIS COUNTY CLERK'S FILE
H.C.F.C.D. HARRIS COUNTY FLOOD CONTROL DISTRICT
H.C.M.R. HARRIS COUNTY MAP RECORDS
H.C.D.R HARRIS COUNTY DEED RECORDS
B.L. BUILDING LINE

E. UTILITY EASEMENT

FINISH FLOOR

FROM RECORD DRAWINGS

ELECTRICAL UNDERGROUND CABLES WERE UNABLE TO BE LOCATED

UNDERGROUND CABLES TO BUILDING,


UNABLE TO LOCATE

UNDERGROUND WATER LINES WERE UNABLE TO BE LOCATED

UNABLE TO LOCATE ANY UNDERGROUND LINE

#### Houston Community College

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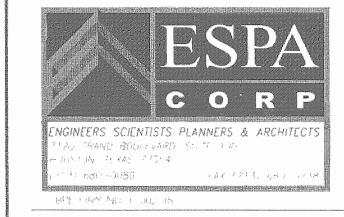


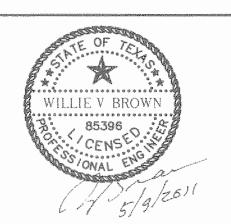Issue/Revision:					
REV	DESCRIPTION	DATE	BY		
1	ISSUED FOR BID & CONSTRUCTION	05/09/11	JA		
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### II llewelyn-davies sahni

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5120 Woodway, Suite 8010
Houston, TX 77056
p: 713.850.1500
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e: info@theldnet.com



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281 - 759 - 1513 ph 281 - 759 - 1723 tx

STUDIO OF RICHARD JETER MFA LIGHTING DESIGNER 15903 PEBBLE BEND DR. HOUSTON, TEXAS 17068



E&C Engineers & Consultants Inc 1010 Lamar, #650 Houston, Texas 77002 713.580 8800 713 580.8888 Fax

### Central Campus Parking Lot Improvements

1300 Holman Street Houston, TX 77004

Contract No.:

Drawn By:

Checked By:

Approved By:

Date:

Date:

Ownership of Instruments of Service:

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#### **GRADING PLAN**

Scale: 1"=30'

C-7.0

POINT NO.	X COORDINATE	Y COORDINATE	DESCRIPTION
100	3118989.29	13834569.06	PROPERTY CORNER
101	3119261.45	13834397.32	PROPERTY CORNER
102	3119423.95	13834637.99	PROPERTY CORNER
103	3119540.09	13834817.66	PROPERTY CORNER


200	3119411.52	13834851.47	TYPE "A" INLET
201	3119377.30	13834798.52	TYPE "A" INLET
202	3119343.25	13834745.52	TYPE "A" INLET
203	3119285.52	13834656.06	TYPE "A" INLET
204	3119243.94	13834591.25	TYPE "A" INLET
205	3119124.83	13834611.82	TYPE "A" INLET
206	3119217.88	13834552.12	TYPE "A" INLET
207	3119306.45	13834495.30	TYPE "A" INLET
208	3119183.46	13834497.10	TYPE "A" INLET
<del>namen med distribution of the state of the </del>	\$\frac{1}{2}\frac{1}{2	New who we are not to the grant or passes and the control of the c	


300	3119422.47	13834890.45	DRIVEWAY
301	3119442.62	13834877.42	DRIVEWAY
302	3119413.89	13834625.06	DRIVEWAY
303	3119400.25	13834604.11	DRIVEWAY
304	3119341.16	13834492.20	DRIVEWAY
305	3119323.49	13834491.78	DRIVEWAY
306	3119322.64	13834463.63	DRIVEWAY
307	3119315.17	13834480.49	DRIVEWAY
308	3119049.84	13834526.51	DRIVEWAY
309	3119043.77	13834554.28	DRIVEWAY
310	3119079.29	13834609.24	DRIVEWAY
311	3119103.11	13834646.24	DRIVEWAY
312	NOT USED	and a 2 - option representation and the control of	
313	NOT USED		and the second s
314	NOT USED		COP 4 DE TITLE DE LE COLONIO DE C
315	NOT USED		
316	3119122.98	13834633.37	DRIVEWAY
317	3119110.50	13834617.30	DRIVEWAY

400	3119324.60	13834944.88	PARKING LOT
401	3119414.21	13834886.89	PARKING LOT
402	3119442.74	13834868.40	PARKING LOT
403	3119532.59	13834810.26	PARKING LOT
404	3119429.52	13834651.84	PARKING LOT
405	3119360.18	13834545.97	PARKING LOT
406	3119352.69	13834536.24	PARKING LOT
407	3119336.19	13834517.90	PARKING LOT
408	3119332.45	13834513.44	PARKING LOT
409	3119322.12	13834498.87	PARKING LOT
410	3119308.35	13834479.16	PARKING LOT
411	3119297.52	13834463.12	PARKING LOT
412	3119294.47	13834457.37	PARKING LOT
413	3119283.51	13834436.48	PARKING LOT
414	3119264.42	13834406.99	PARKING LOT
415	3119060.27	13834536.48	PARKING LOT
416	3119262.53	13834464.05	PARKING LOT
417	3119269.23	13834460.18	PARKING LOT
418	3119272.79	13834467.67	PARKING LOT
419	3119277.81	13834475.88	PARKING LOT
420	3119285.01	13834487.66	PARKING LOT
421	3119271.13	13834507.95	PARKING LOT
422	3119245.84	13834502.53	PARKING LOT
423	3119109.62	13834563.04	PARKING LOT
424	3119124.96	13834580.79	PARKING LOT
425	3119145.38	13834590.40	PARKING LOT
426	3119126.88	13834595.23	PARKING LOT
427	3119304.52	13834515.54	PARKING LOT
428	3119309.97	13834531.51	PARKING LOT
429	3119142.78	13834608.76	PARKING LOT
430	3119151.06	13834632.58	PARKING LOT
431	3119333.54	13834550.83	PARKING LOT
432	3119337.50	13834566.12	PARKING LOT

CURVE DATA				
CURVE NO.	R	L	D	A
C1	56'	8.60'	102.31	8*47'56"
C2	80'	12.29'	71.62'	8'48'07"
C3	39'	5.83'	149.91'	8*33'54"
C4	80'	12.28'	71.62'	8'47'42"


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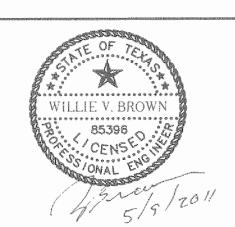
#### LEGEND:

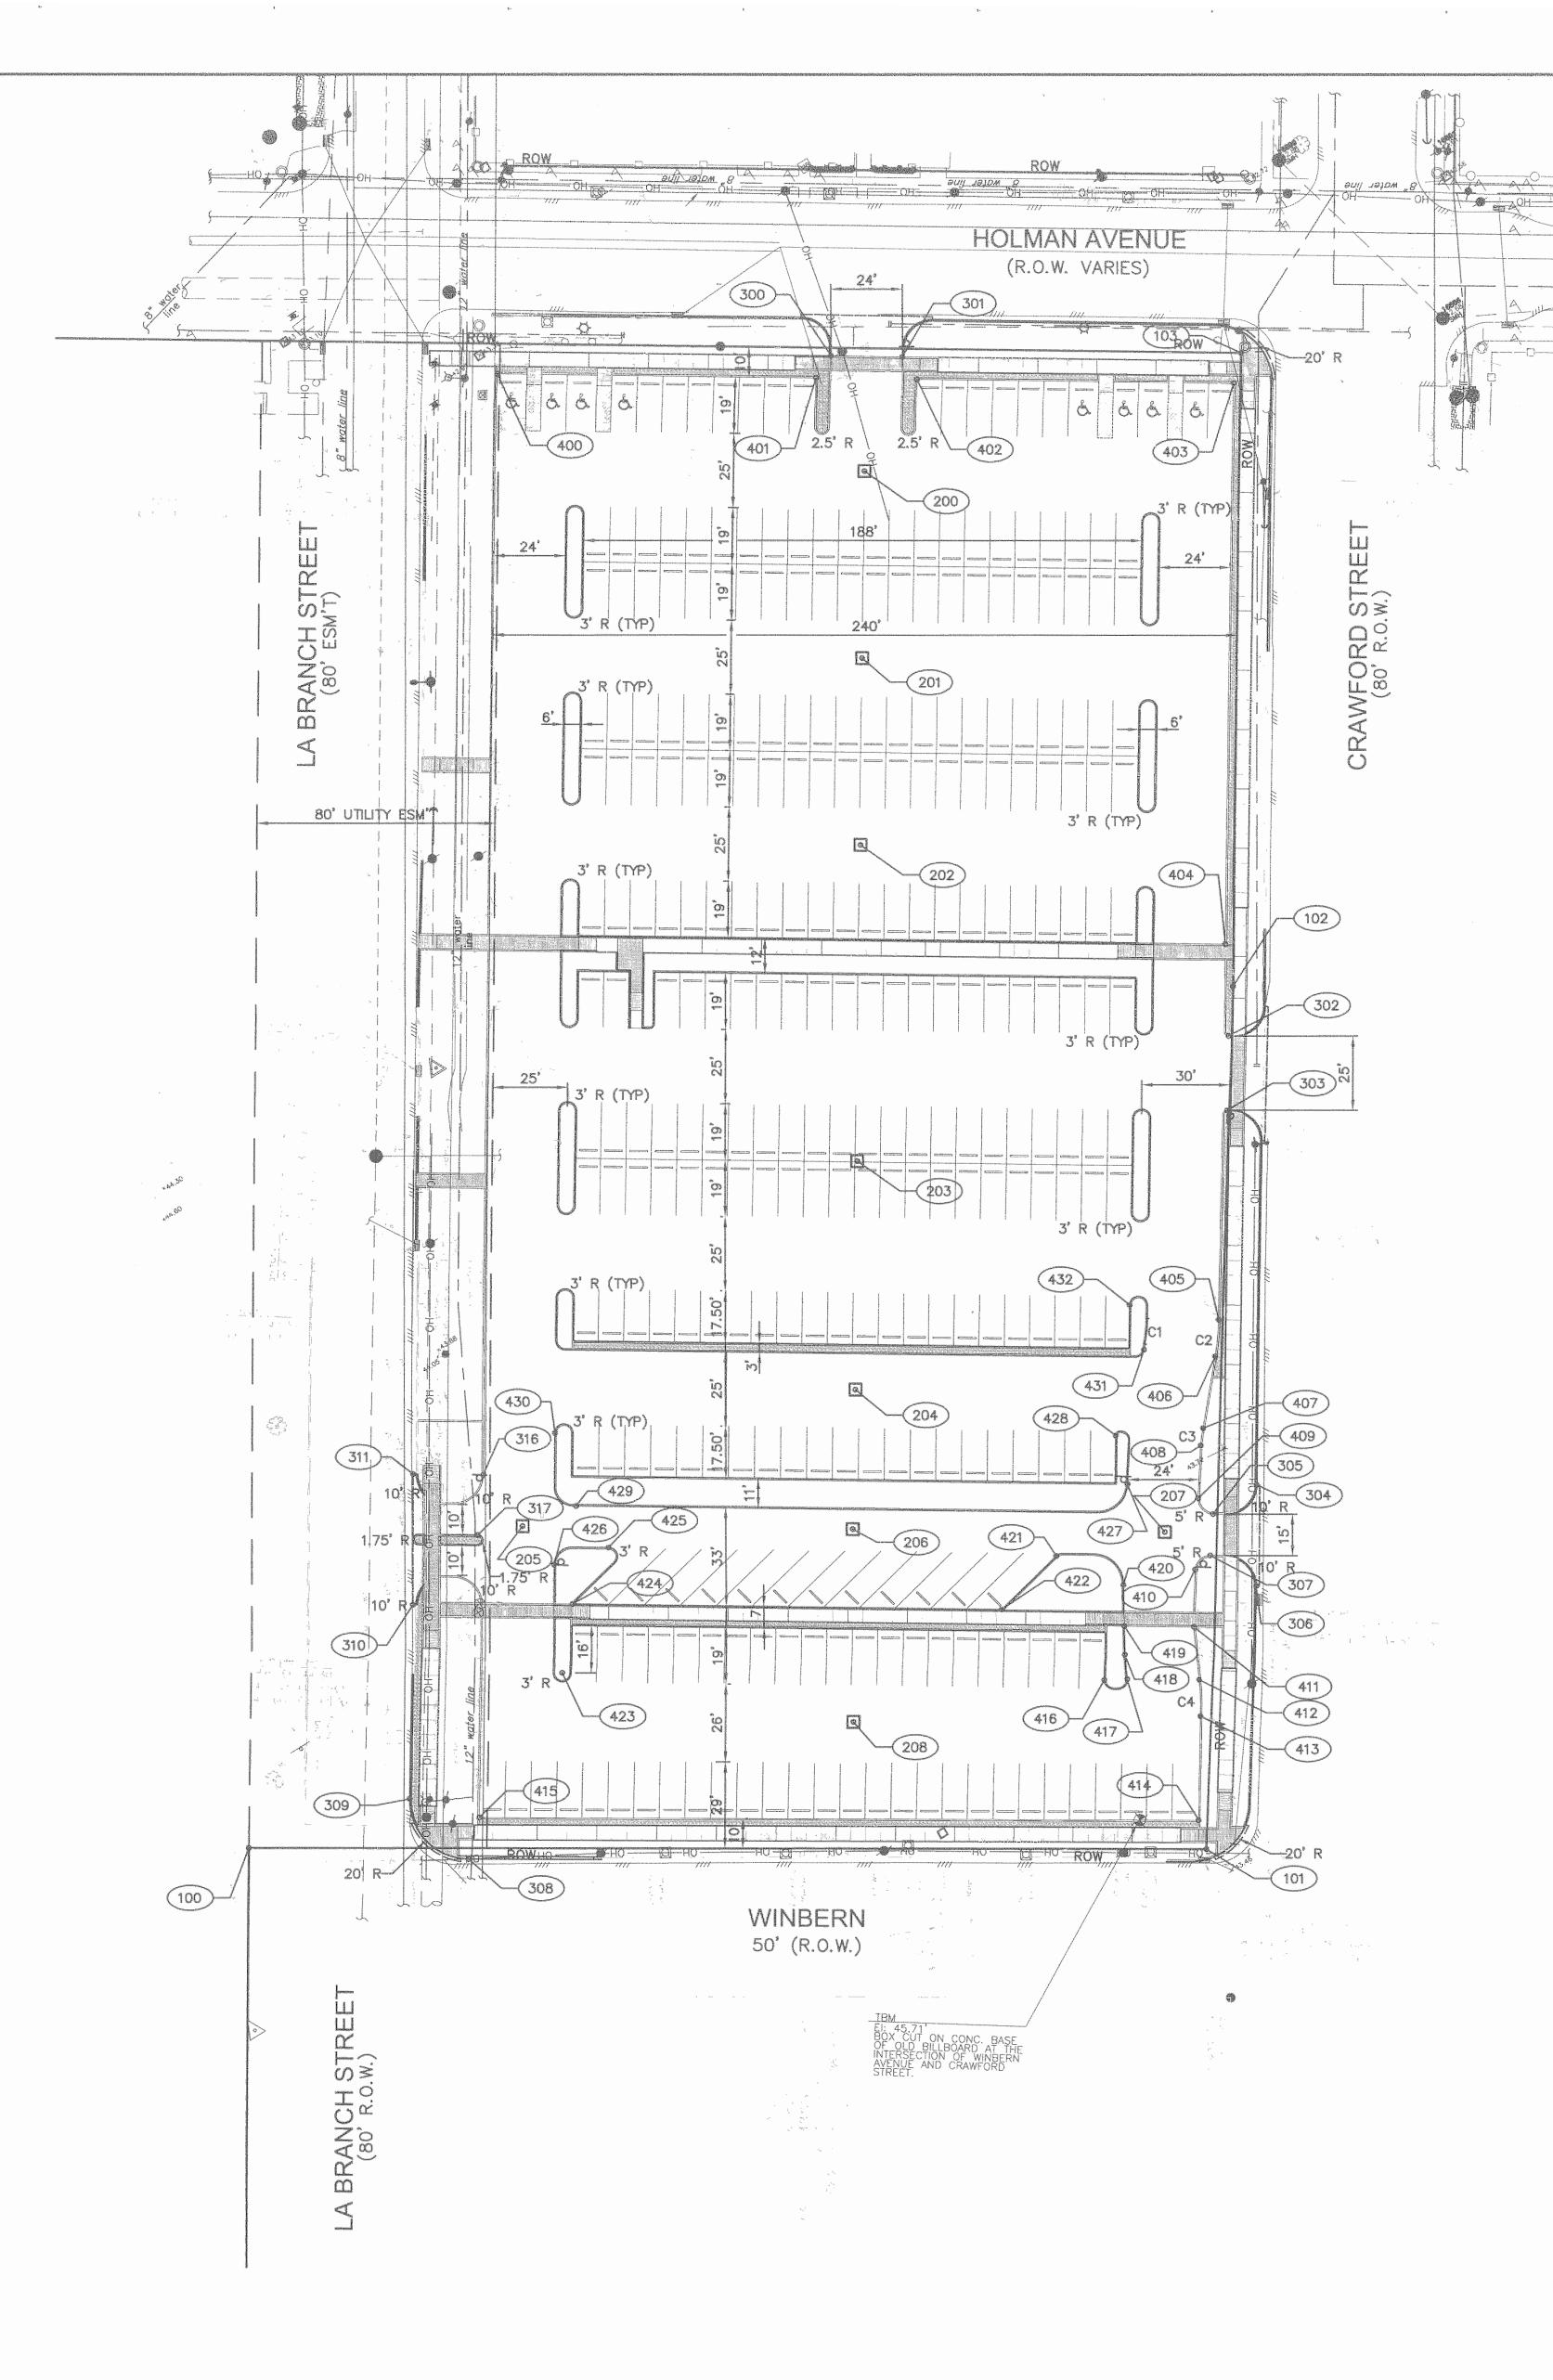(XXX)	REFERENCE NUMBER
Sources of States of State	PROP AREA INLET
	EXIST STM SWR MH
	EXIST TYPE "A" INLET
**************************************	EXIST SAN SWR MH  POWER POLE  B OR BB INLET  POST
D.	FIRE DEPARTMENT CONNECTIONS
	BUILDING WOOD FENCE
	CHAIN LINK FENCE  OVERHEAD LINE  UNDERGROUND LINE
[MB] GM)	MAILBOX GAS METER
HC	HANDICAP
<ul><li>O</li></ul>	FOUND IRON ROD FOUND IRON PIPE
PG. H.C.C.F. H.C.F.C.D. H.C.M.R. H.C.D.R. B.L. U.E.	BUILDING LINE UTILITY EASEMENT
FF $\langle \overline{R} \rangle$	FINISH FLOOR FROM RECORD DRAWINGS
1	FLECTRICAL UNDERGROUND CABLES WERE
(2)	UNABLE TO BE LOCATED  UNDERGROUND CABLES TO BUILDING, UNABLE TO LOCATE
(3)	UNDERGROUND WATER LINES WERE UNABLE TO BE LOCATED
4	UNABLE TO LOCATE ANY UNDERGROUND LIN

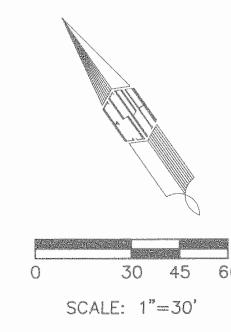

#### Houston Community College


HCC - Construction Department 3100 Main, 12th Floor Houston, Texas, 77002 Voice: 713.718.5168 reynaldo.pradia@hccs.edu

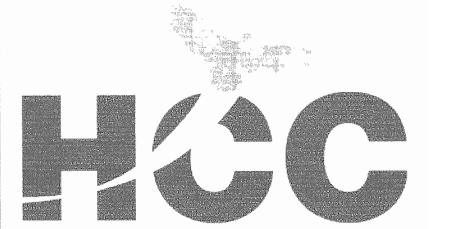

REV	DESCRIPTION	DATE	BY
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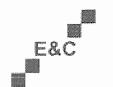
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E&C Engineers & Consultants Inc 1010 Lamar, #650 Houston, Texas 77002 713 580.8800 713 580 8888 Fax

Central Campus
Parking Lot Improvements

1300 Holman Street Houston, TX 77004

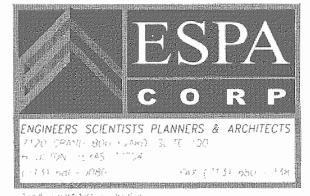A/E Project No.:

Contract No.:
Drawn By:
Checked By:
Approved By:


Ownership of Instruments of Service:


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HORIZONTAL CONTROL

Scale: 1"=30'

C-8.0




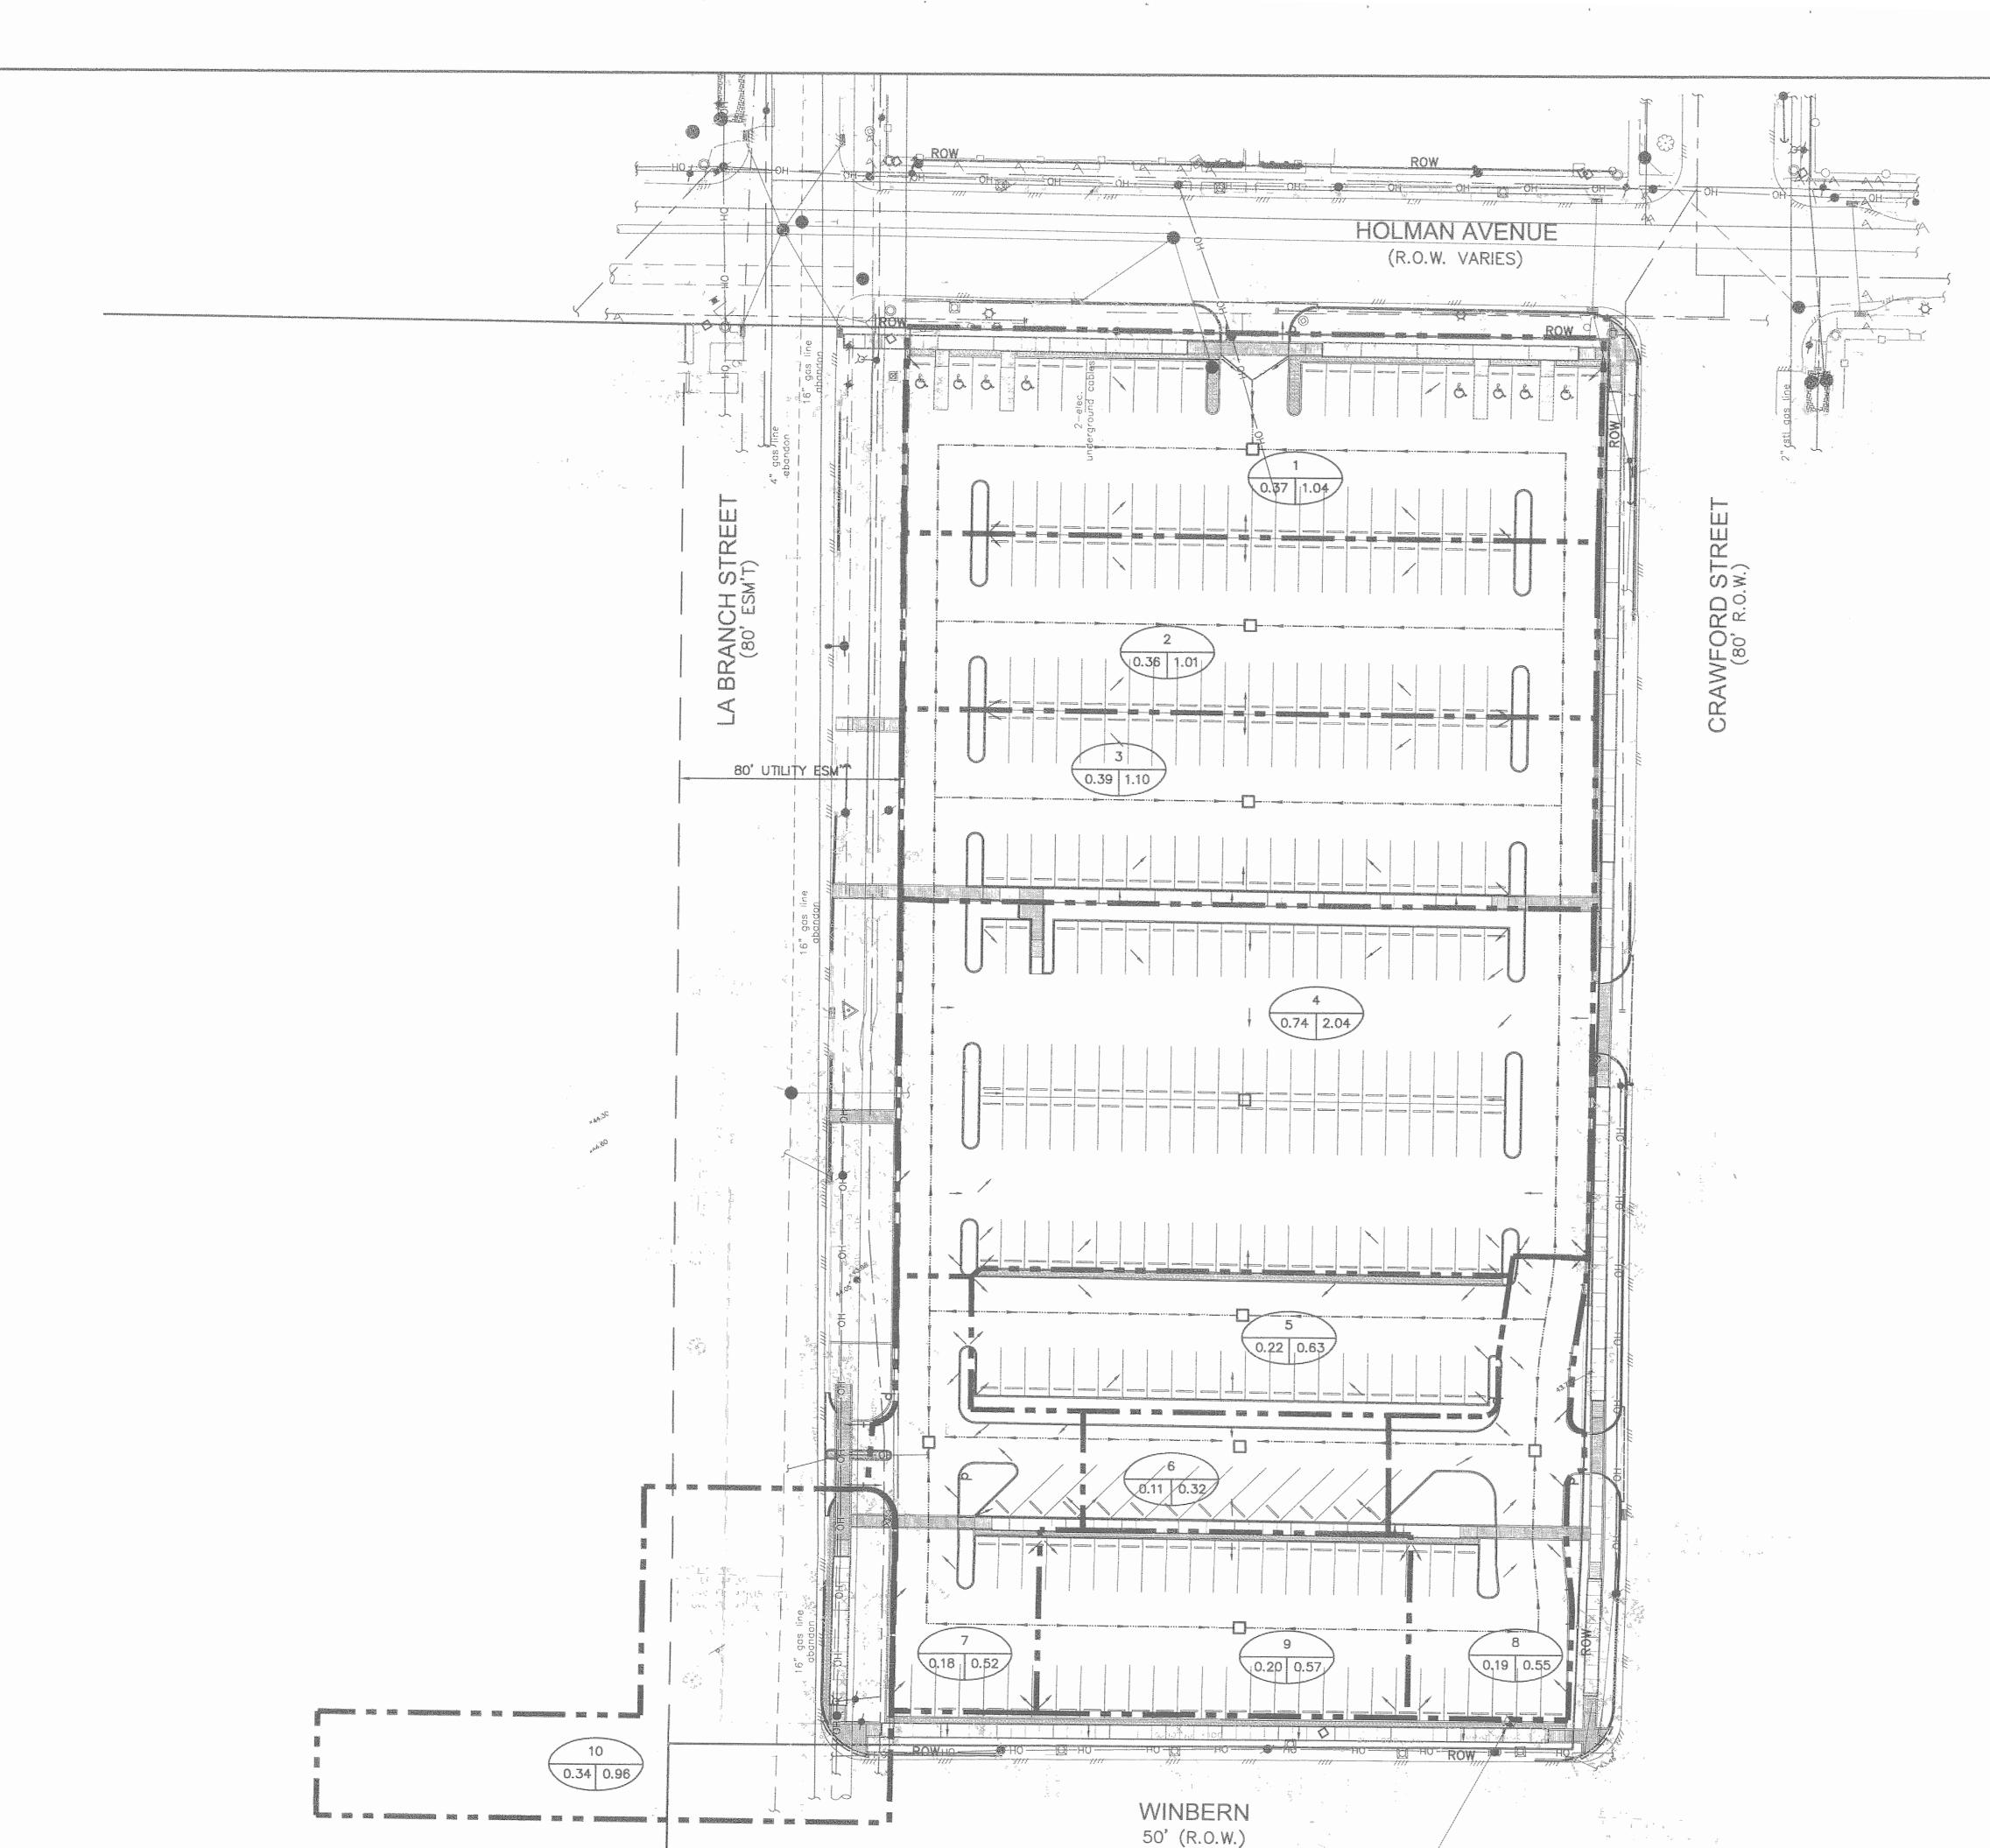
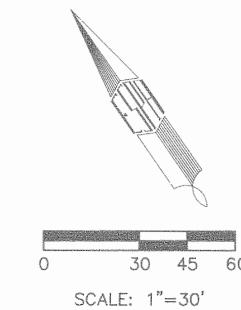
#### BENCHMARK:

- 1. ALL ELEVATIONS SHOWN HEREON ARE REFERENCED TO THE NORTH AMERICAN VERTICAL DATUM OF 1988 (NAVD) (2001 ADJ.)
- 2. TEMPORARY BENCHMARK (T.B.M.) ELEV 45.71' A BOX CUT ON CONC. BASE OF OLD BILLBOARD AT THE INTERSECTION OF WINBERN AVENUE AND CRAWFORD STREET.
- 3. THE SUBJECT PROPERTY IS LOCATED IN ZONE X ACCORDING TO FEMA FLOOD INSURANCE RATE MAP NO. 48201C0880L, REVISED JUNE 18, 2007

#### LEGEND

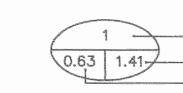

-DRAINAGE AREA -RUNOFF (CFS) -AREA (ACRES)

]	PROP	AREA INLET
	EXIST	STM SWR MH
	FYICT	TYDE "A" INII E

DRAINAGE AREA BOUNDARY

EXIST TYPE "A" INLET

EXIST SAN SWR MH

POWER POLE

B OR BB INLET

POST

FIRE DEPARTMENT

CONNECTIONS

BUILDING

WOOD FENCE

CHAIN LINK FENCE

OVERHEAD LINE

UNDERGROUND LINE

MAILBOX

MAILBOX
GAS METER

HC HANDICAP

FOUND IRON ROD

FOUND IRON PIPE

UNDERGROUND CABLE MARKER

SET MONUMENTS BY TERAN CROUP

PARKING METER

PL
PROPERTY LINE

VOL.
VOLUME

PG.
PAGE

H.C.C.F.
HARRIS COUNTY CLERK'S FILE

H.C.F.C.D
HARRIS COUNTY FLOOD CONTROL DISTRICT

H.C.M.R.
HARRIS COUNTY MAP RECORDS

H.C.D.R.
BUILDING LINE

UTILITY EASEMENT

FINISH FLOOR

FROM RECORD DRAWINGS

ELECTRICAL UNDERGROUND CABLES WERE UNABLE TO BE LOCATED


UNDERGROUND CABLES TO BUILDING, UNABLE TO LOCATE

UNDERGROUND WATER LINES WERE UNABLE TO BE LOCATED

UNABLE TO LOCATE ANY UNDERGROUND LINE

#### Houston Community College

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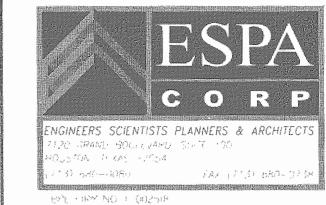


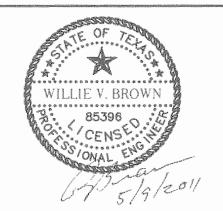Issu	e/Revision:		
REV	DESCRIPTION	DATE	B
1	ISSUED FOR BID & CONSTRUCTION	05/09/11	JA
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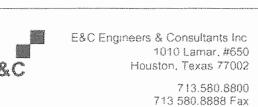
architecture + planning + design 5120 Woodway, Suite 8010

Houston, TX 77056 p: 713.850.1500 f: 713.850.1023 e: info@theldnet.com



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> STUDIO OF RICHARD JETER MEA LIGHTING DESIGNER 15903 PEBBLE BEND DR. HOUSTON, TEXAS 77068



## Central Campus Parking Lot Improvements

1300 Holman Street Houston, TX 77004

1		
	Contract No.:	A/E Project No
	Drawn By:	Date:
	Checked By:	Date:
	Approved By:	Date:

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Ownership of Instruments of Service:

#### DRAINAGE AREA MAP


Scale: 1"=30'

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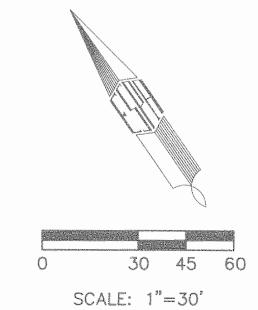
DRAINAGE TABLE

 Line
 Toline (ft)
 Line Length (ft)
 Incr. Area (ac)
 Total Control (C)
 Incr. Area (min)
 Total Control (min)
 Total Runoff (ft)
 AdniFlow (cfs)
 Total Flow (cfs)
 CapacFull (cfs)
 Veloc (fts)
 PipeSlope (inv ElevUp (m)
 Inv ElevDn (ft)
 HGLDp (ft)

F: \2166-024\C9.0 Damp.dwg Plotted: May 12, 2011 - 3:17pm by lloyd

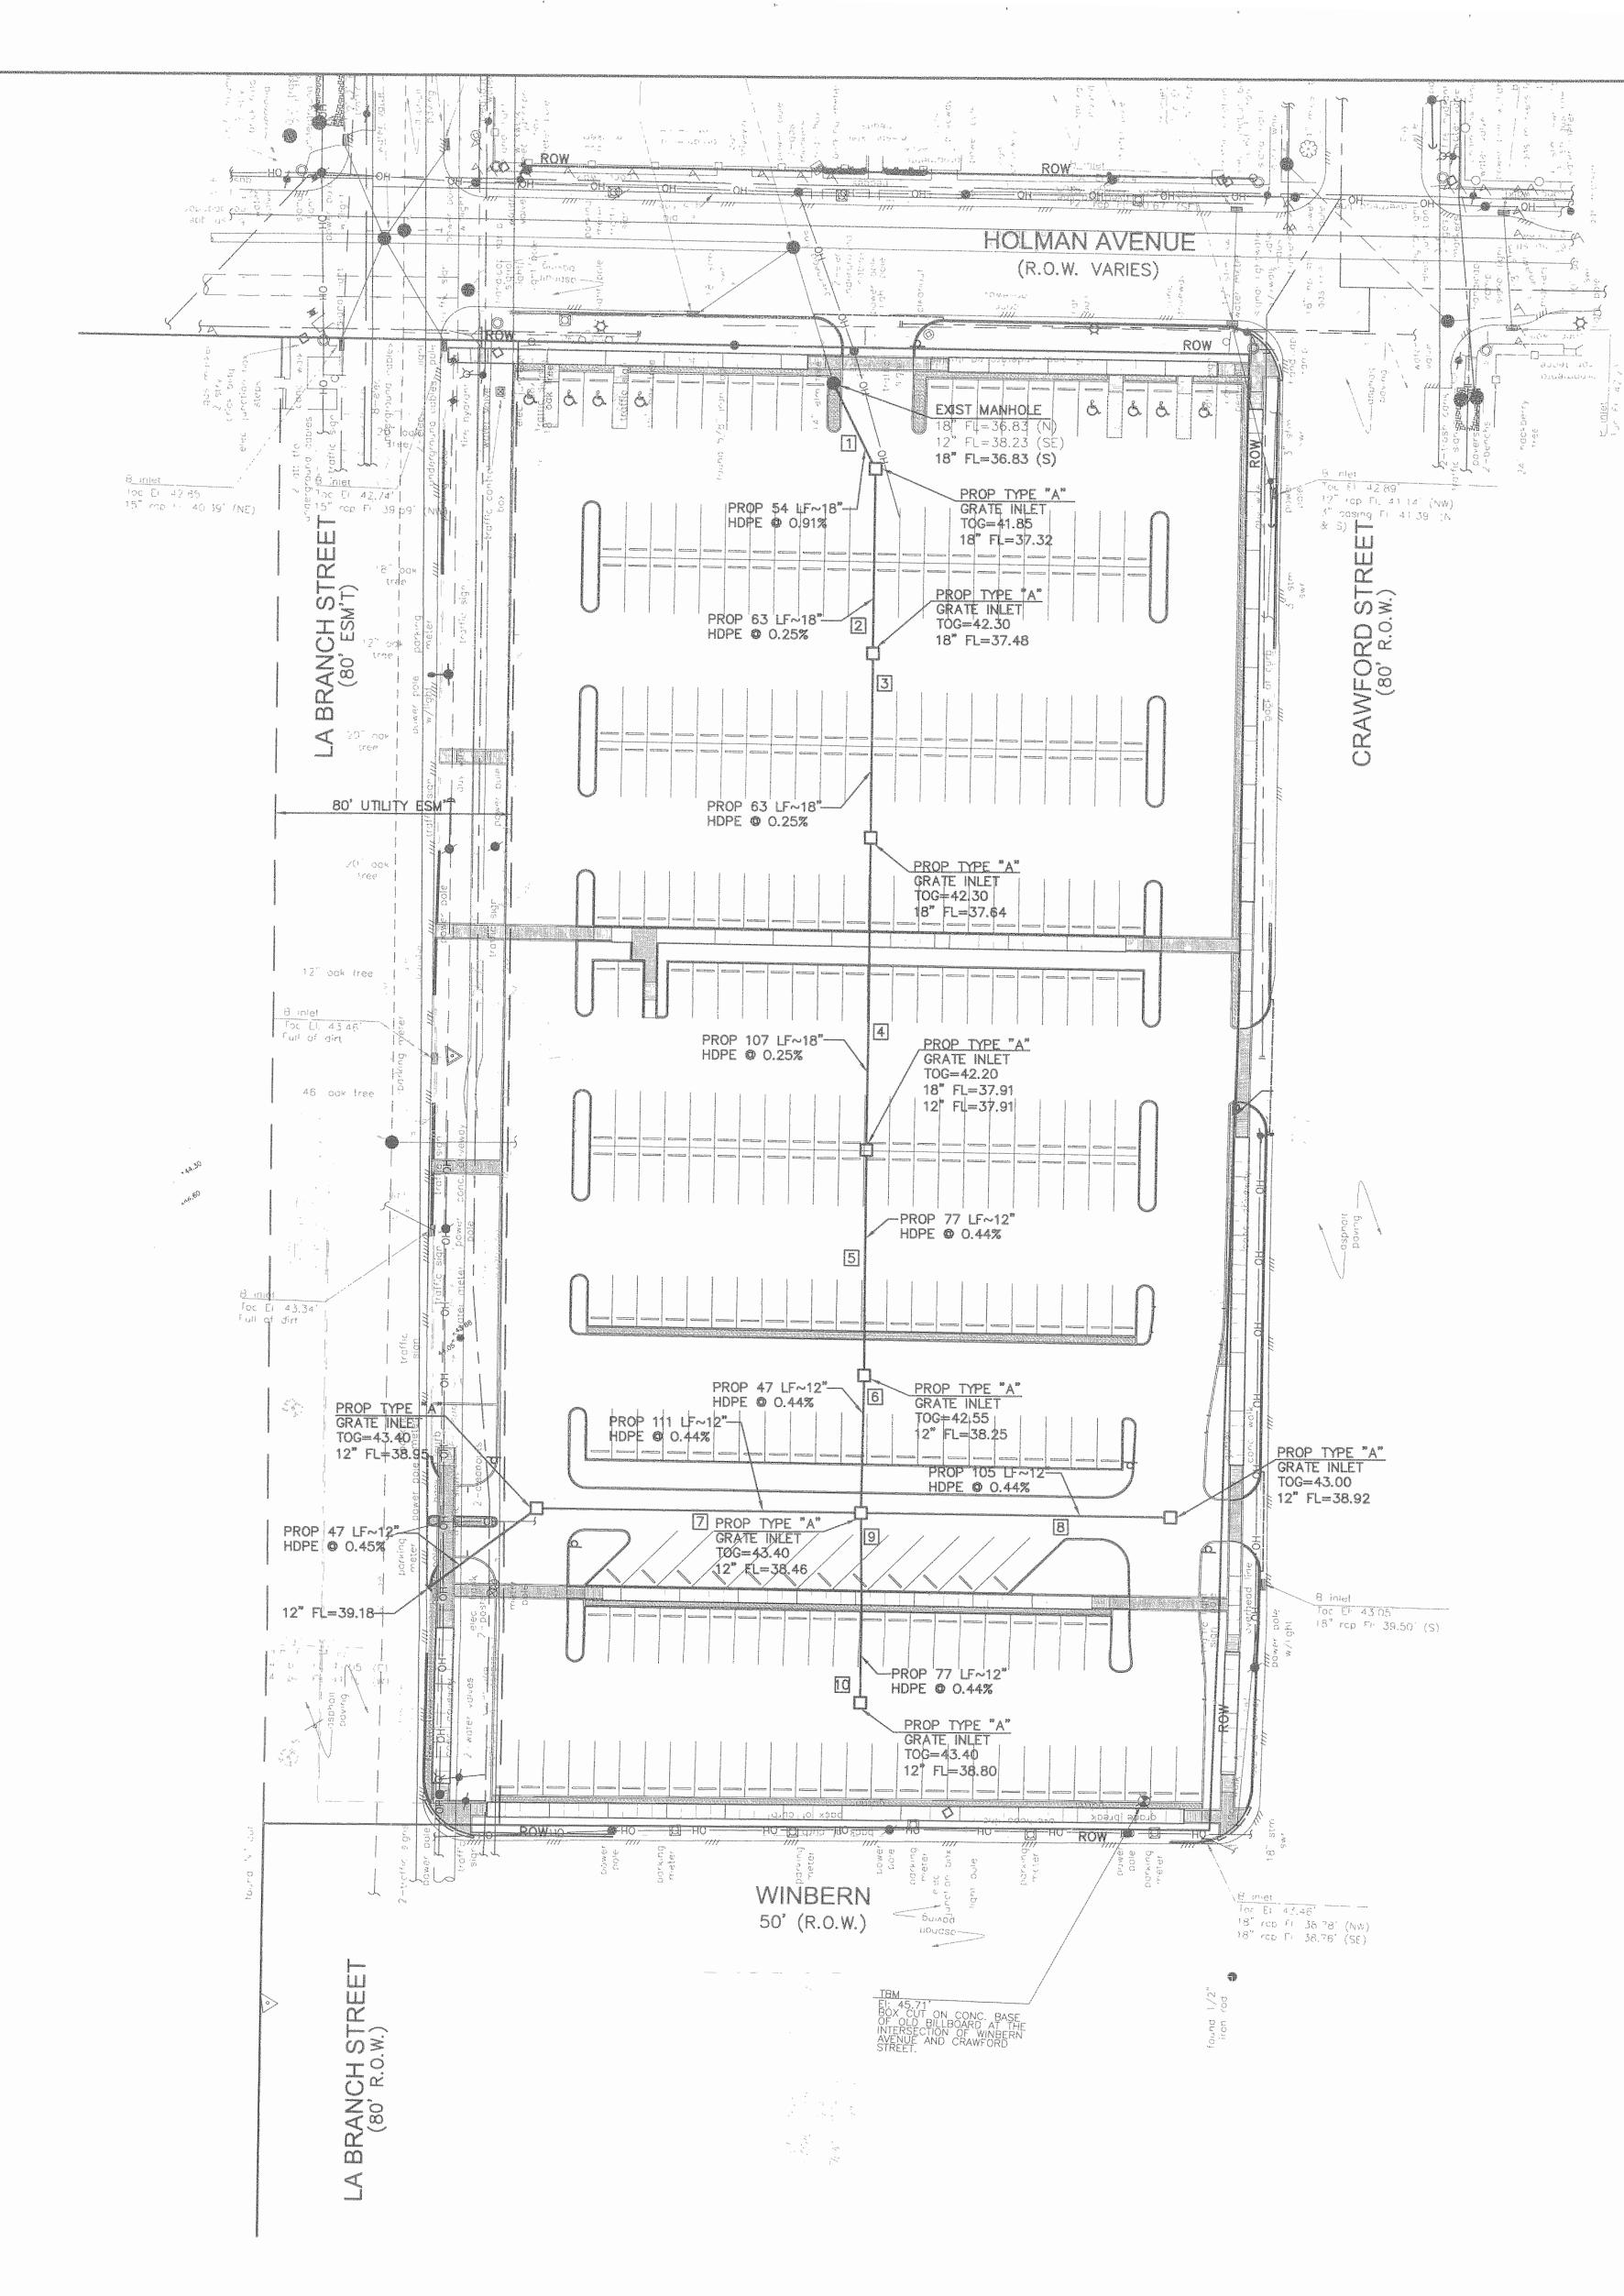

F:\2166-024\C10.0 Storm Sewer Layout.dwg Plotted: May 12, 2011 - 3:19pm by lloyd



#### BENCHMARK:

- 1. ALL ELEVATIONS SHOWN HEREON ARE REFERENCED TO THE NORTH AMERICAN VERTICAL DATUM OF 1988 (NAVD) (2001 ADJ.)
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- 3. THE SUBJECT PROPERTY IS LOCATED IN ZONE X ACCORDING TO FEMA FLOOD INSURANCE RATE MAP NO. 48201C0880L, REVISED JUNE 18, 2007

#### LEGEND:

granting granting grant	PROP AREA INLET
1	STORM SEWER LINE NUMBER
	EXIST STM SWR MH
	EXIST TYPE "A" INLET
	EXIST SAN SWR MH POWER POLE B OR BB INLET POST
	FIRE DEPARTMENT CONNECTIONS BUILDING
——————————————————————————————————————	WOOD FENCE CHAIN LINK FENCE OVERHEAD LINE UNDERGROUND LINE
(GM)	MAILBOX GAS METER
HC	HANDICAP
<ul><li>•</li><li>•</li></ul>	FOUND IRON ROD FOUND IRON PIPE
PL VOL. PG H.C.C.F. H.C.F C.D. H.C.M.R. H.C.D.R. B.L. U.E. FF	UNDERGROUND CABLE MARKER  SET MONUMENTS BY TERAN GROUP  PARKING METER  PROPERTY LINE  VOLUME  PAGE  HARRIS COUNTY CLERK'S FILE  HARRIS COUNTY FLOOD CONTROL DISTRICT  HARRIS COUNTY MAP RECORDS  HARRIS COUNTY DEED RECORDS  BUILDING LINE  UTILITY EASEMENT  FINISH FLOOR
R	FROM RECORD DRAWINGS
<ol> <li>2</li> </ol>	ELECTRICAL UNDERGROUND CABLES WERE UNABLE TO BE LOCATED UNDERGROUND CABLES TO BUILDING, UNABLE TO LOCATE
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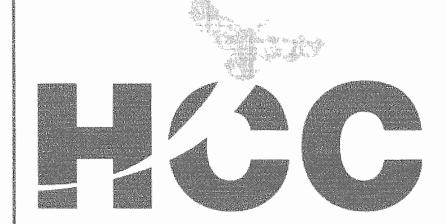
UNDERGROUND WATER LINES WERE UNABLE TO BE LOCATED

UNABLE TO LOCATE ANY UNDERGROUND LINE

DETENTION CALCULATIONS


TOTAL DEVELOPED AREA=2.788 AC
EXISTING IMPERVIOUS COVER=2.772 AC
PROPOSED IMPERVIOUS COVER=2.348 AC

THE IMPERVIOUS COVER IS BEING REDUCED
BY 0.424 ACRES. THEREFORE, DETENTION
IS NOT WARRANTED FOR THE PROPOSED
PARKING LOT.



#### Houston Community College

HCC - Construction Department 3100 Main, 12th Floor Houston, Texas, 77002 Voice: 713.718.5168 reynaldo.pradia@hccs.edu

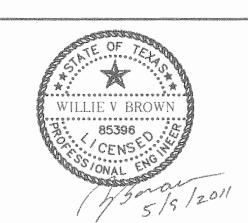

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#### Ilewelyn-davies sahni

architecture + planning + design


5120 Woodway, Suite 8010

Houston, TX 77056

p: 713.850.1500


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> STUDIO OF RICHARD JETER MFA LIGHTING DESIGNER 15903 PEBBLE BEND DR. HOUSTON, TEXAS 77068

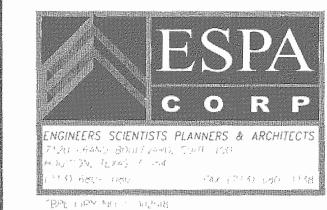

# Central Campus Parking Lot Improvements

1300 Holman Street Houston, TX 77004


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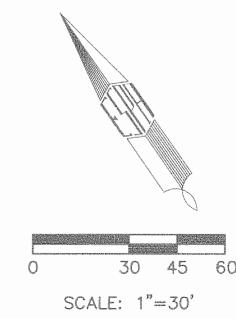
#### STORM SEWER LAYOUT

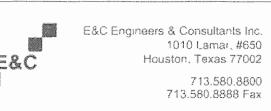Scale: 1"=30'


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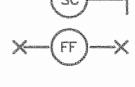


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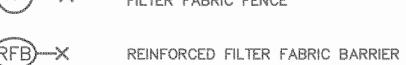


COARSE AGGREGATE PAD
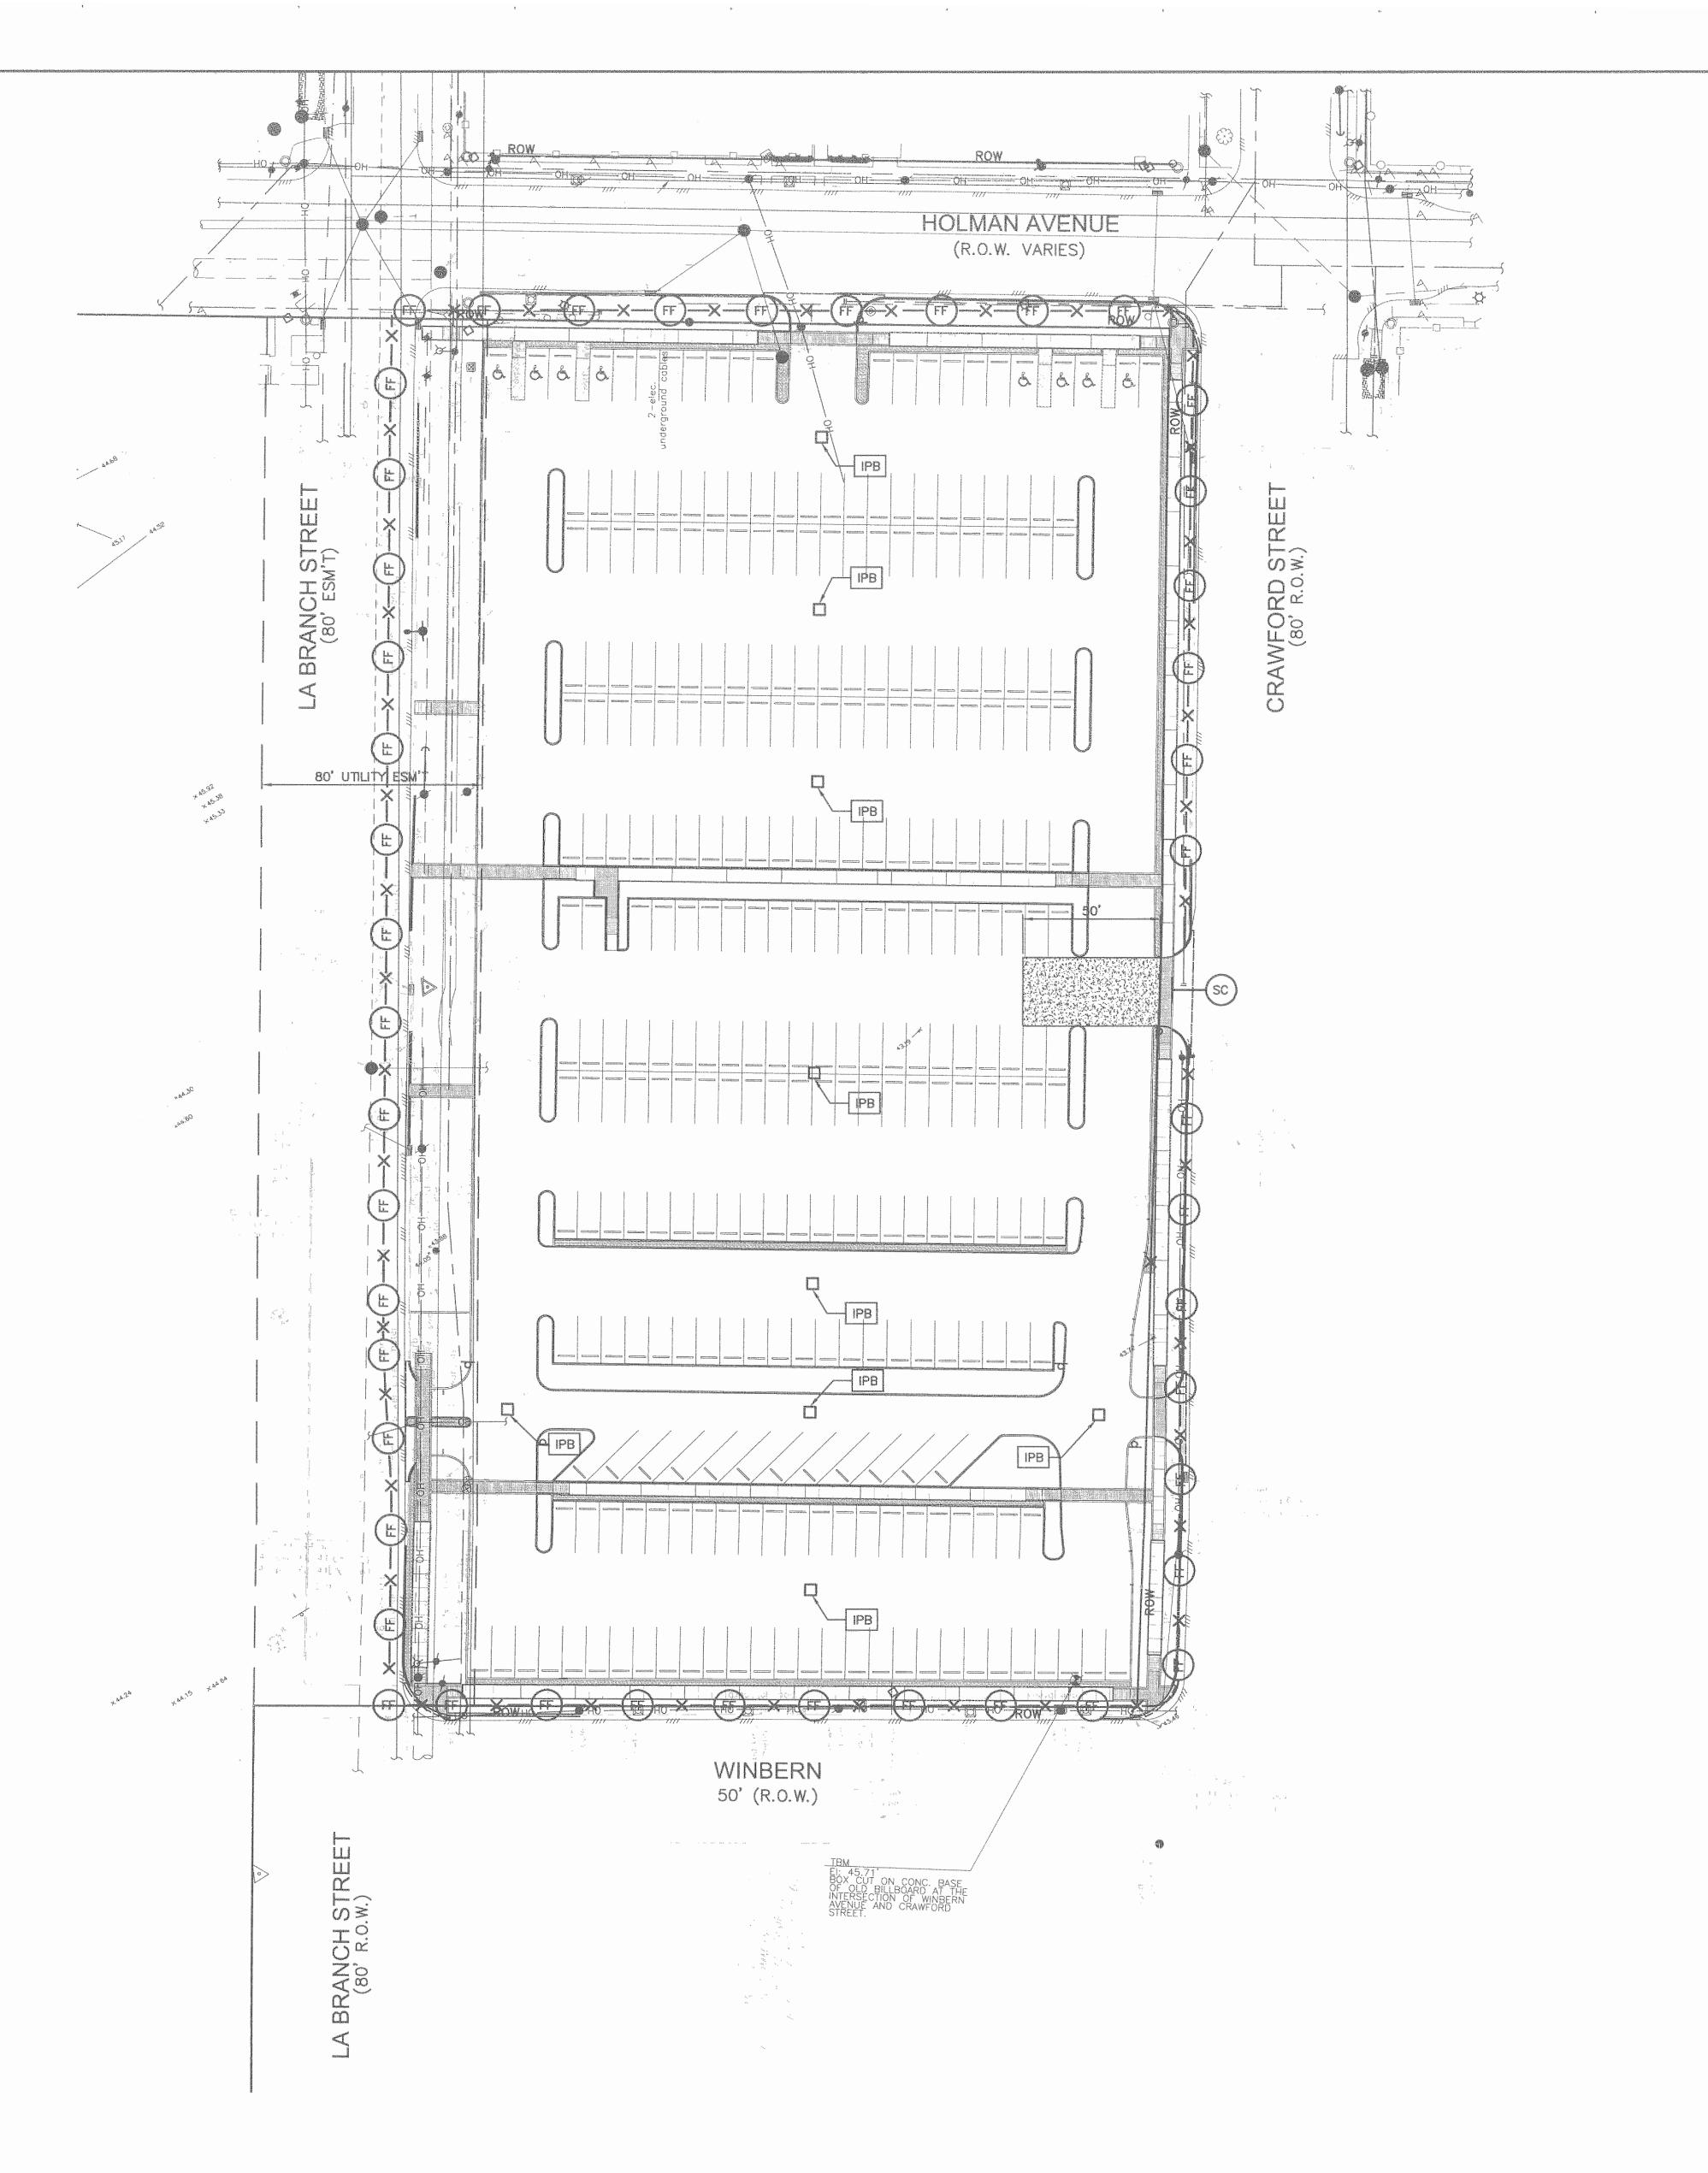
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FILTER FABRIC FENCE

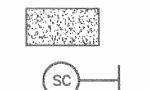

INLET PROTECTION BARRIER

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EXIST STM SWR MH

EXIST TYPE "A" INLE

EXIST SAN SWR MH

POWER POLE

B OR BB INLET

POST

FIRE DEPARTMENT CONNECTIONS

BUILDING

WOOD FENCE

CHAIN LINK FENCE

OVERHEAD LINE
UNDERGROUND LINE
MAILBOX
GAS METER
HANDICAP
FOUND IRON ROD
FOUND IRON PIPE

UNDERGROUND CABLE MARKER

SET MONUMENTS BY TERAN GROUP

PARKING METER

PARKING METER

PROPERTY LINE

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HARRIS COUNTY CLERK'S FILE

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HARRIS COUNTY FLOOD CONTROL DISTRICT
HARRIS COUNTY MAP RECORDS
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BUILDING LINE
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FINISH FLOOR

UNDERGROUND WATER LINES WERE UNABLE

FROM RECORD DRAWINGS


ELECTRICAL UNDERGROUND CABLES WERE UNABLE TO BE LOCATED

UNDERGROUND CABLES TO BUILDING, UNABLE TO LOCATE



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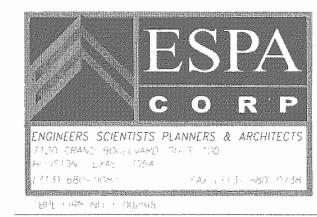


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#### III llewelyn-davies sahni

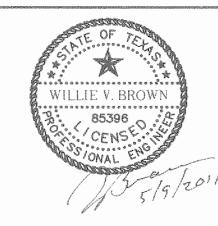architecture + planning + design

5120 Woodway, Suite 8010
Houston, TX 77056
p: 713.850.1500
f: 713.850.1023
e: info@theldnet.com



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E&C Engineers & Consultants Inc 1010 Lamar, #650 Houston, Texas 77002 713 580.8800 713.580.8888 Fax

Central Campus
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1300 Holman Street Houston, TX 77004

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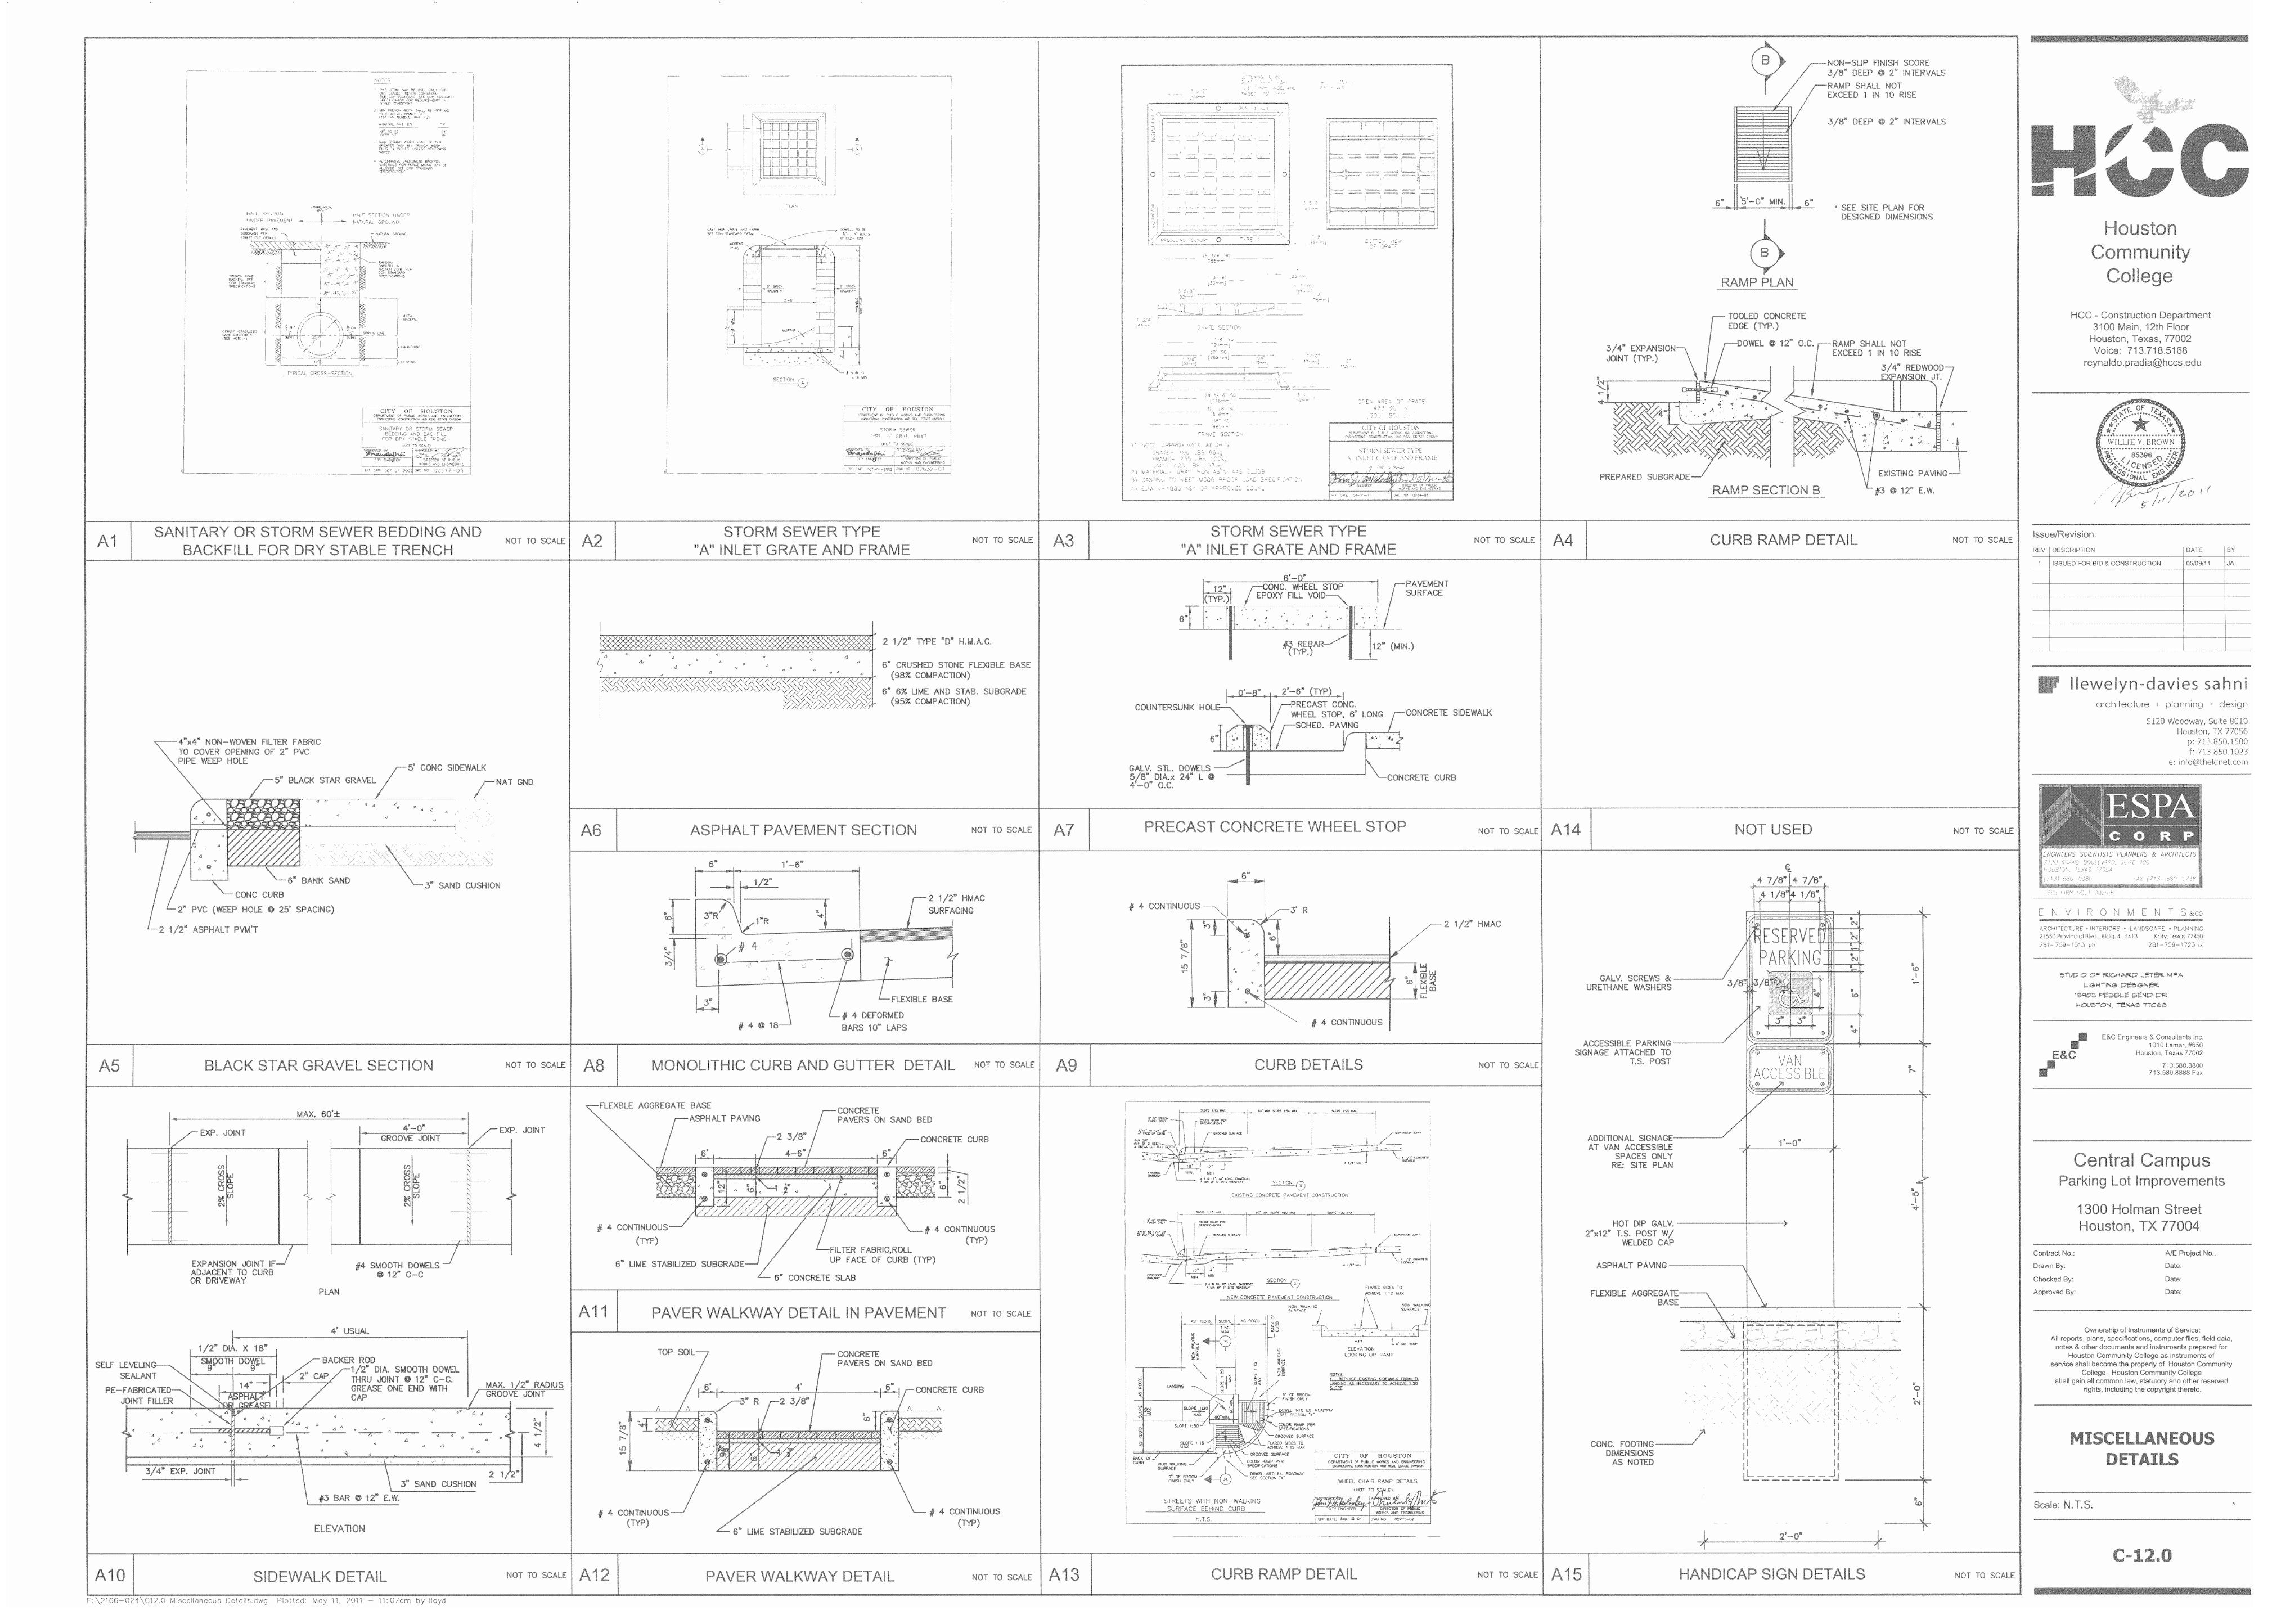
Ownership of Instruments of Service:


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STORM WATER POLLUTION PREVENTION PLAN


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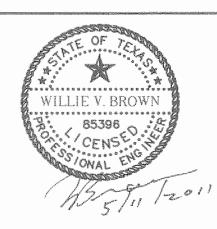


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# Houston Community College


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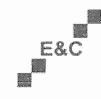
#### III llewelyn-davies sahni

architecture + planning + design
5120 Woodway, Suite 8010
Houston, TX 77056
p: 713.850.1500
f: 713.850.1023
e: info@theldnet.com

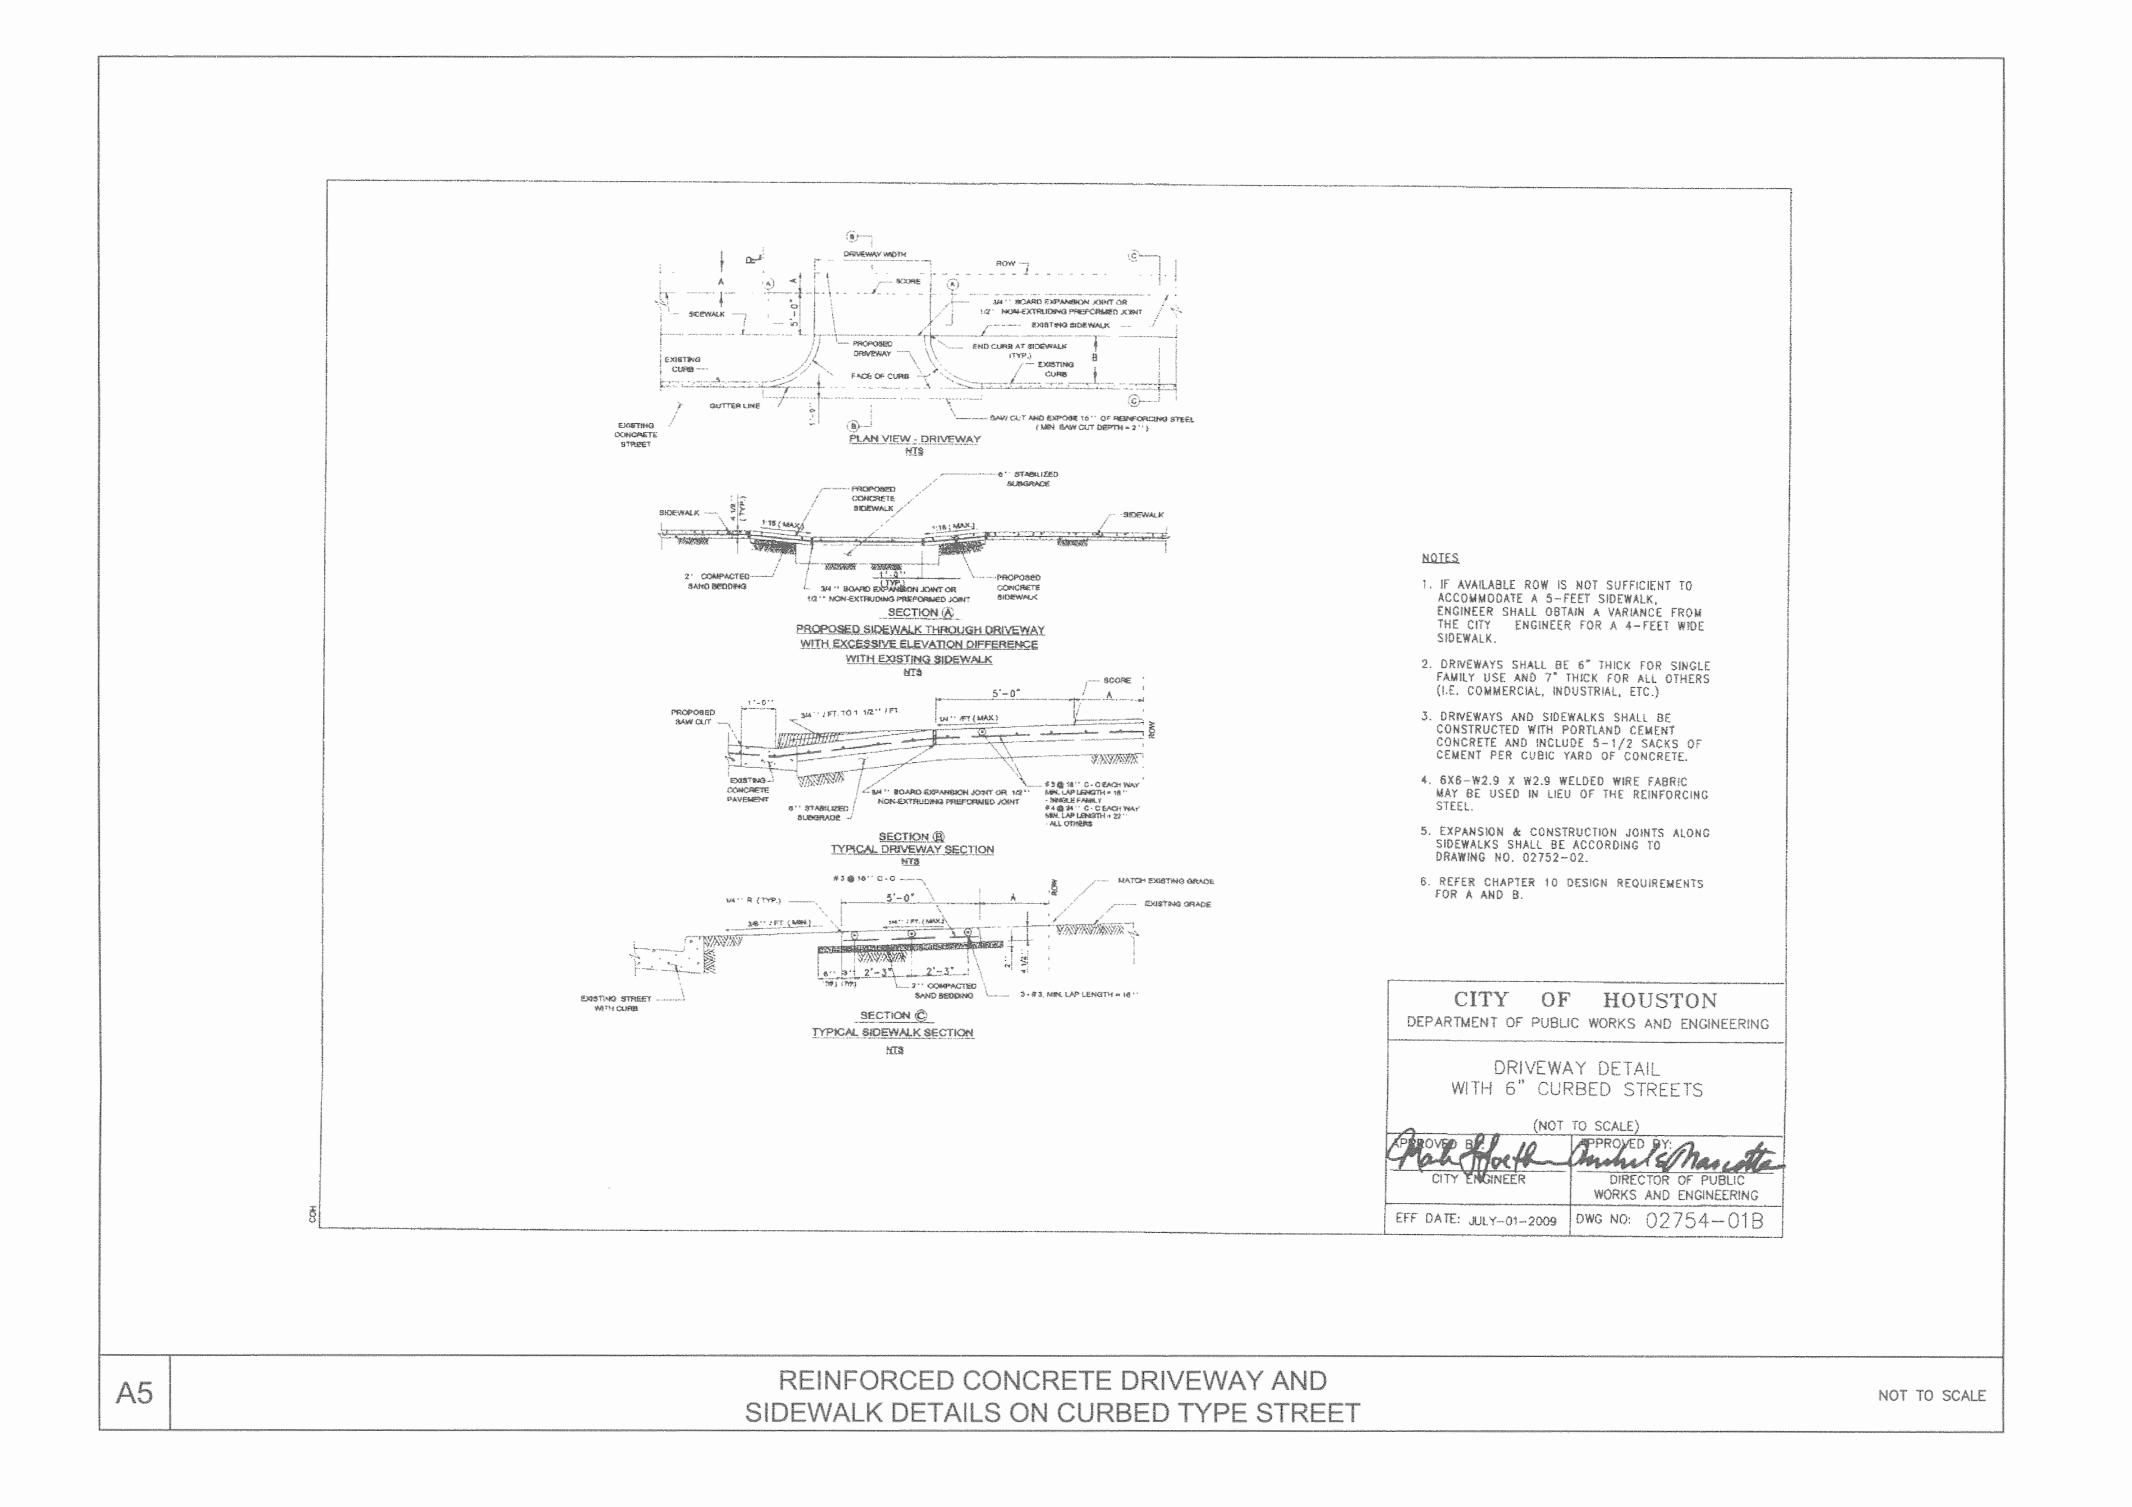
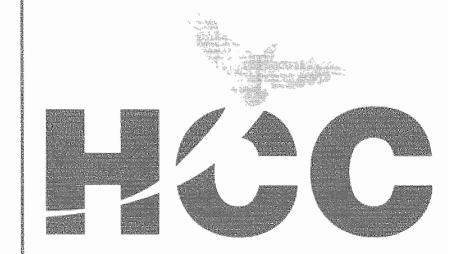
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E&C Engineers & Consultants Inc. 1010 Lamar, #650 Houston, Texas 77002 713.580.8800 713.580.8888 Fax

### Central Campus Parking Lot Improvements

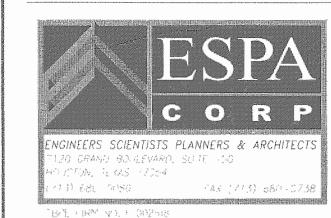1300 Holman Street Houston, TX 77004

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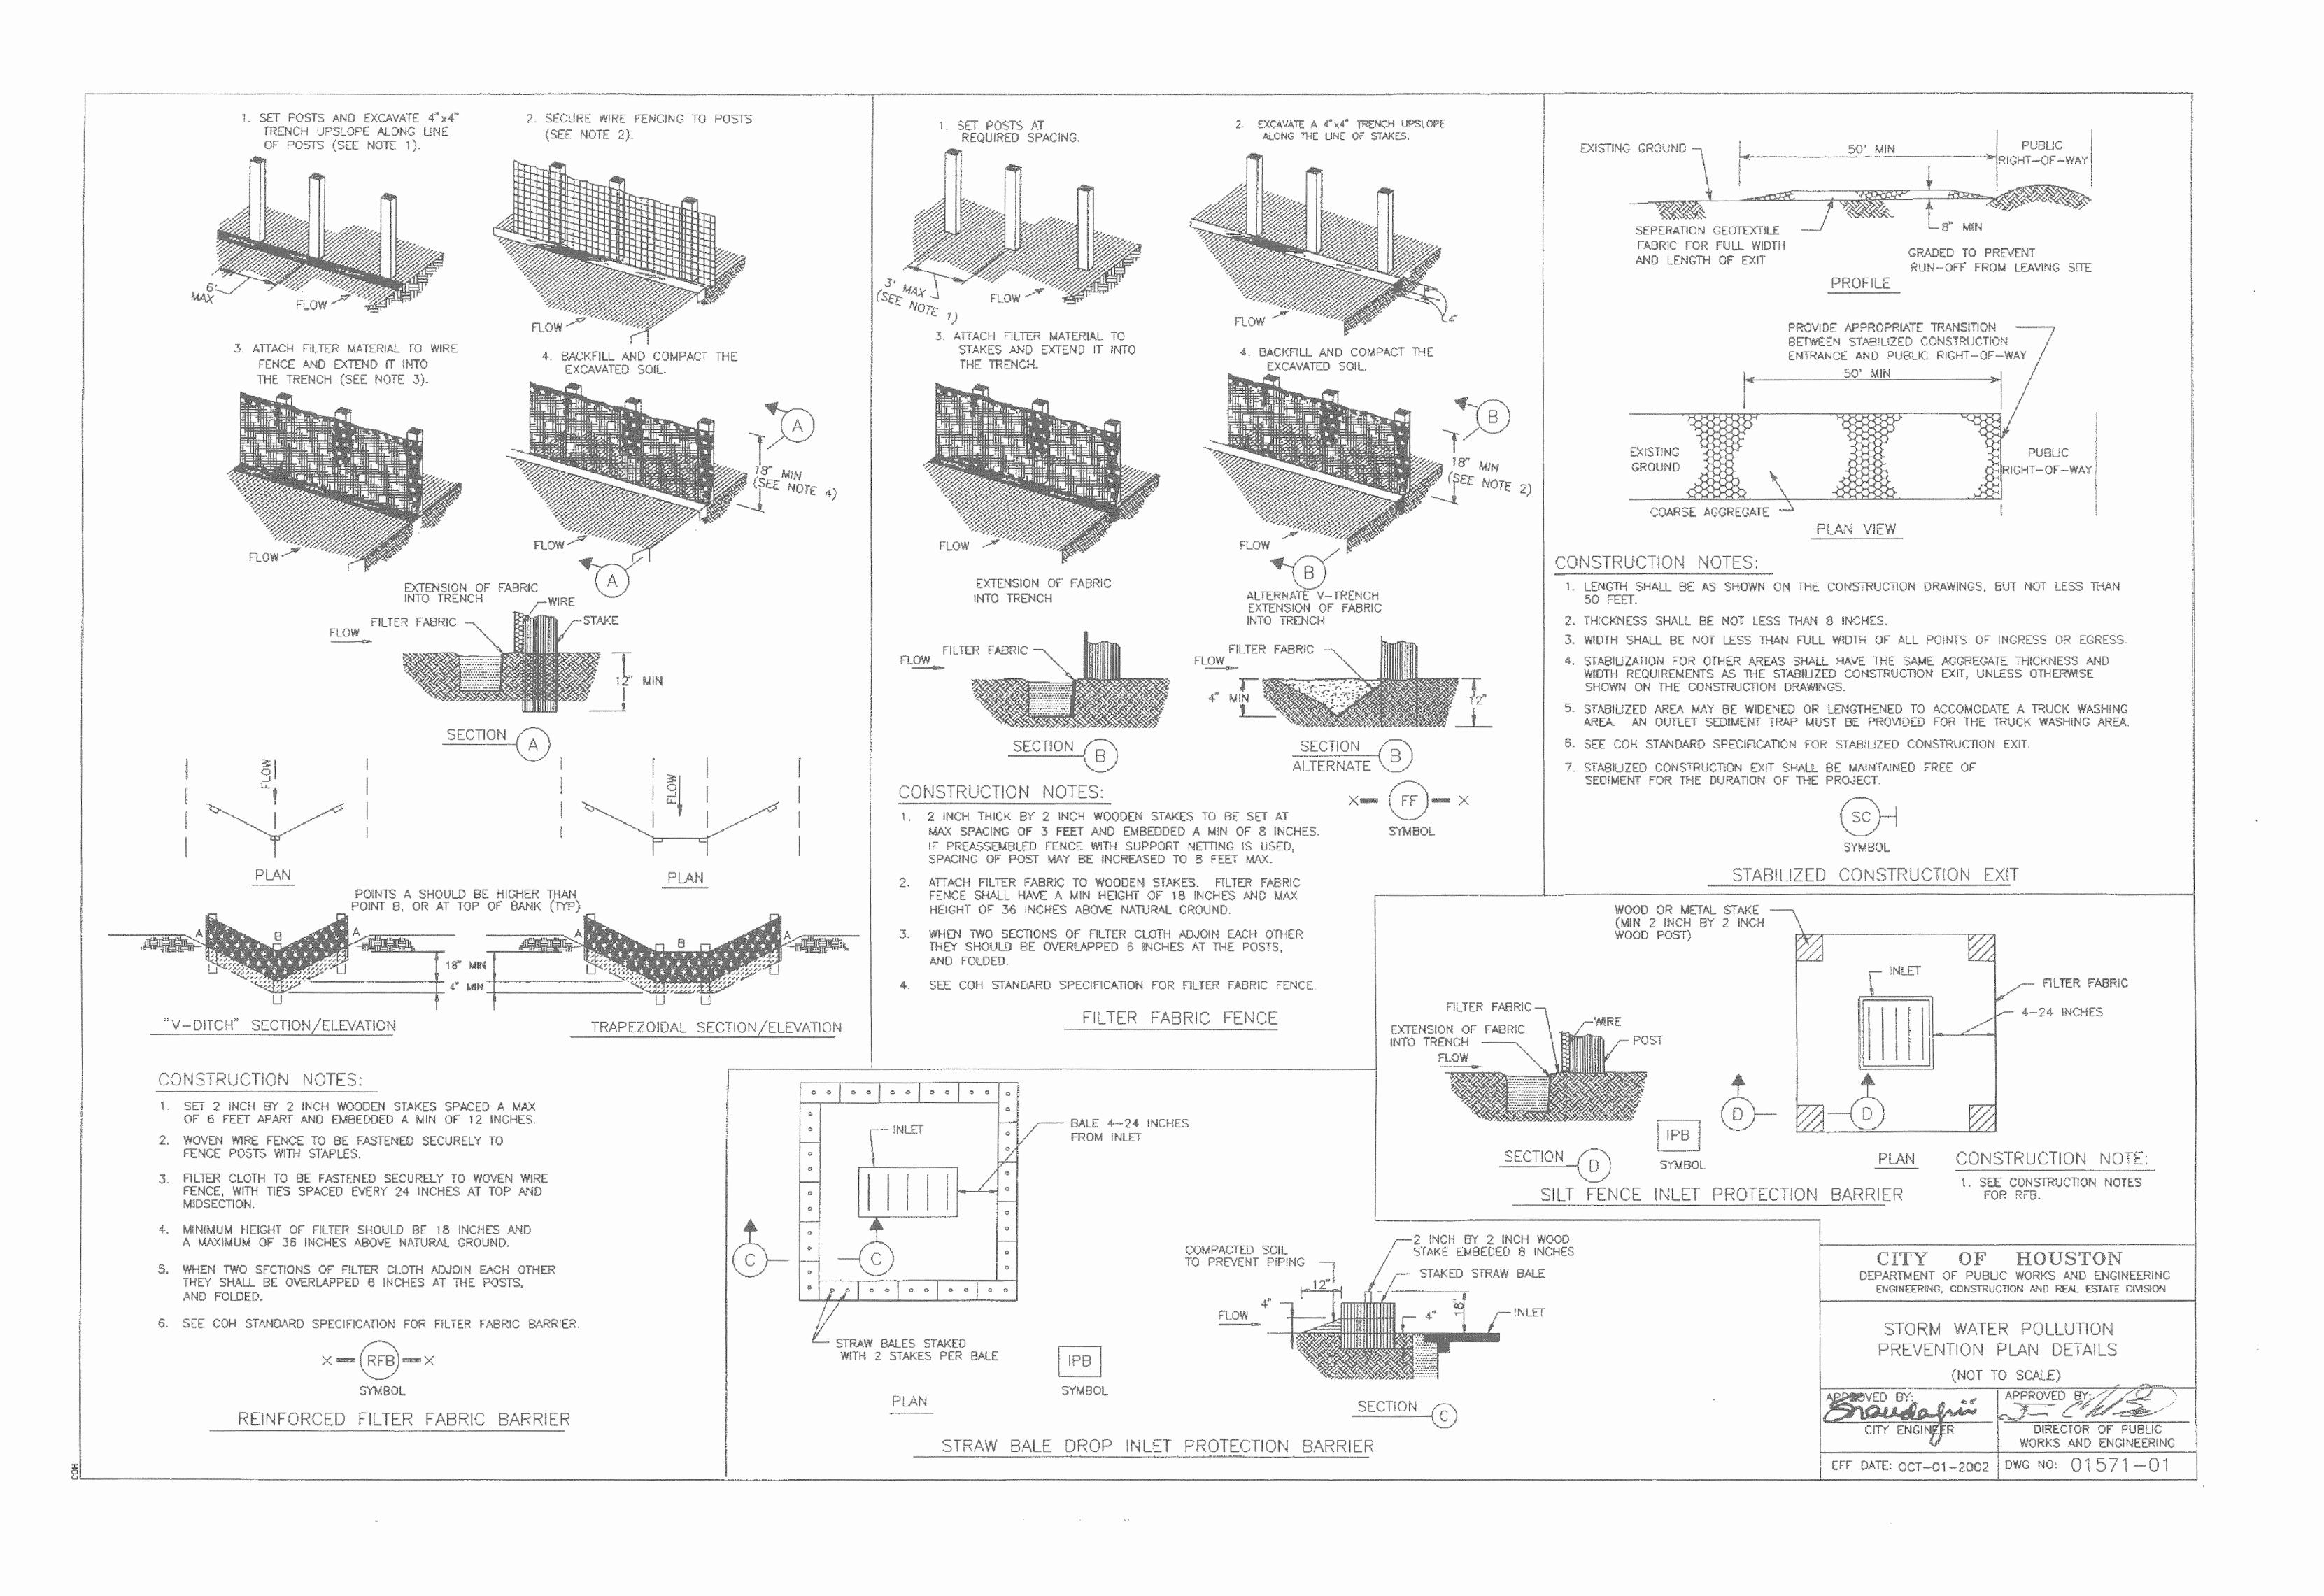
rights, including the copyright thereto.

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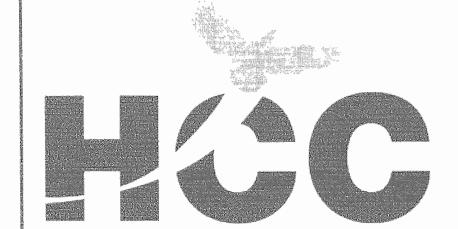
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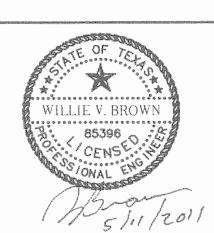


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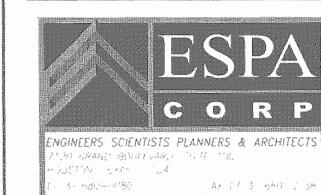
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architecture + planning + design
5120 Woodway, Suite 8010
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f: 713.850.1023
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E&C Engineers & Consultants Inc 1010 Lamar, #650 Houston, Texas 77002 713.580 8800 713.580 8888 Fax

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# STORM WATER POLLUTION PREVENTION DETAILS

Scale: N.T.S.

C-13.0

#### CONSTRUCTION NOTES

- IT SHALL BE THE RESPONSIBILITY OF THE CONTRACTOR TO NOTIFY THE LOCAL AUTHORITY OR GOVERNING AGENCY OF THE BEGINNING DATE OF CONSTRUCTION AND SHALL BE THE RESPONSIBILITY OF THE CONTRACTOR TO SEE THAT NO WORK IS DONE WITHOUT THE PROPER INSPECTIONS AND PERMITS BY THE LOCAL AUTHORITY OR
- THE CONTRACTOR WILL BE RESPONSIBLE FOR APPLYING FOR AND PAYING FOR ALL PERMITS AND APPROVALS UNLESS NOTIFIED OTHERWISE.
- FOR CONSTRUCTION SHALL BE REMOVED AND/OR RELOCATED AS DIRECTED BY AGENCY HAVING JURISDICTION OVER SUCH ITEMS UNLESS NOTED OTHERWISE. COST FOR SUCH ITEMS SHALL BE PART OF CONTRACT BID PRICE.
- ALL BRUSH, ORGANIC TOPSOIL AND OTHER OBJECTIONABLE MATERIAL SHALL BE REMOVED AND DISPOSED OF AT AN OFF-SITE LOCATION. ADDITIONAL SUITABLE FILL MATERIAL SHALL BE BROUGHT ONTO THE SITE, IF NECESSARY. AREAS WHICH ARE TO BE FILLED SHALL BE COMPACTED IN ACCORDANCE WITH THE SOILS REPORT.
- THE CONTRACTOR SHALL VERIFY THE DIMENSIONS SHOWN ON THE CONSTRUCTION PLANS WITH THOSE MEASURED IN THE FIELD PRIOR TO COMMENCING CONSTRUCTION ANY DISCREPANCIES SHALL BE BROUGHT TO THE ATTENTION OF THE ENGINEER
- EXISTING UNDERGROUND FACILITIES HAVE BEEN PLOTTED FROM AVAILABLE SURVEYS AND PLANS PROVIDED TO ESPA CORP. THEREFORE THEIR LOCATION MUST BE CONSIDERED APPROXIMATE ONLY. VERIFICATION, SUCH AS LOCATION AND ELEVATION, OF EACH FACILITY SHOWN OR NOT SHOWN, SHALL BE THE RESPONSIBILITY OF THE
- CONTRACTOR, PRIOR TO COMMENCING CONSTRUCTION. CALL UTILITY COORDINATING COMMITTEE (1-800-245-4545) OR DIG-TESS AT 1-800-344-8377.
- 8. THIS SITE IS NOT WITHIN THE 100-YEAR FLOOD PLAIN.
- CONTRACTOR SHALL NOTIFY THE CITY OF HOUSTON, DEPARTMENT OF PUBLIC WORKS and engineering, engineering construction division (telephone no. 713/863-1450) 48 HOURS BEFORE STARTING WORK ON THIS PROJECT.

- ALL TRENCHES UNDER PROPOSED PAVEMENT SHALL BE BACKFILLED TO SUBGRADE ELEVATION WITH COMPACTED APPROVED GRANULAR MATERIALS. IF USED IN LANDSCAPE OR GRASS AREAS, BACKFILL TO A POINT ONE FOOT BELOW FINISHED GRADE WITH THE REMAINDER BEING HAND TAMPED EXCAVATED SOIL.
- 2. IT SHALL BE THE DUTY AND RESPONSIBILITY OF THE CONTRACTOR AND ALL OF ITS SUBCONTRACTORS TO BE FAMILIAR AND COMPLY WITH ALL REQUIREMENTS OF PUBLIC LAW 91-596, 29 U.S.C. SECS. 651 ET. SEQ., THE OCCUPATIONAL SAFETY AND HEALTH ACT OF 1970, (OSHA) AND ALL AMENDMENTS THERETO, AND TO ENFORCE AND COMPLY WITH ALL OF THE PROVISIONS OF THIS ACT.
- BEFORE COMMENCING ANY TRENCH EXCAVATION WHICH WILL EXCEED DEPTH OF FIVE (5) FEET, CONTRACTOR WILL PROVIDE OWNER WITH DETAILED PLANS AND SPECIFICATIONS REGARDING THE SAFETY SYSTEMS TO BE UTILIZED. SAID PLANS AND SPECIFICATIONS SHALL INCLUDE A CERTIFICATION FROM A REGISTERED PROFESSIONAL ENGINEER INDICATING FULL COMPLIANCE WITH THE OSHA PROVISIONS NOTED ABOVE.
- 4. ESPA CORP SHALL NOT BE HELD LIABLE OR OTHERWISE RESPONSIBLE FOR ANY INJURIES, LOSSES OR DAMAGE RESULTING FROM CONSTRUCTION.
- WATER LINES, WASTEWATER COLLECTION SYSTEMS AND DRAINAGE SYSTEMS SHALL BE CONSTRUCTED IN ACCORDANCE WITH THE CITY OF HOUSTON, DEPARTMENT OF PUBLIC WORKS AND ENGINEERING'S "STANDARD CONSTRUCTION SPECIFICATIONS," LATEST REVISION, AND STANDARD CONSTRUCTION DETAILSFOR WASTEWATER COLLECTION SYSTEMS, WATER LINES, STORM DRAINAGE AND STREET PAYING "DATED OCTOBER 2002 WITH ALL SUBSEQUENT AMENDMENTS ADDED THERETO UNLESS OTHERWISE NOTED AND APPROVED ON THESE PLANS.
- 6. THE CONTRACTOR SHALL BE FULLY RESPONSIBLE FOR ANY AND ALL DAMAGE TO THE EXISTING PUBLIC OR PRIVATE PAVEMENTS AND UTILITY LINES, INCLUDING BUT NOT LIMITED TO PAVING, WATER LINES, WASTEWATER COLLECTION SYSTEMS AND STORM SEWERS, DURING CONSTRUCTION. ALL DAMAGES SHALL BE REPAIRED IN ACCORDANCE WITH THE CITY OF HOUSTON, DEPARTMENT OF PUBLIC WORKS AND ENGINEERING "STANDARD CONSTRUCTION SPECIFICATIONS" WITH LATEST ADDENDA AND AMENDMENTS THERETO, WITH NO COST TO THE THE OWNER.
- 7. THIS PROJECT IS SUBJECT TO CITY OF HOUSTON STREET CUT ORDINANCE.

#### PAVING CONSTRUCTION NOTES

- ALL ROAD WIDTHS, CURB RADII, AND CURVE ALIGNMENT SHOWN INDICATE BACK OF CURB OR EDGE OF PAVEMENT IF THERE IS NO CURB. ELEVATIONS SHOWN INDICATE TOP OF CURB ELEVATIONS ON CURBED STREETS, OR TOP OF PAVEMENT ELEVATION ON
- ALL CURB RADII TO VARY TO FACE OF CURB IN ACCORDANCE WITH THE PLANS WITH A MINIMUM ONE (1%) PERCENT GRADE, UNLESS OTHERWISE NOTED. FOR MACHINE—LAID CURB, OMIT MORTAR FINISH BUT MAINTAIN SAME OUTSIDE DIMENSIONS.
- GUIDELINES SET FORTH IN THE TEXAS MANUAL ON UNIFORM TRAFFIC CONTROL DEVICES SHALL BE OBSERVED.
- 4. CURBS ARE TO BE 6-INCH CONCRETE CURBS, UNLESS OTHERWISE NOTED. CONCRETE PAVEMENT TO BE MINIMUM 5 SACK MIX. REINFORCING STEEL TO CONFORM TO ASTM A-615, GRADE 60, INCLUDING CRSI 63 AND 65, PROVIDE 15-INCH LAP.
- 6. PAVING SUBGRADE PREPARATION SHALL INCLUDE LIME STABILIZATION IN ALL AREAS. REFER TO SOIL REPORT.
- PAVING CONTRACTOR TO PROTECT WATER, SEWER AND DRAINAGE FACILITIES AND WILL REPLACE AT HIS EXPENSE ANY FACILITIES DAMAGED DURING PAVING OPERATIONS. ALL MANHOLES AND VALVES FALLING WITHIN PAVEMENT ARE TO BE ADJUSTED TO FINISHED GRADE BY PAVING CONTRACTOR WITHOUT THE USE OF BLOCKOUTS, WHEN DIRECTED BY OWNER. NO SEPARATE PAY.
- S. SUITABLE ROADWAY EXCAVATION SHALL BE PLACED IN FILL AREAS DESIGNATED BY THE OWNER AND COMPACTED IN MAXIMUM 8-INCH LAYERS TO 95% STANDARD PROCTOR DENSITY AT OPTIMUM MOISTURE CONTENT OR DISPOSED OF AS DIRECTED BY OWNER. CONTRACTOR SHALL REMOVE MUCK AND UNSUITABLE MATERIAL FROM FILL AREAS PRIOR TO PLACING FILL. SURPLUS EXCAVATED MATERIAL AND UNSUITABLE MATERIAL SHALL BE DISPOSED OF AS DIRECTED BY OWNER. ROADWAY FILL SHALL BE SUITABLE MATERIAL PLACED AND COMPACTED IN ACCORDANCE WITH THE GEOTECHNICAL REPORT. MATERIAL WHICH CAN NOT BE COMPACTED TO THE REQUIRED DENSITY SHALL BE REMOVED AND REPLACED WITH ACCEPTABLE MATERIAL THAT WILL MEET THE SPECIFIED REQUIREMENTS.

#### WATER CONSTRUCTION NOTES

F: \2166-024\C14.0 General Notes.dwg Plotted: Jun 02, 2011 - 11:20am by lloyd

- THIS PROJECT SHALL BE BUILT BY MEANS OF OPEN CUT EXCEPT AS NOTED ON THE DRAWINGS CONTRACTOR TO DETERMINE THE LOCATIONS OF BORE PITS IN FIELD, SUBJECT TO THE CITY ENGINEER'S APPROVAL.
- ALL UTILITIES PRESENTED ON THESE DRAWINGS ARE SHOWN AT THE APPROXIMATE LOCATIONS BASED ON THE BEST AVAILABLE INFORMATION. THE CONTRACTOR SHALL FIELD DETERMINE THE EXACT LOCATIONS PRIOR TO COMMENCING CONSTRUCTION. HE SHALL BE FULLY RESPONSIBLE FOR ANY AND ALL DAMAGES CAUSED BY HIS FAILURE TO EXACTLY LOCATE AND MAINTAIN THESE UNDERGROUND UTILITIES.
- CONTRACTOR SHALL PROVIDE ADEQUATE CONCRETE THRUST BLOCKING TO WITHSTAND TEST RESSURE AS SPECIFIED IN CITY OF HOUSTON, DEPARTMENT OF PUBLIC WORKS AND ENGINEERING SPECIFICATIONS.
- PRIOR TO WATER MAIN ADJUSTMENTS, THE INSTALLATION OF WATER METERS AND LEADS OR UNMETERED SPRINKLER LINE, THE CONTRACTOR SHALL CONTACT WATER TAPS AND METERS AT 713-535-7675 FOR DETAILS OF PERMITS AND BONDS.

F: \2166-024\COH Traffic Control\2 GENERAL NOTES.dwg Plotted: May 19, 2011 - 2:15pm by lloyd

#### STREET AND ERIDGE NOTES

- DEPARTMENT OF PUBLIC WORKS AND ENGINEERING'S "STANDARD CONSTRUCTION SPECIFICATIONS" DATED OCTOBER 2002, AND "STANDARD CONSTRUCTION DETAILS FOR WASTEWATER COLLECTION SYSTEMS, WATER LINES, STORM DRAINAGE AND STREET PAVING" DATED OCTOBER 2002, (AND LATER) UNLESS OTHERWISE NOTED AND APPROVED ON THESE PLANS. THE DESIGN IS CONSISTENT WITH THE MINIMUM STANDARDS ESTABLISHED IN THE
- 2. FILL AREAS ON PLANS SHALL BE FILLED LAYERS NOT EXCEEDING 8" IN DEPTH AND EACH COMPACTED TO NOT LESS THAN 95% STANDARD PROCTOR DENSITY PRIOR TO INSTALLATION OF WATER LINE AND FILL AREA SHALL BE SEEDED AND FERTILIZED WITHIN 10 WORKING
- CONTRACTOR SHALL PROVIDE SILT BARRIER FENCE ON ALL STAGE 1 CURB INLETS. EXISTING PAVEMENTS, CURBS, DRIVEWAYS, AND SIDEWALKS DAMAGED OR REMOVED DURING CONSTRUCTION SHALL BE REPLACED TO THE CITY OF HOUSTON STANDARDS, WITH LATEST

INFRASTRUCTURE DESIGN MANUAL" DATED OCTOBER 2002.

- 6. CONDITION OF THE ROAD AND/OR RIGHT-OF-WAY. UPON COMPLETION OF JOB, SHALL BE AS GOOD AS OR BETTER THAN PRIOR TO STARTING WORK.
- ADEQUATE DRAINAGE SHALL BE MAINTAINED AT ALL TIMES DURING CONSTRUCTION AND ANY DRAINAGE DITCH OR STRUCTURE DISTURBED DURING CONSTRUCTION SHALL BE RESTORED TO SATISFACTION OF THE OWNING AUTHORITY.
- 8. EXPOSED 15" OF REINFORCING STEEL AT PROPOSED SAWED JOINT, IF NO REINFORCING STEEL EXISTS, USE HORIZONTAL DOWELS HORIZONTAL DOWELS SHALL BE #6 BARS. 24" LONG, 24" C-C. DRILLED AND EMBEDDED 8" INTO THE CENTER OF THE EXISTING SLAB WITH
- CONTRACTOR TO TAKE NECESSARY PRECAUTIONS TO PROTECT ROOT SYSTEMS OF SHRUBS, PLANTS AND TREES ALONG AREAS OF EXCAVATION.
- CONTRACTOR SHALL COMPLY WITH OSHA REGULATIONS AND STATE OF TEXAS LAW CONCERNING EXCAVATION, TRENCHING AND SHORING AS SPECIFIED IN CITY OF HOUSTON
- WHEEL CHAIR RAMPS SHALL BE INSTALLED IN ACCORDANCE WITH CITY OF HOUSTON STANDARDS AT ALL INTERSECTIONS WHERE SIDEWALKS EXIST AND THE EXISTING CURB OR SIDEWALK IS DAMAGED OR REMOVED DURING CONSTRUCTION.
- WASTEWATER COLLECTION SYSTEMS, WATER LINES, STORM DRAINAGE AND STREET PAVING SHALL BE CONSTRUCTED IN ACCORDANCE WITH THE CITY OF HOUSTON, DEPARTMENT OF PUBLIC WORKS AND ENGINEERING "STANDARD CONSTRUCTION SPECIFICATIONS" DATED OCTOBER 2002 AND "STANDARD CONSTRUCTION DETAILS FOR WASTEWATER COLLECTION SYSTEMS. WATER LINES, STORM DRAINAGE AND STREET PAVING" DATED OCTOBER 200: UNLESS OTHERWISE NOTED AND APPROVED ON THESE PLANS. THE DESIGN SHOULD BE CONSISTENT WITH THE MINIMUM STANDARD ESTABLISHED IN THE "DESIGN MANUAL FOR wastewater collection systems, water lines, storms drainage and street paving"
- 13. THE CONTRACTOR SHALL BE FULLY RESPONSIBLE FOR ANY DAMAGES TO EXISTING WATER, WASTEWATER, STORM SEWER AND TRAFFIC SIGNAL CONDUITS ALL DAMAGES SHALL BE REPAIRED IN ACCORDANCE WITH THE CITY OF HOUSTON, DEPT. OF PUBLIC WORKS AND ENGINEERING "STANDARD CONSTRUCTION SPECIFICATIONS" WITH LATEST ADDENDA AND AMENDMENTS THERETO, AT NO COST TO THE CITY OF HOUSTON.
- 14. PRIOR TO STREET CONSTRUCTION, THE CONTRACTOR SHALL CONTACT THE DEPARTMENT OF PUBLIC WORKS AND ENGINEERING AT 713-535-7579 OR 713-535-7582 AND COMPLY WITH ALL REQUIREMENTS FOR THE ISSUANCE OF NECESSARY PERMITS/WORK ORDERS FOR STREET
- 15. DOUBLE REFLECTORIZED BLUE TRAFFIC MARKERS SHALL BE PLACED 6-INCHES OFFSET OF THE CENTERLINE OF ALL FIRE HYDRANT LOCATIONS BY THE PAVING CONTRACTOR. HYDRANTS LOCATED AT INTERSECTIONS SHALL HAVE A BUTTON PLACED ON EAST STREET.

#### STORM SEWER CONSTRUCTION NOTES

- 1. STORM SEWER SHALL BE REINFORCED CONCRETE PIPE (C-76 CLASS III) AND SHALL BE INSTALLED, BEDDED, AND BACKFILLED IN ACCORDANCE WITH THE CITY OF HOUSTON DRAWING NOS. 02317-02, 02317-03, 02317-05, 02317-08, AND 02317-07, (OCT.2002) AS APPLICABLE UNLESS OTHERWISE SHOWN ON THE DRAWINGS.
- 2. ALL STORM SEWER CONSTRUCTED IN SIDELOT EASEMENT SHALL BE R.C.P.(C-76, CLASS III)
  AND SHALL BE BEDDED IN ACCORDANCE WITH THE CITY OF HOUSTON DRAWINGS NOS,
  02317-02, 02317-03, 02317-05, 02317-06, AND 02317-07 AS APPLICABLE.
- 3. ALL SEWER UNDER PROPOSED OR FUTURE PAYMENT AND TO A POINT ONE (1) FOOT BACK OF ALL PROPOSED OR FUTURE CURBS SHALL BE BACKFILLED WITH 1-1/2 SACK CEMENT/C.Y STABILIZED SAND TO WITHIN ONE (1) FOOT OF SUBGRADE. THE REMAINING DEPTH OF TRENCH SHALL BE BACKFILLED WITH SUITABLE EARTH MATERIAL.
- 4. ALL TRENCH BACKFILLS SHALL BE IN 8" LIFTS, WITH TESTS TAKEN AT 100 FOOT INTERVALS ON EACH LIFT, AND MECHANICALLY COMPACTED TO A DENSITY OF NOT LESS THAN 95% OF THE MAXIMUM DRY DENSITY AS DETERMINED BY THE STANDARD PROCTOR COMPACTION iest (astm D-698/aasht 0799)
- 5. CIRCULAR AND ELLIPTICAL REINFORCED CONCRETE PIPE SHALL BE INSTALLED USING RUBBER GASKET JOINTS CONFORMING TO ASTM C443 AND ASTM C877 RESPECTIVELY. 6. ALL STORM SEWER PIPES AND INLET LEADS SHALL BE 24-INCH AND LARGER R.C.P. (C-76,
- 7. ALL PROPOSED PIPE STUB-OUTS FROM MANHOLES AND INLETS ARE TO BE PLUGGED WITH 8" BRICK WALLS UNLESS OTHERWISE NOTED.
- B. CONTRACTOR SHALL PROVIDE 12" MINIMUM CLEARANCE AT STORM SEWER AND WATER LINE CROSSINGS.
- 9. ADJUST MANHOLE COVERS TO GRADE CONFORMING TO REQUIREMENTS OF SECTION 02086-ADJUSTING MANHOLES, INLETS AND VALVE BOXES TO GRADE 10. THE CONTRACTOR SHALL BE RESPONSIBLE FOR PROTECTING, MAINTAINING, AND RESTORING ANY BACK SLOPE DRAINAGE SYSTEM DISTURBED AS A RESULT OF HIS WORK.
- 11. ALL DITCHES SHALL BE REGRADED TO PROPOSED ELEVATIONS TO INSURE PROPER DRAINAGE, ALL OUTFALLS SHALL BE PROPERLY BACKFILLED AND COMPACTED. ALL DISTURBED AREA SHALL BE REGRADED, SEEDED, AND FERTILIZED. 12. ALL DRIVEWAYS WILL BE LOCATED TO AVOID EXISTING CURB INLET STRUCTURES.

#### WASTEWATER CONSTRUCTION NOTES

- SANITARY SEWERS SHALL BE CONSTRUCTED IN COMPLIANCE WITH THE LATEST CITY OF HOUSTON SPECIFICATIONS FOR SEWER CONSTRUCTION, BEDDING FOR SANITARY SEWERS SHALL BE IN ACCORDANCE WITH CITY OF HOUSTON DRAWING NO. 02317-08.
- 2. SANITARY SEWER PIPE SHALL BE SDR-28 PVC UNLESS NOTED OTHERWISE. 3. ALL SANITARY SEWER MANHOLES SHALL BE PER CITY OF HOUSTON DWG NO. 02082-02.
- 4. EXISTING SANITARY SEWER MANHOLE RIMS LOCATED UNDER PROPOSED PAVEMENT SHALL BE ADJUSTED FLUSH WITH TOP OF PAVEMENT. 5. CONTRACTOR SHALL KEEP RECORD OF LOCATION OF ALL STACKS, STUBS, ETC.
- WHENEVER A SANITARY SEWER CROSSES A WATER LINE AND THE CLEARANCE IS LESS THAN NINE FEET, AN 18-FOOT JOINT OF 150 PSI PVC OR DUCTILE IRON PIPE SHALL BE ENTERED AT THE CROSSING. UNDER NO CIRCUMSTANCES SHALL A SANITARY SEWER CROSS A WATER LINE WHATER THAN TWO FEET CLEARANCE ABOVE OR ONE FOOT CLEARANCE BELOW THE WATER LINE.
- MAINTAIN 9 FOOT MINIMUM HORIZONTAL CLEARANCE BETWEEN SANITARY SEWERS AND WATER LINES, UNLESS OTHERWISE NOTED.
- MAINTAIN 12-INCH MINIMUM VERTICAL CLEARANCE AT CROSSINGS BETWEEN SANITARY SEWERS AND CULVERTS, UNLESS OTHERWISE NOTED.
- NO CONNECTION SHALL BE MADE TO EXISTING SANITARY SEWERS UNTIL ALL PROPOSED SEWER LINES HAVE BEEN THOROUGHLY CLEANED, TESTED, AND APPROVED BY THE ENGINEER.
- TRAFFIC NOTES
- PART VI OF THE TEXAS MANUAL ON UNIFORM TRAFFIC CONTROL DEVICES (TEXAS MUTCD, MOST RECENT EDITION WITH REVISIONS) DURING CONSTRUCTION.

1. CONTRACTOR SHALL PROVIDE AND INSTALL TRAFFIC CONTROL DEVICES IN CONFORMANCE WITH

- 2A. NO LANES SHALL BE CLOSED DURING THE HOURS OF 5:30 AM TO 7:00 PM MONDAY THRU FRIDAY IN DOWNTOWN/MIDTOWN AREA.
- 2B. NO LANES SHALL BE CLOSED DURING THE HOURS 7:00 AM TO 9:00 AM AND 4:00 PM T 6:00 PM MONDAY THRU FRIDAY.
- 2C. NO WORK, AND LANES SHALL BE CLOSED IN RESIDENTIAL AREA FROM 7:00 PM TO 7:00 AM. 3. CONTRACTOR SHALL MAINTAIN ONE LANE OF TRAFFIC IN EACH DIRECTION DURING WORKING HOURS
- 3A. CONTRACTOR SHALL MAINTAIN TRAFFIC LANE(S) ACCORDING TO TRAFFIC CONTROL PLANS DURING WORKING HOURS.
- CONTRACTOR SHALL COVER OPEN EXCAVATIONS WITH STEEL PLATES ANCHORED PROPERLY DURING NON-WORKING HOURS. AND OPEN LANES FOR NORMAL TRAFFIC FLOW. 5. AN OFF-DUTY UNIFORMED POLICE OFFICER/FLAGGER(S) IS REQUIRED TO DIRECT TRAFFIC WHEN LANES ARE BLOCKED.
- 6A. IN THE EVENT WHEN NO "TRAFFIC CONTROL PLANS" EXIST AS A PART OF CONTRACT DRAWINGS, CONTRACTOR SHALL PREPARE PLANS" AND SUBMIT TO PLAN REVIEW SECTION FOR APPROVAL TEN WORKING DAYS PRIOR TO IMPLEMENTATION.
- 6B. IF THE CONTRACTOR CHOOSES TO USE A DIFFERENT METHOD OF "TRAFFIC CONTROL PLANS" DURING THE CONSTRUCTION THAN WHAT IS OUTLINE IN THE CONTRACT DRAWINGS,(S) HE SHALL BE RESPONSIBLE TO PREPARE AND SUBMIT AN ALTERNATE SET PLANS\* TO PLAN REVIEW SECTION FOR APPROVAL TEN WORKING DAYS PRIOR TO IMPLEMENTATION.
- \* THESE PLANS SHALL BE DRAWN TO SCALE ON REPRODUCIBLE MYLARS AND SEALED BY A LICENSED ENGINEER IN THE STATE OF TEXAS. PLANS WILL BECOME A PART OF THE CONTRACT DRAWINGS.
- 7. APPROVED COPIES OF "TRAFFIC CONTROL PLANS" AND LANE/SIDEWALK CLOSURE PERMITS SHALL BE AVAILABLE FOR INSPECTION AT JOB SITE AT ALL TIMES.
- B. CONTRACTOR MUST SECURE "LANE/SIDEWALK CLOSURE PERMITS" FROM CITY'S TRAFFIC MANAGEMENT AND MAINTENANCE BRANCH BEFORE CLOSING A LANE/SIDEWALK. THE REQUEST MUST BE MADE AT LEAST TEN (10) BUSINESS DAYS PRIOR TO THE DATE FOR WHICH THE CLOSURE IS SOUGHT. NOTE THAT WORKING HOURS MAY BE RESTRICTED OR THE REQUEST MAY BE DENIED. CALL (832) 395-3020 FOR AN APPLICATION.

#### SWPPP CONSTRUCTION NOTES

- CONTRACTOR SHALL INPLEMENT INLET PROTECTION DEVICES AND REINFORCED FILER FABRIC BARRIER ALONG ROAD AND SIDE DITCHES AT LOCATIONS SHOWN ON THE TYPICAL STORM WATER POLLUTION PREVENTION (SWPPP) PLANS TO KEEP SILT AND OR EXCAVATED MATERIAL FROM ENTERING INTO THE STORM WATER INLETS AND DITCHES EVENTUALLY POLLUTING THE RECEIVING STORM.
- DURING THE EXCAVATION PHASE OF THE PROJECT. CONTRACTOR SHALL SCHEDULE THE WORK IN SHORT SEGMENTS SO THAT EXCAVATION MATERIAL CAN BE QUICKLY HAULED AWAY FROM THE SITE AND TO PREVENT IT FROM STAYING UNCOLLECTED ON THE EXISTING PAVEMENT. ANY LOOSE EXCAVATED MATERIAL WHICH FALLS ON PAVEMENTS OR DRIVEWAYS SHALL BE SWEPT
- BACK INTO THE EXCAVATED AREA. CONTRACTOR SHALL CLEAN UP THE EXISTING STREET INTERSECTIONS AND DRIVEWAYS DAILY, AS NECESSARY, TO REMOVE ANY EXCESS MUD, SILT OR ROCK TRACKED FORM THE EXCAVATED
- CONTRACTOR SHALL FOLLOW GOOD HOUSEKEEPING PRACTICES DURING THE CONSTRUCTION OF THE PROJECT, ALWAYS CLEANING UP DIRT AND LOOSE MATERIAL AS CONSTRUCTION PROGRESSES.
- CONTRACTOR TO INSPECT AND MAINTAIN THE AREAS USTED BELOW AT LEAST ONCE EVERY FOURTEEN (14) CALENDER DAYS AND WITHIN 24 HOURS OF THE END OF A STORM EVENT OF 0.5 INCHES OR GREATER.

  5. DISTURBED AREAS OF THE CONSTRUCTION SITE THAT HAVE NOT BEEN FINALLY STABILIZED.

   AREAS USED FOR STORAGE OF MATERIALS THAT ARE EXPOSED TO PRECIPITATION.

   STRUCTURAL CONTROL MEASURES.

   LOCATIONS WHERE VEHICLES ENTER OR EXIT THE SITE.
- CONTRACTOR TO BE RESPONSIBLE TO MAINTAIN EXISTING DITCHES AND OR CULVERTS FOR UNOBSTRUCTED DRAINAGE AT ALL TIMES. WHERE SODDING IS DISTURBED BY EXCAVATION ON BACKFILLING OPERATIONS, SUCH AREAS SHALL BE REPLACED BY SEEDING OR SODDING.

  6. SLOPES 4:1 OR STEEPER SHALL BE REPLACED BY BLOCK SODDING.

#### AT&T TEXAS/SBC NOTES

- 1. THE LOCATIONS OF AT&T TEXAS/SBC FACILITIES ARE SHOWN IN AN APPROXIMATE WAY ONLY. THE CONTRACTOR SHALL DETERMINE THE EXACT LOCATION BEFORE COMMENCING WORK. HE AGREES TO BE FULLY RESPONSIBLE FOR ANY AND ALL DAMAGES WHICH MIGHT BE OCCASIONED BY THIS FAILURE TO EXACTLY LOCATE AND PRESERVE THESE UNDERGROUND UTILITIES.
- 2. THE CONTRACTOR SHALL CALL 1-800-344-8377 A MINIMUM OF 48 HOURS PRIOR TO CONSTRUCTION
- 3. WHEN EXCAVATING WITHIN EIGHTEEN INCHES (18") OF THE INDICATED LOCATION OF AT&T TEXAS/SBC FACILITIES, ALL EXCAVATIONS MUST BE ACCOMPLISHED USING NON-MECHANIZED EXCAVATION
- WHEN AT&T TEXAS/SBC FACILITIES ARE EXPOSED, THE CONTRACTOR SHOULD PROVIDE SUPPORT TO DAMAGE TO THE CONDUIT DUCTS OR CABLES. WHEN EXCAVATING NEAR TELEPHONE POLES THE CONTRACTOR SHALL BRACE THE POLE FOR SUPPORT.
- IN THE PRESENCE OR ABSENCE OF AT&T TEXAS/SBC UNDERGROUND CONDUIT FACILITIES DOES NOT MEAN THAT THERE ARE NO DIRECT BURIED CABLES IN THE AREA. FOLLOW THE DIRECT BURIED CABLE PROCEDURES TO LOCATE THE AT&T TEXAS/SBC DIRECT BURIED CABLES AS INDICATED IN THE AT&T TEXAS RESEARCH AND SIGNATURE PROCESS FOR AT&T TEXAS/SBC FACILITIES.

#### ENTERPOINT ENERGY NOTES CAUTION: UNDERGROUND GAS FACILITIES


- LOCATIONS OF CENTERPOINT ENERGY MAIN LINES (TO INCLUDE CENTERPOINT ENERGY, INTRASTATE PIPELINE, LLC WHERE APPLICABLE) ARE SHOWN IN AN APPROXIMATE LOCATION ONLY. SERVICE LINES ARE USUALLY NOT SHOWN. THE CONTRACTOR SHALL CONTACT THE UTILITY COORDINATING COMMITTEE AT (713)223-4567 OR 1-800-669-8344 A MINIMUM OF 48 HOURS PRIOR TO CONSTRUCTION TO HAVE MAIN AND
- (7:00 A.M. TO 4:30 P.M.) FOR STATUS OF LINE LOCATION REQUEST BEFORE EXCAVATION
- WHEN EXCAVATING WITHIN EIGHTEEN INCHES (18") OF THE INDICATED LOCATION OF CENTER POINT ENERGY FACILITIES, ALL EXCAVATION MUST BE ACCOMPLISHED USING NON-MECHANIZED EXCAVATION PROCEDURES.
- WHEN CENTERPOINT ENERGY FACILITIES ARE EXPOSED, SUFFICIENT SUPPORT MUST BE PROVIDED TO THE FACILITIES TO PREVENT EXCESSIVE STRESS ON THE PIPING. THE CONTRACTOR IS FULLY RESPONSIBLE FOR ANY DAMAGES CAUSED BY HIS FAILURE TO EXACTLY LOCATE AND PRESERVE THESE UNDERGROUND FACILITIES.
- CENTERPOINT ENERGY ASSUMES NO RESPONSIBILITY FOR THE OWNERSHIP FOR OR THE ACCURACY OF THE ABANDONED GAS LINES SHOWN ON THESE PLANS. THE CONTRACTOR SHALL NOTIFY CENTERPOINT ENERGY AT (713)—672—4816 AFTER EXPOSING ANY ABANDONED OR ACTIVE GAS LINES. THE GAS LINES SHALL NOT BE DISTURBED BY THE CONTRACTOR UNTIL CENTERPOINT ENERGY HAS VERIFIED THE STATUS OF THE LINE.

LOCATIONS OF CenterPoint Energy MAIN LINES (TO INCLUDE CenterPoint Energy, INTERSTATE PIPELINE LLC. WHERE APPLICABLE) ARE SHOWN IN AN APPROXIMATE LOCATION ONLY. SERVICE LINES ARE USUALLY NOT SHOWN.

OUR SIGNATURE ON THESE PLANS ONLY INDICATES THAT OUR FACILITIES ARE SHOWN IN APPROXIMATE LOCATION. IT DOES NOT IMPLY THAT A CONFLICT ANALYSIS HAS BEEN MADE. THE CONTRACTOR SHALL CONTACT THE UTILITY COORDINATING COMMITTEE AT (713 223—4567 OR 1—800—669—8344 A MINIMUM OF 48 HOURS PRIOR TO CONSTRUCTION TO HAVE MAIN AND SERVICE LINES FIELD LOCATED. —WHEN CenterPoint Energy PIPE LINE MARKINGS ARE NOT VISIBLE, CALL (713) 967—8037 (7:00 AM TO 4:30 PM). FOR STATUS OF LINE LOCATION REQUEST BEFORE EXCAVATION BEGINS. —WHEN EXCAVATING WITHIN EIGHTEEN INCHES (18") OF THE INDICATED LOCATION OF CENTERPOINT Energy FACILITIES, ALL EXCAVATION MUST BE ACCOMPLISHED USING NON—MECHANIZED EXCAVATION PROCEDURES. —WHEN CENTERPOINT Energy FACILITIES TO PREVENT EXCESSIVE STRESS ON PIPING. THE CONTRACTOR IS FULLY RESPONSIBLE FOR ANY DAMAGES CAUSED BY THE CONTRACTOR'S FAILURE TO EXACTLY LOCATE AND PRESERVE THESE UNDERGROUND FACILITIES.

#### <u> Warning: Overhead Electrical Facilities</u>

OVERHEAD LINES MAY EXIST ON THE PROPERTY. WE HAVE NOT ATTEMPTED TO MARK THOSE LINES SINCE THEY ARE CLEARLY VISIBLE, BUT YOU SHOULD LOCATE THEM PRIOR TO BEGINNING ANY CONSTRUCTION. TEXAS LAW, SECTION 752, HEALTH & SAFETY CODE, FORBIDS ALL ACTIVITIES IN WHICH PERSONS OR THINGS MAY COME WITHIN SIX (6) FEET OF LIVE OVERHEAD HIGH VOLTAGE LINES. PARTIES RESPONSIBLE FOR THE WORK, INCLUDING CONTRACTORS, ARE LEGALLY RESPONSIBLE FOR THE SAFETY OF CONSTRUCTION WORKERS UNDER THIS LAW. THIS LAW CARRIES BOTH CRIMINAL AND CIVIL LIABILITY. TO ARRANGE FOR LINES TO BE TURNED OFF OR REMOVED CALL CENTER POINT ENERGY AT 713-207-2222.

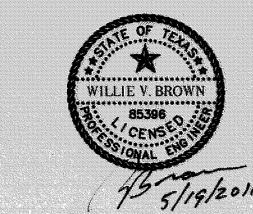




HOUSTON, TEXAS 77054 (713) 680-0080 FAX (713) 680-0738 TBPE FIRM NO. F-002518

HOUSTON COMMUNITY COLLEGE **CENTRAL CAMPUS GENERAL NOTES** 

NOTE: CITY SIGNATURES VALID FOR ONE YEAR ONLY AFTER DATE OF SIGNATURES CITY OF HOUSTON DEPARTMENT OF PUBLIC WORKS AND ENGINEERING WATER STORE STORE STORE STORE STORE STORE WATER CLARITY STORE STORE WATER CLARITY STOR

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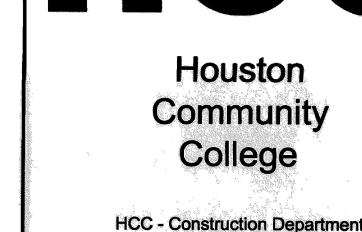


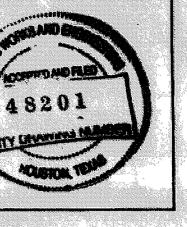FOR CITY OF HOUSTON USE ONLY

TRAFFIC CONTROL PLAN

Scale: NTS

C-14.0



3100 Main, 12th Floor

Houston, Texas, 77002

Voice: 713.718.5168

reynaldo.pradia@hccs.edu

Issue/Revision: REV DESCRIPTION ISSUED FOR BID & CONSTRUCTION


I llewelyn-davies sahni architecture + planning + design

5120 Woodway, Suite 8010 Houston, TX 77056 p: 713.850.1500 f: 713.850.1023 e: info@theldnet.com



NVIRONMENTS&co ARCHITECTURE . INTERIORS . LANDSCAPE . PLANNING 21550 Provincial Blvd., Bldg. 4, #413 Katy, Texas 77450 281-759-1513 ph 281-759-1723 fx

> STUDIO OF RICHARD JETER MFA LIGHTING DESIGNER 19409 PEBBLE BEND DR HOUSTON, TEXAS 17068

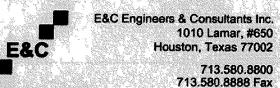

**Central Campus** 

Parking Lot Improvements

713.580.8800

A/E Project No.:


1300 Holman Street Houston, TX 77004

Contract No.: Drawn By: Checked By: Approved By:

Ownership of Instruments of Service: All reports, plans, specifications, computer files, field data notes & other documents and instruments prepared for Houston Community College as instruments of service shall become the property of Houston Communit College. Houston Community College shall gain all common law, statutory and other reserved

rights, including the copyright thereto.

**GENERAL NOTES** 

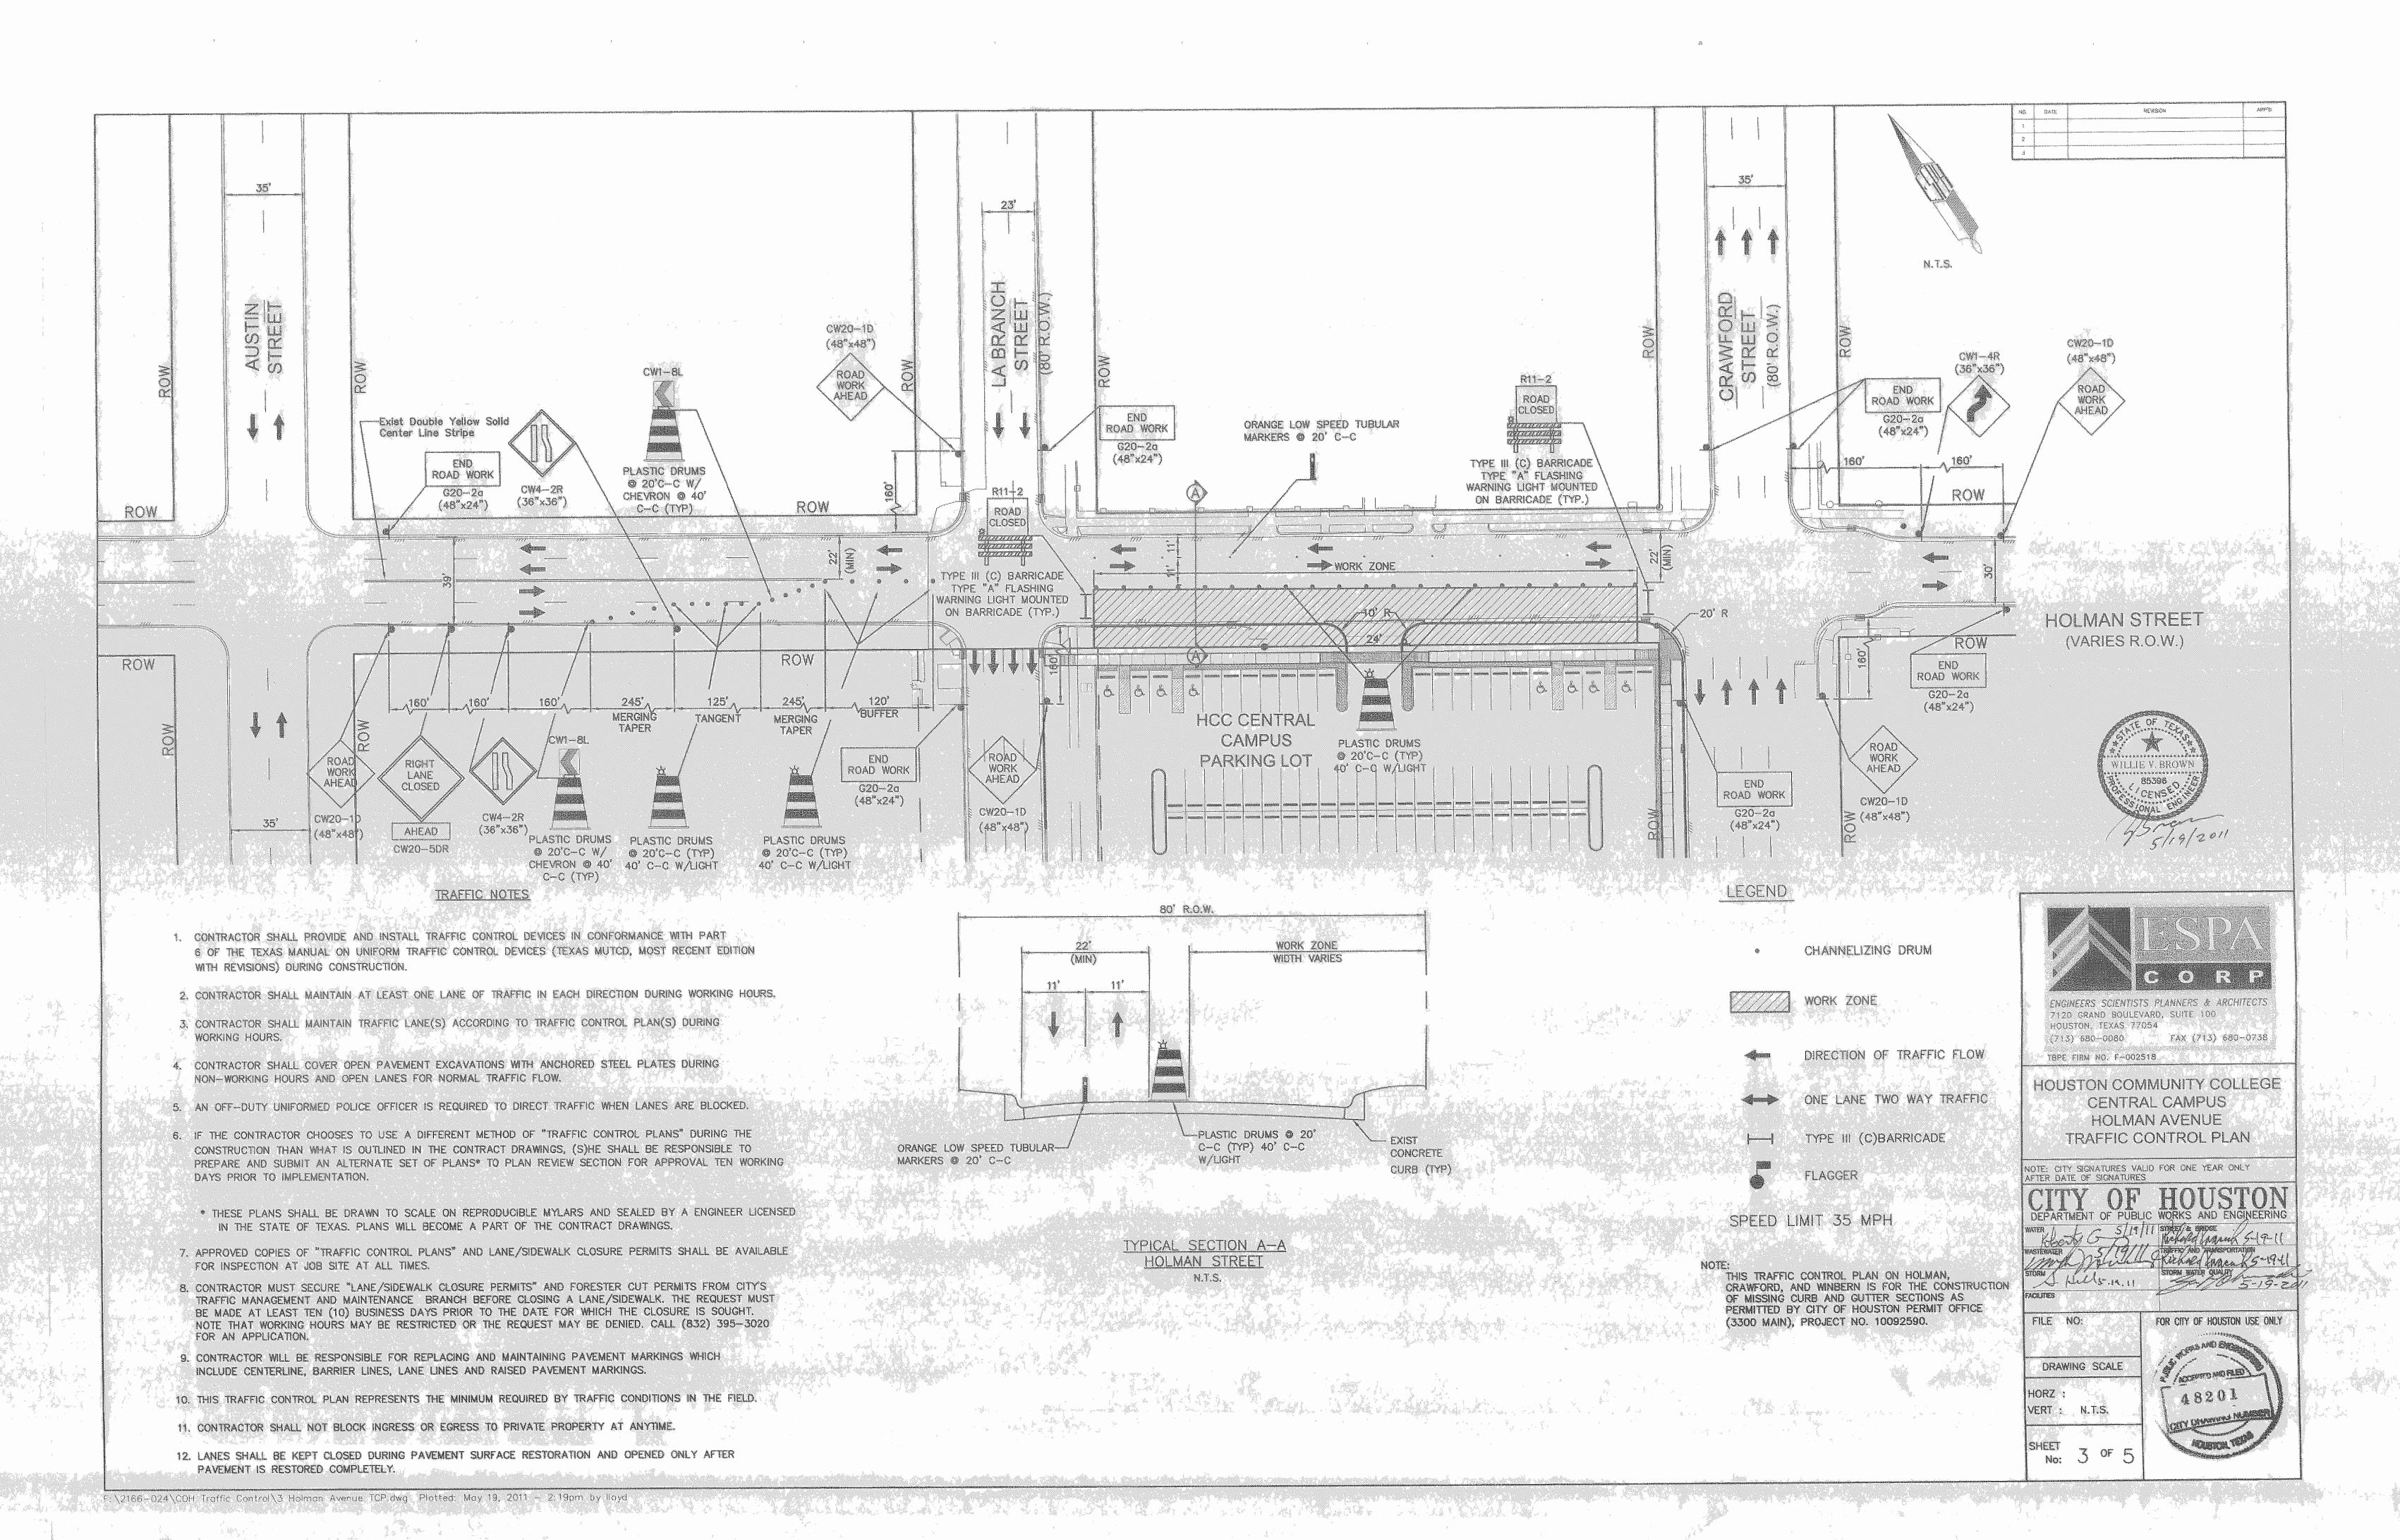

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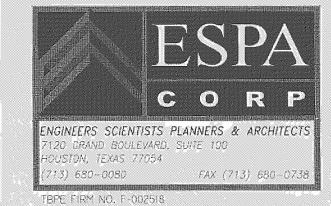
# Houston Community College

HCC - Construction Department 3100 Main, 12th Floor Houston, Texas, 77002 Voice: 713.718.5168 reynaldo.pradia@hccs.edu

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### Ilewelyn-davies sahni architecture + planning + design

5120 Woodway, Suite 8010 Houston, TX 77056 p: 713.850.1500 f: 713.850.1023 e: info@theldnet.com



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ARCHITECTURE \* INTERIORS \* LANDSCAPE \* PLANNING 21550 Provincial Blvd., Bldg. 4, #413 Katy, Texas 77450 281–759–1513 ph 281–759–1723 fx

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HOUSTON, TEXAS 17068



ineers & Consultants Inc. 1010 Lamar, #650 Houston, Texas 77002 713.580.8880 713.580.8888 Fax

A/E Project No.:

# Central Campus Parking Lot Improvements

1300 Holman Street Houston, TX 77004

Contract No.:
Drawn By:
Checked By:

Drawn By: Checked By: Approved By:


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# HOLMAN AVENUE TRAFFIC CONTROL PLAN

Scale: NTS


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#### II llewelyn-davies sahni

architecture + planning + design
5120 Woodway, Suite 8010
Houston, TX 77056
p: 713.850.1500
f: 713.850.1023
e: info@theldnet.com

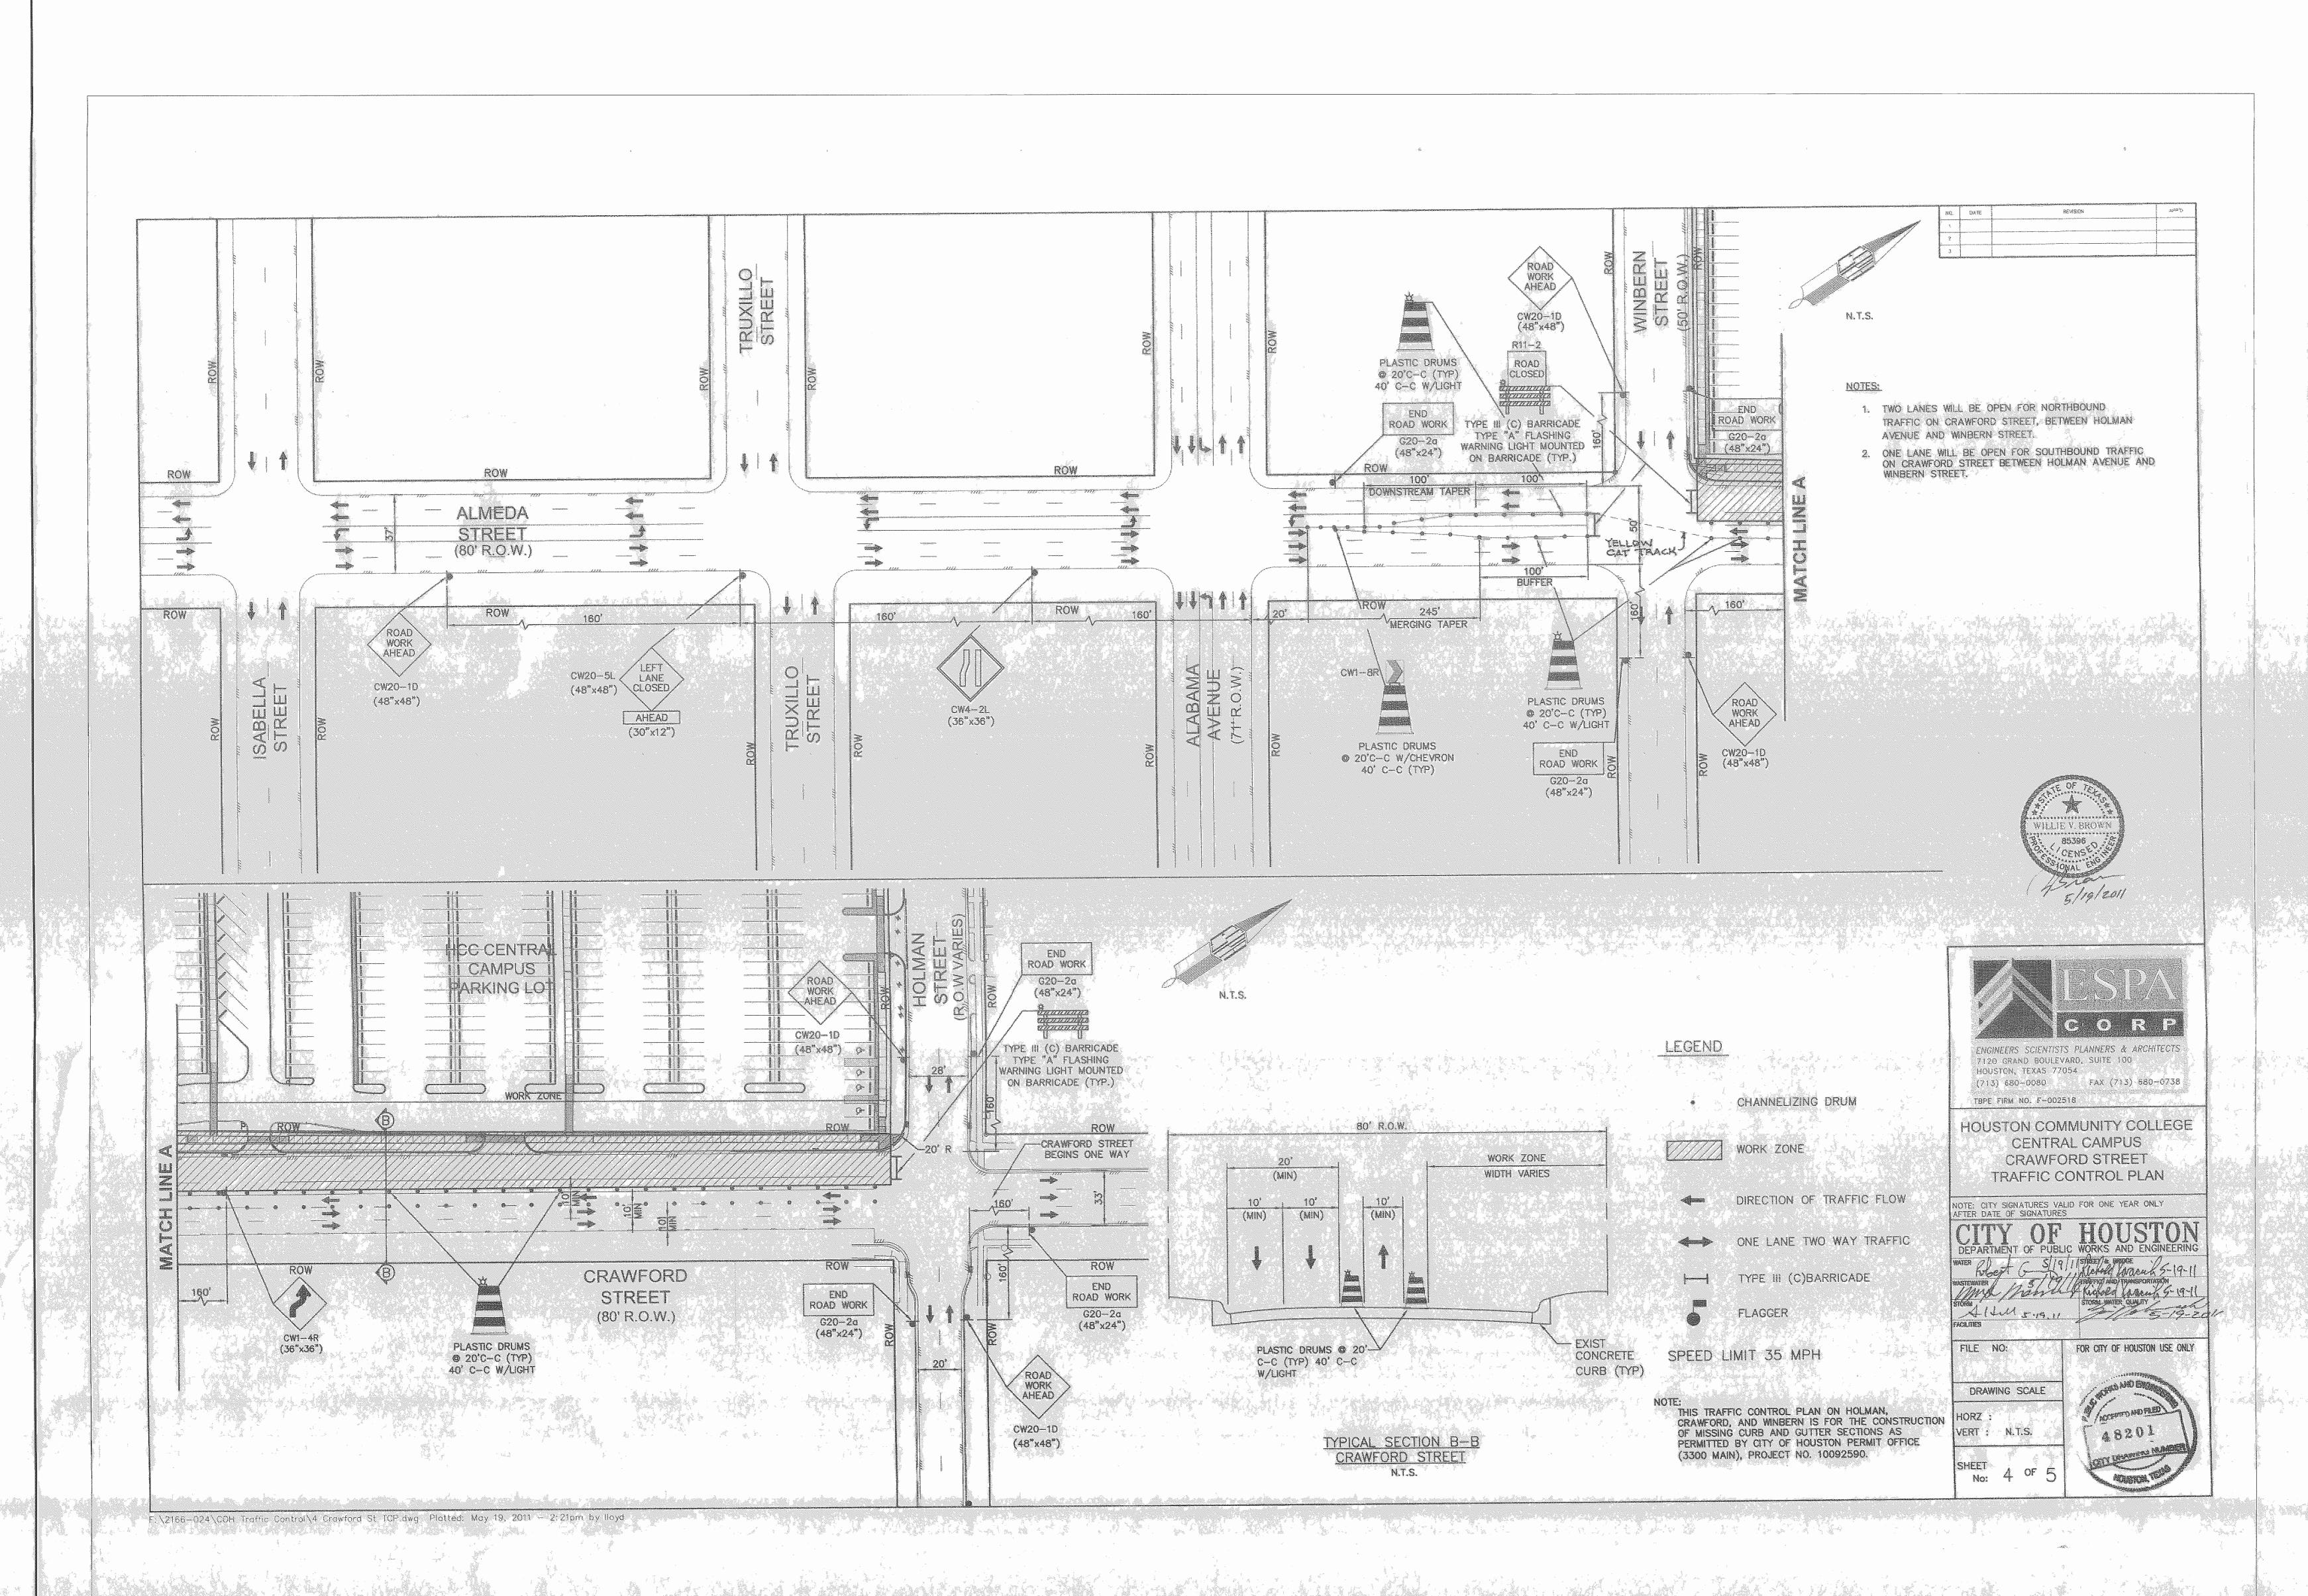

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LIGHTING DESIGNER 15908 PESBLE BEND DR.
HOUSTON, TEXAS TTOBS
E&C Engineers & Consultants Inc. 1010 Lamar, #650 Houston, Texas 77002

# Central Campus Parking Lot Improvements

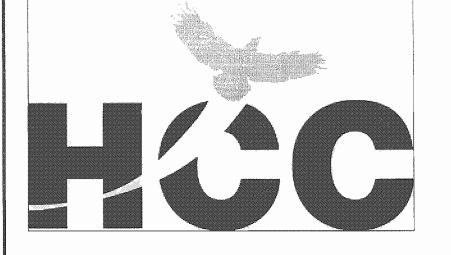713.580.8800 713.580.8888 Fax

1300 Holman Street Houston, TX 77004


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Drawn By:	Date:
Checked By:	Date:
Approved By:	 Date:

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# CRAWFORD STREET TRAFFIC CONTROL PLAN

Scale: NTS

C-16.0

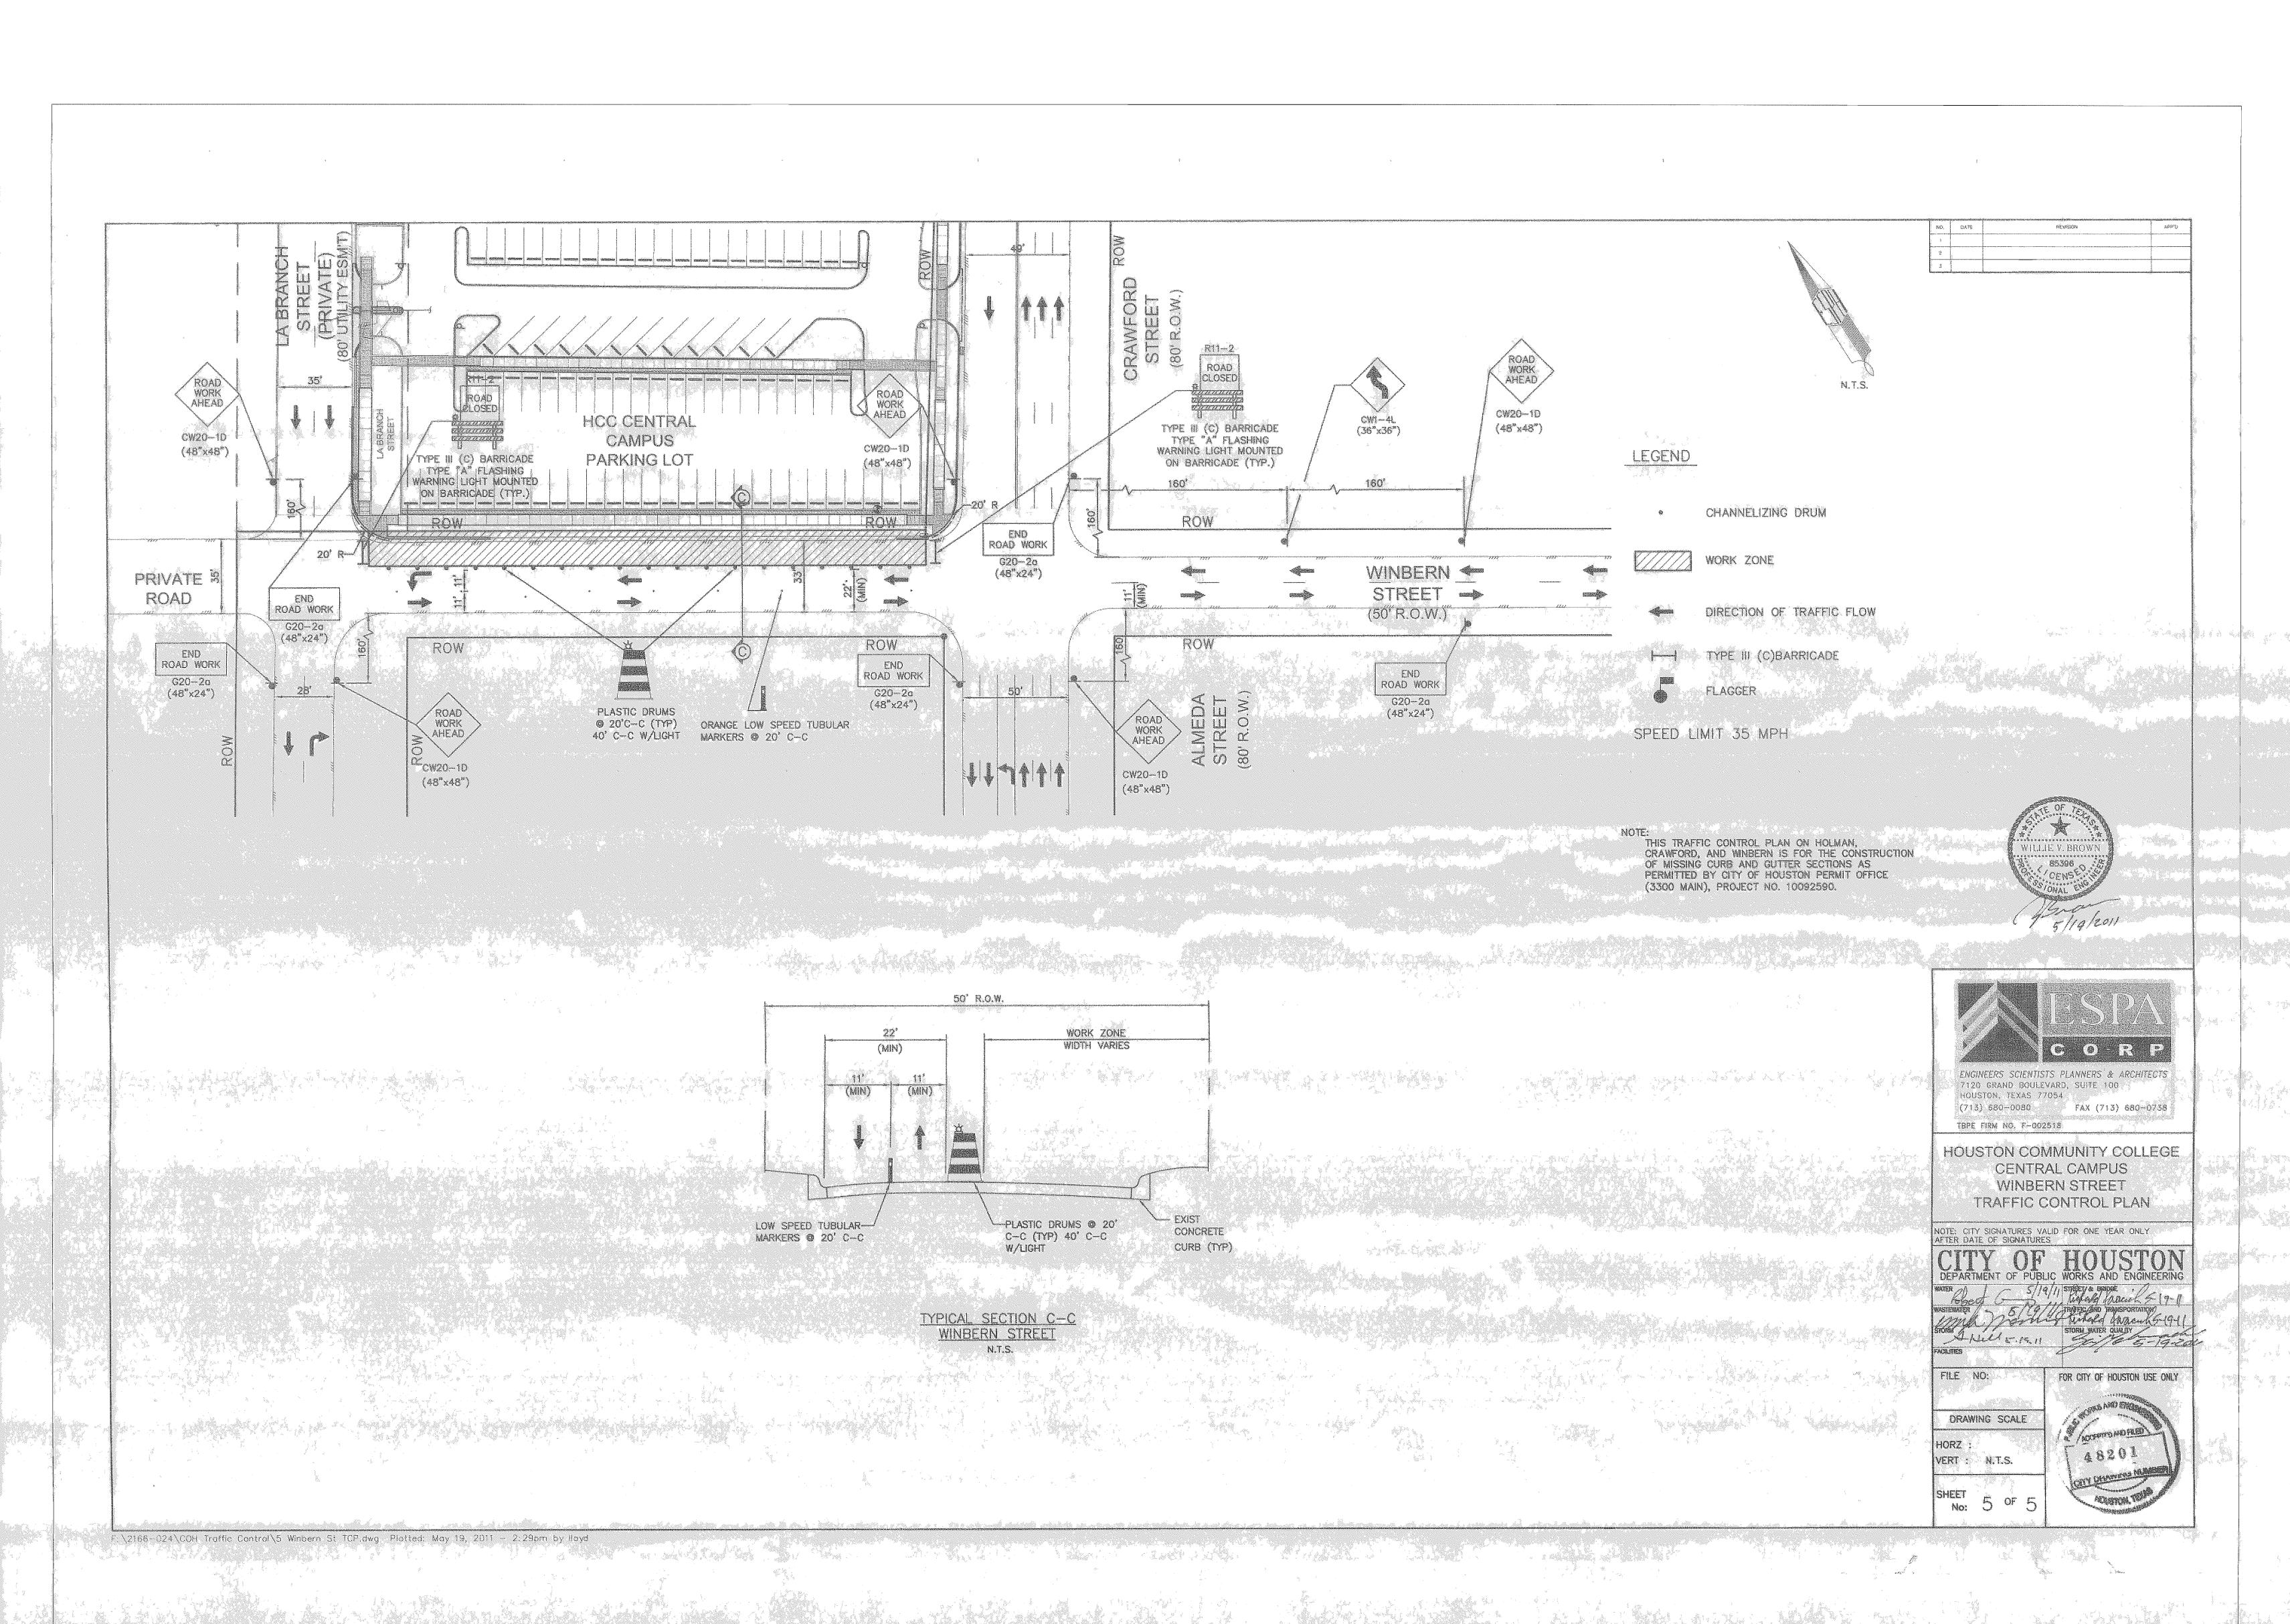

F: \2166-024\C17.0 Winbern Street TCP.dwg Plotted: Jun 02, 2011 - 11:29am by lloyd




#### Houston Community College

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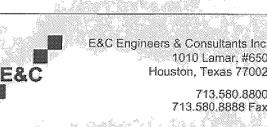
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5120 Woodway, Suite 8010 Houston, TX 77056 p: 713.850.1500 f: 713.850.1023 e: info@theldnet.com



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> STUDIO OF RICHARD JETER MFA LIGHTING DESIGNER 15903 PEBBLE BEND DR.

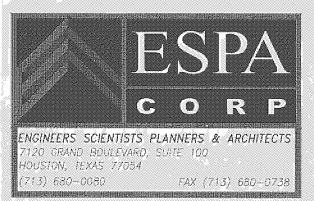

# Central Campus Parking Lot Improvements

1300 Holman Street Houston, TX 77004

Contract No.:
Drawn By:
Checked By:
Approved By:


Date: Date: Date;

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WINBERN STREET
TRAFFIC CONTROL PLAN

Scale: NTS

C-17.0

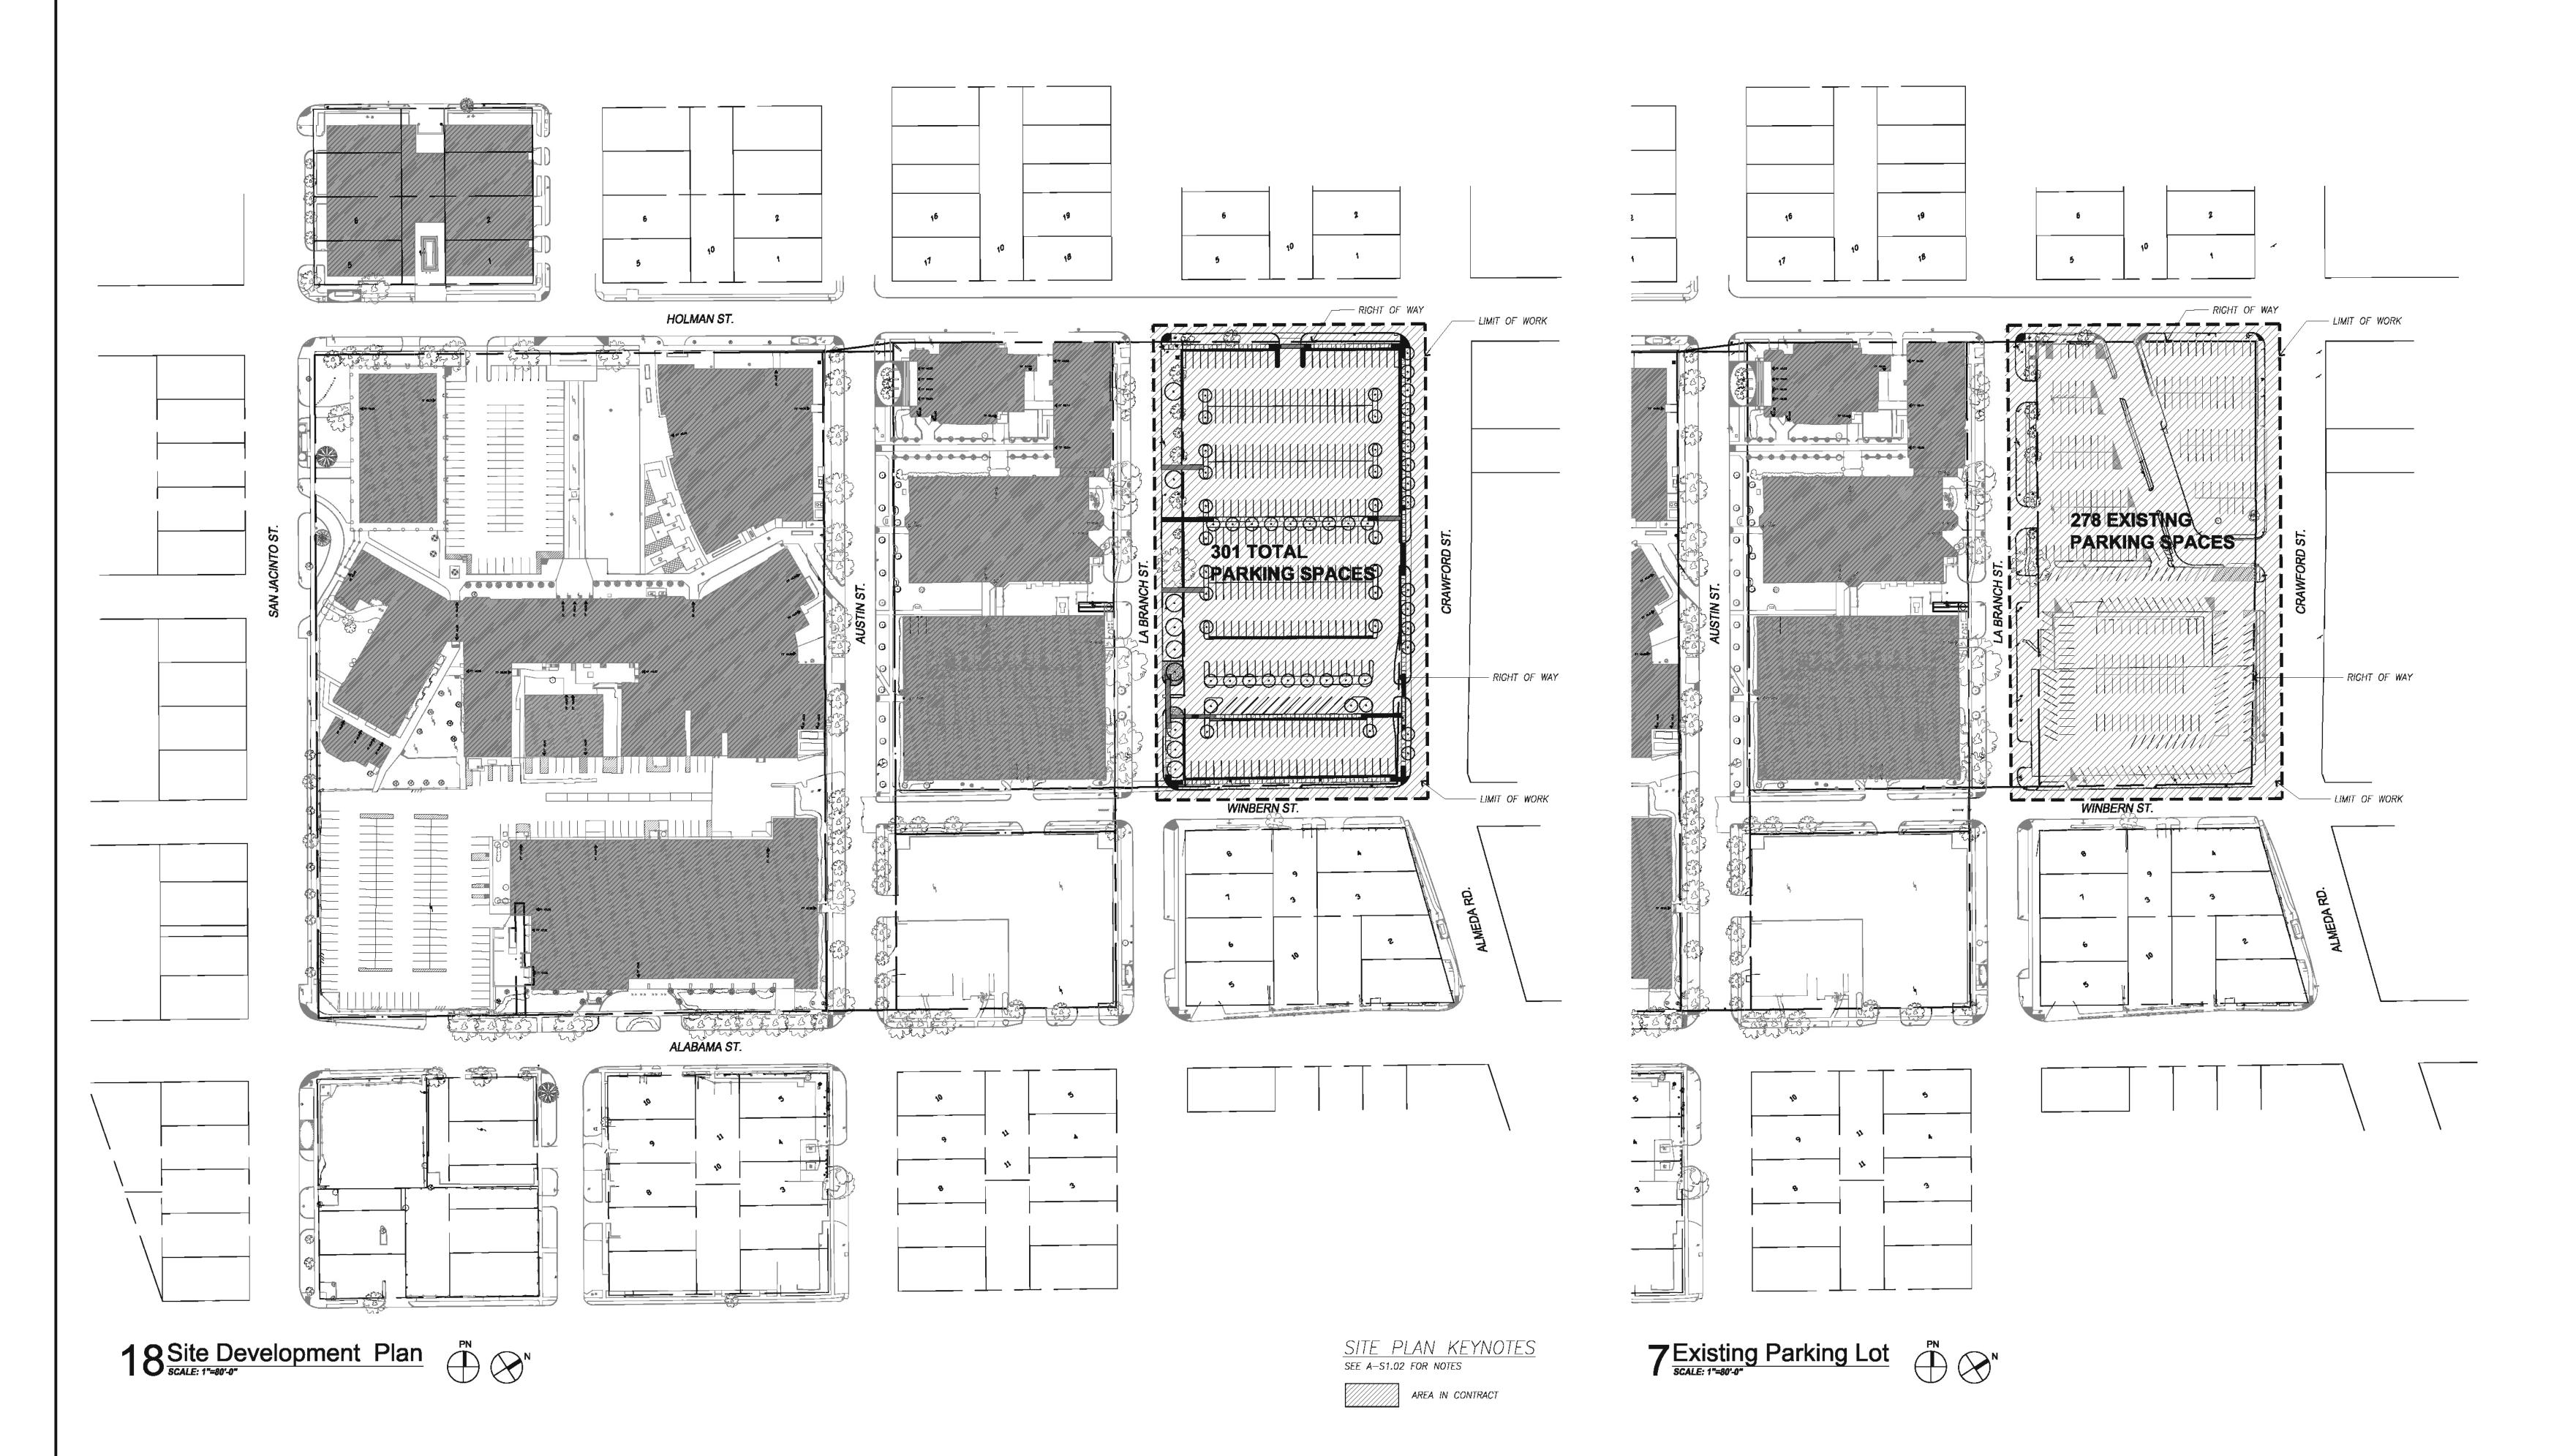

**GENERAL NOTES:** 

1. CONTRACTOR TO NOTIFY ARCHITECT OF ANY DIMENSIONAL DISCREPANCY FOUND IN FIELD THAT CONTRADICTS WHAT IS IN THE DOCUMENTS.

2. REFER TO IT/AV PACKAGE DRAWINGS SET FOR PHONE/DATA EXACT LOCATIONS. ALL CONSTRUCTION MUST CONFORM TO THE AMERICANS WITH DISABILITIES ACT GUIDELINES AND TEXAS ACCESSIBILITY STANDARDS, WHICHEVER IS MOST STRINGENT. RE: 25A6.01

 REFER TO MEP DRAWINGS FOR LIFE SAFETY DEVICE LOCATIONS.
 ALL DETAILS OF CONSTRUCTION SHALL CONFORM WITH 2003 INTERNATIONAL BUILDING CODE AND ALL LOCAL PRESIDING CODES AND AMENDMENTS AND LEGAL DOCUMENTS.

5. THE GENERAL CONTRACTOR SHALL BE SOLELY RESPONSIBLE FOR THE DESIGN ADEQUACY AND SAFETY OF ERECTION BRACING, SHORING, AND TEMPORARY SUPPORTS, ETC.

6. THE GENERAL CONTRACTOR IS RESPONSIBLE FOR THE STABILITY OF THE STRUCTURE PRIOR TO THE APPLICATION OF ALL SHEAR WALLS, ROOF SHEATHING, STRUCTURAL ELEMENTS, AND FINISH MATERIALS.

7. ALL WORK RELATED TO EXISTING SOILS MUST FOLLOW HEALTH & SAFETY

LANDSCAPE REQUIREMENTS:

Sec. 33-126, 127 AND 128:

A. STREET TREES: Length of property line in lineal feet as measured along each street separately.

lineal feet of property fronting on a public street/30= Street trees required along street

1. HOLEMAN STREET = 285 lineol feet/30=9.5=10 Street trees along HOLEMAN STREET; 4 CREDITS TAKEN FOR PROVIDING 4" CALIPER TREES; 6 STREET TREES PROVIDED

2. CRAWFORD STREET =519 lineol feet/30=17.3=17 Street trees along CRAWFORD STREET; 4 CREDITS TAKEN FOR PROVIDING 4" CALIBER TREES, 13 STREET TREES PROVIDED.

TAKEN FOR PROVIDING 4" CALIPER TREES; 13 STREET TREES PROVIDED

3. WINBERN STREET =385 lineal feet/30=9.5=10 Street trees along WNBERN STREET;

2 CREDITS TAKEN FOR PROVIDING 4" CALIPER TREES; 8 STREET TREES PROVIDED

4. LA BRANCH STREET =519 lineal feet/30=17.3=17 Street trees along LA BRANCH STREET; 7 CREDITS

TAKEN FOR PROVIDING 4" CALIPER TREES; 10 STREET TREES PROVIDED

TOTAL NUMBER OF STREET TREES REQUIRED: 54
37 PROVIDED / 54 REQUIRED = 69% PROVIDED

B. PARKING LOT TREES: Number of porking stalls to be constructed 306/10 = 30.6 = 31 Parking

B. PARKING LOT TREES: Number of porking stalls to be constructed 306/10 = 30.6 = 31 Parking LOT TREES REQUIRED. 50% MUST BE LARGE PARKING LOT TREE TYPES;
41 TREES PROVIDED. 41 PROVIDED / 31 REQUIRED = 132%
C. SHRUBS: Total number of street trees required, from A. above x 10 = 540 shrubs. 75% (405) MUST BE PLANTED ALONG THE PERIMETER OF THE PARKING LOT. 442 SHRUBS PROVIDED.

D. LANDSCAPE BUFFER: 6' high screening fence, or 15' wide evergreen planting strip.

Total length of property line adjacent to existing single—family residential, or limit of expansion adjacent to existing single—family residential. SCREEN FENCE NOT REQUIRED

Sec. 33—122 (c1) PROTECTED TREE REPLACEMENT: NOT APPLICABLE. NO TREES BEING REMOVED.

Sec. 33-123 (a) TREE PLANTING EQUIVALENCY CREDITS:

1. Proposed Street and Parking Lot trees equal to or exceeding 4" caliper times

1. 78 x 1 = 78\_TREE CREDITS POSSIBLE; 17 CREDITS TAKEN

Depositing of monies with Parks and Recreation Department.
 \$135 per fifteen gallon container grown tree. Proposed credits can not exceed 30% of C. above. Amount to be deposited = proposed credits



Houston Community College

HCC - Construction Department 3100 Main, 12th Floor Houston, Texas, 77002 Voice: 713.718.5168 reynaldo.pradia@hccs.edu



Issue/Revision:

REV | DESCRIPTION | DATE | BY

1 | ISSUED FOR BID & CONSTRUCTION | 05/09/11 | JA

Ilewelyn-davies sahni

architecture + planning + design

5120 Woodway, Suite 8010
Houston, TX 77056
p: 713.850.1500
f: 713.850.1023
e: info@theldnet.com



ENVIRONMENTS & CO ARCHITECTURE • INTERIORS • LANDSCAPE • PLANNING 21550 Provincial Blvd., Bldg. 4, #413 Katy, Texas 77450 281-759-1513 ph 281-759-1723 fx

STUDIO OF RICHARD JETER MFA LIGHTING DESIGNER 15903 PEBBLE BEND DR. HOUSTON, TEXAS T1068



1010 Lamar, #650 Houston, Texas 77002 713.580.8800 713.580.8888 Fax

Central Campus
Parking Lot Improvements

1300 Holman Street Houston, TX 77004

Contract No.: A/E Project
Drawn By: XX Date: >

Contract No.:

Drawn By: XX

Checked By:

Approved By:

Date:

Date:

Date:

Ownership of Instruments of Service:

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Site Development

Scale: 1" = 80'-0"

**GENERAL NOTES:** 

1. CONTRACTOR TO NOTIFY ARCHITECT OF ANY DIMENSIONAL DISCREPANCY FOUND IN FIELD THAT CONTRADICTS WHAT IS IN THE DOCUMENTS.

2. ALL WORK RELATED TO EXISTING SOILS MUST FOLLOW HEALTH & SAFETY REPORT

3. FOR SHADED AREAS ON DRAWING 9/AS-1.01, SEE 10/AS-6.00 & TREE PROTECTION DETAIL D3/L1.00.


4. FOR SHADED AREAS ON DRAWING 9/AS-1.01 & 10/AS-6.00, DEMOLITION TO BE DONE BY HAND, SEE TREE PROTECTION DETAIL D3/L1.00.

5. BREAK UP AND TEST SOIL IN <u>ALL</u> AREAS WHERE NEW PARKING LOT & STREET TREES ARE TO BE PLANTED.

6. AMEND SOIL AS REQUIRED BY SOIL TESTING RESULTS IN ALL AREAS WHERE NEW PARKING LOT & STREET TREES ARE TO BE PLANTED.

7. SHADED AREAS ON DRAWING 9/AS-1.01 ARE SHOWN FOR TYPICAL EXTENT OF SOIL WORK IN LOCATIONS UNDER NEW STREET & PARKING LOT TREES. SOIL WORK TO BE PERFORMED WHERE

ALL NEW TREES ARE LOCATED.

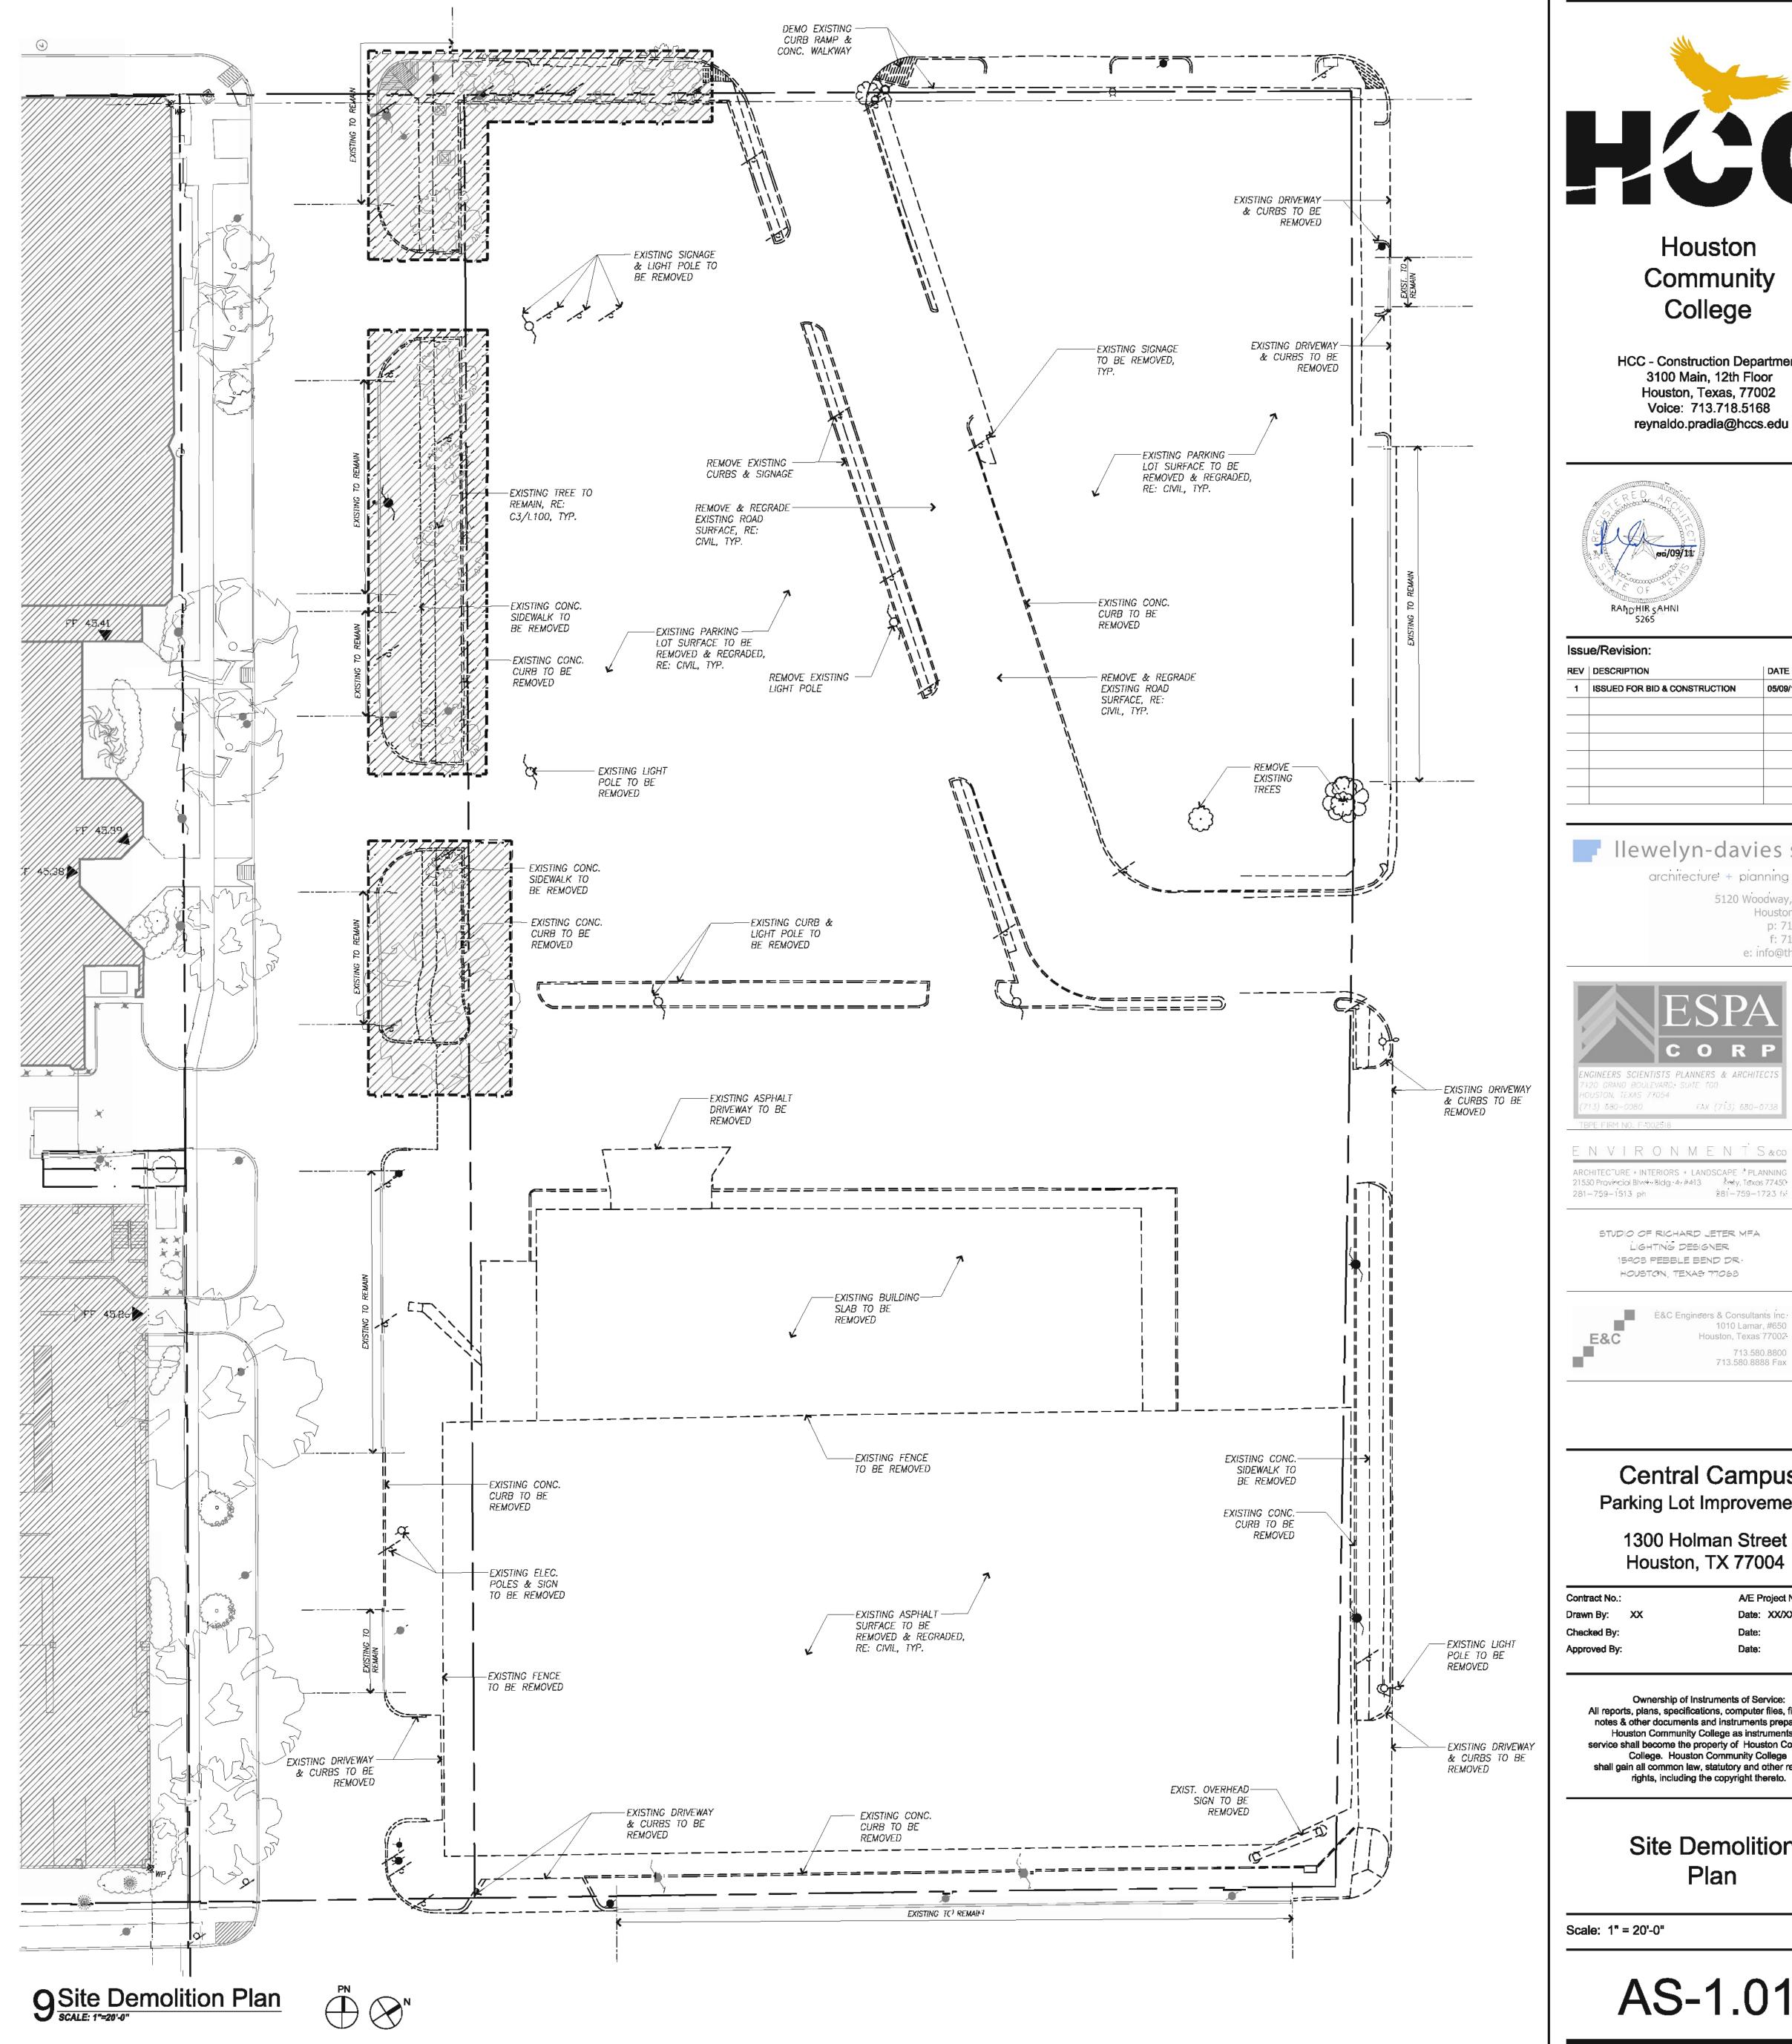



#### Houston Community College


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	05/09/11	JA

#### Ilewelyn-davies sahni

architecture + planning + design 5120 Woodway, Suite 8010 p: 713.850.1500 f: 713.850.1023 e: info@theldnet.com



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> STUDIO OF RICHARD JETER MFA LIGHTING DESIGNER 15903 PEBBLE BEND DR. HOUSTON, TEXAS 77068

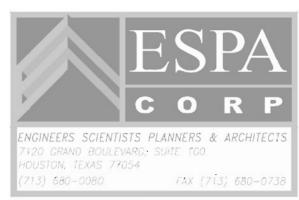

#### Central Campus Parking Lot Improvements

1300 Holman Street Houston, TX 77004


Contract No.: A/E Project No.: Drawn By: XX Date: XX/XX/XX Checked By:

Ownership of Instruments of Service: All reports, plans, specifications, computer files, field data, notes & other documents and instruments prepared for Houston Community College as instruments of service shall become the property of Houston Community College. Houston Community College shall gain all common law, statutory and other reserved

> Site Demolition Plan

rights, including the copyright thereto.

Scale: 1" = 20'-0"

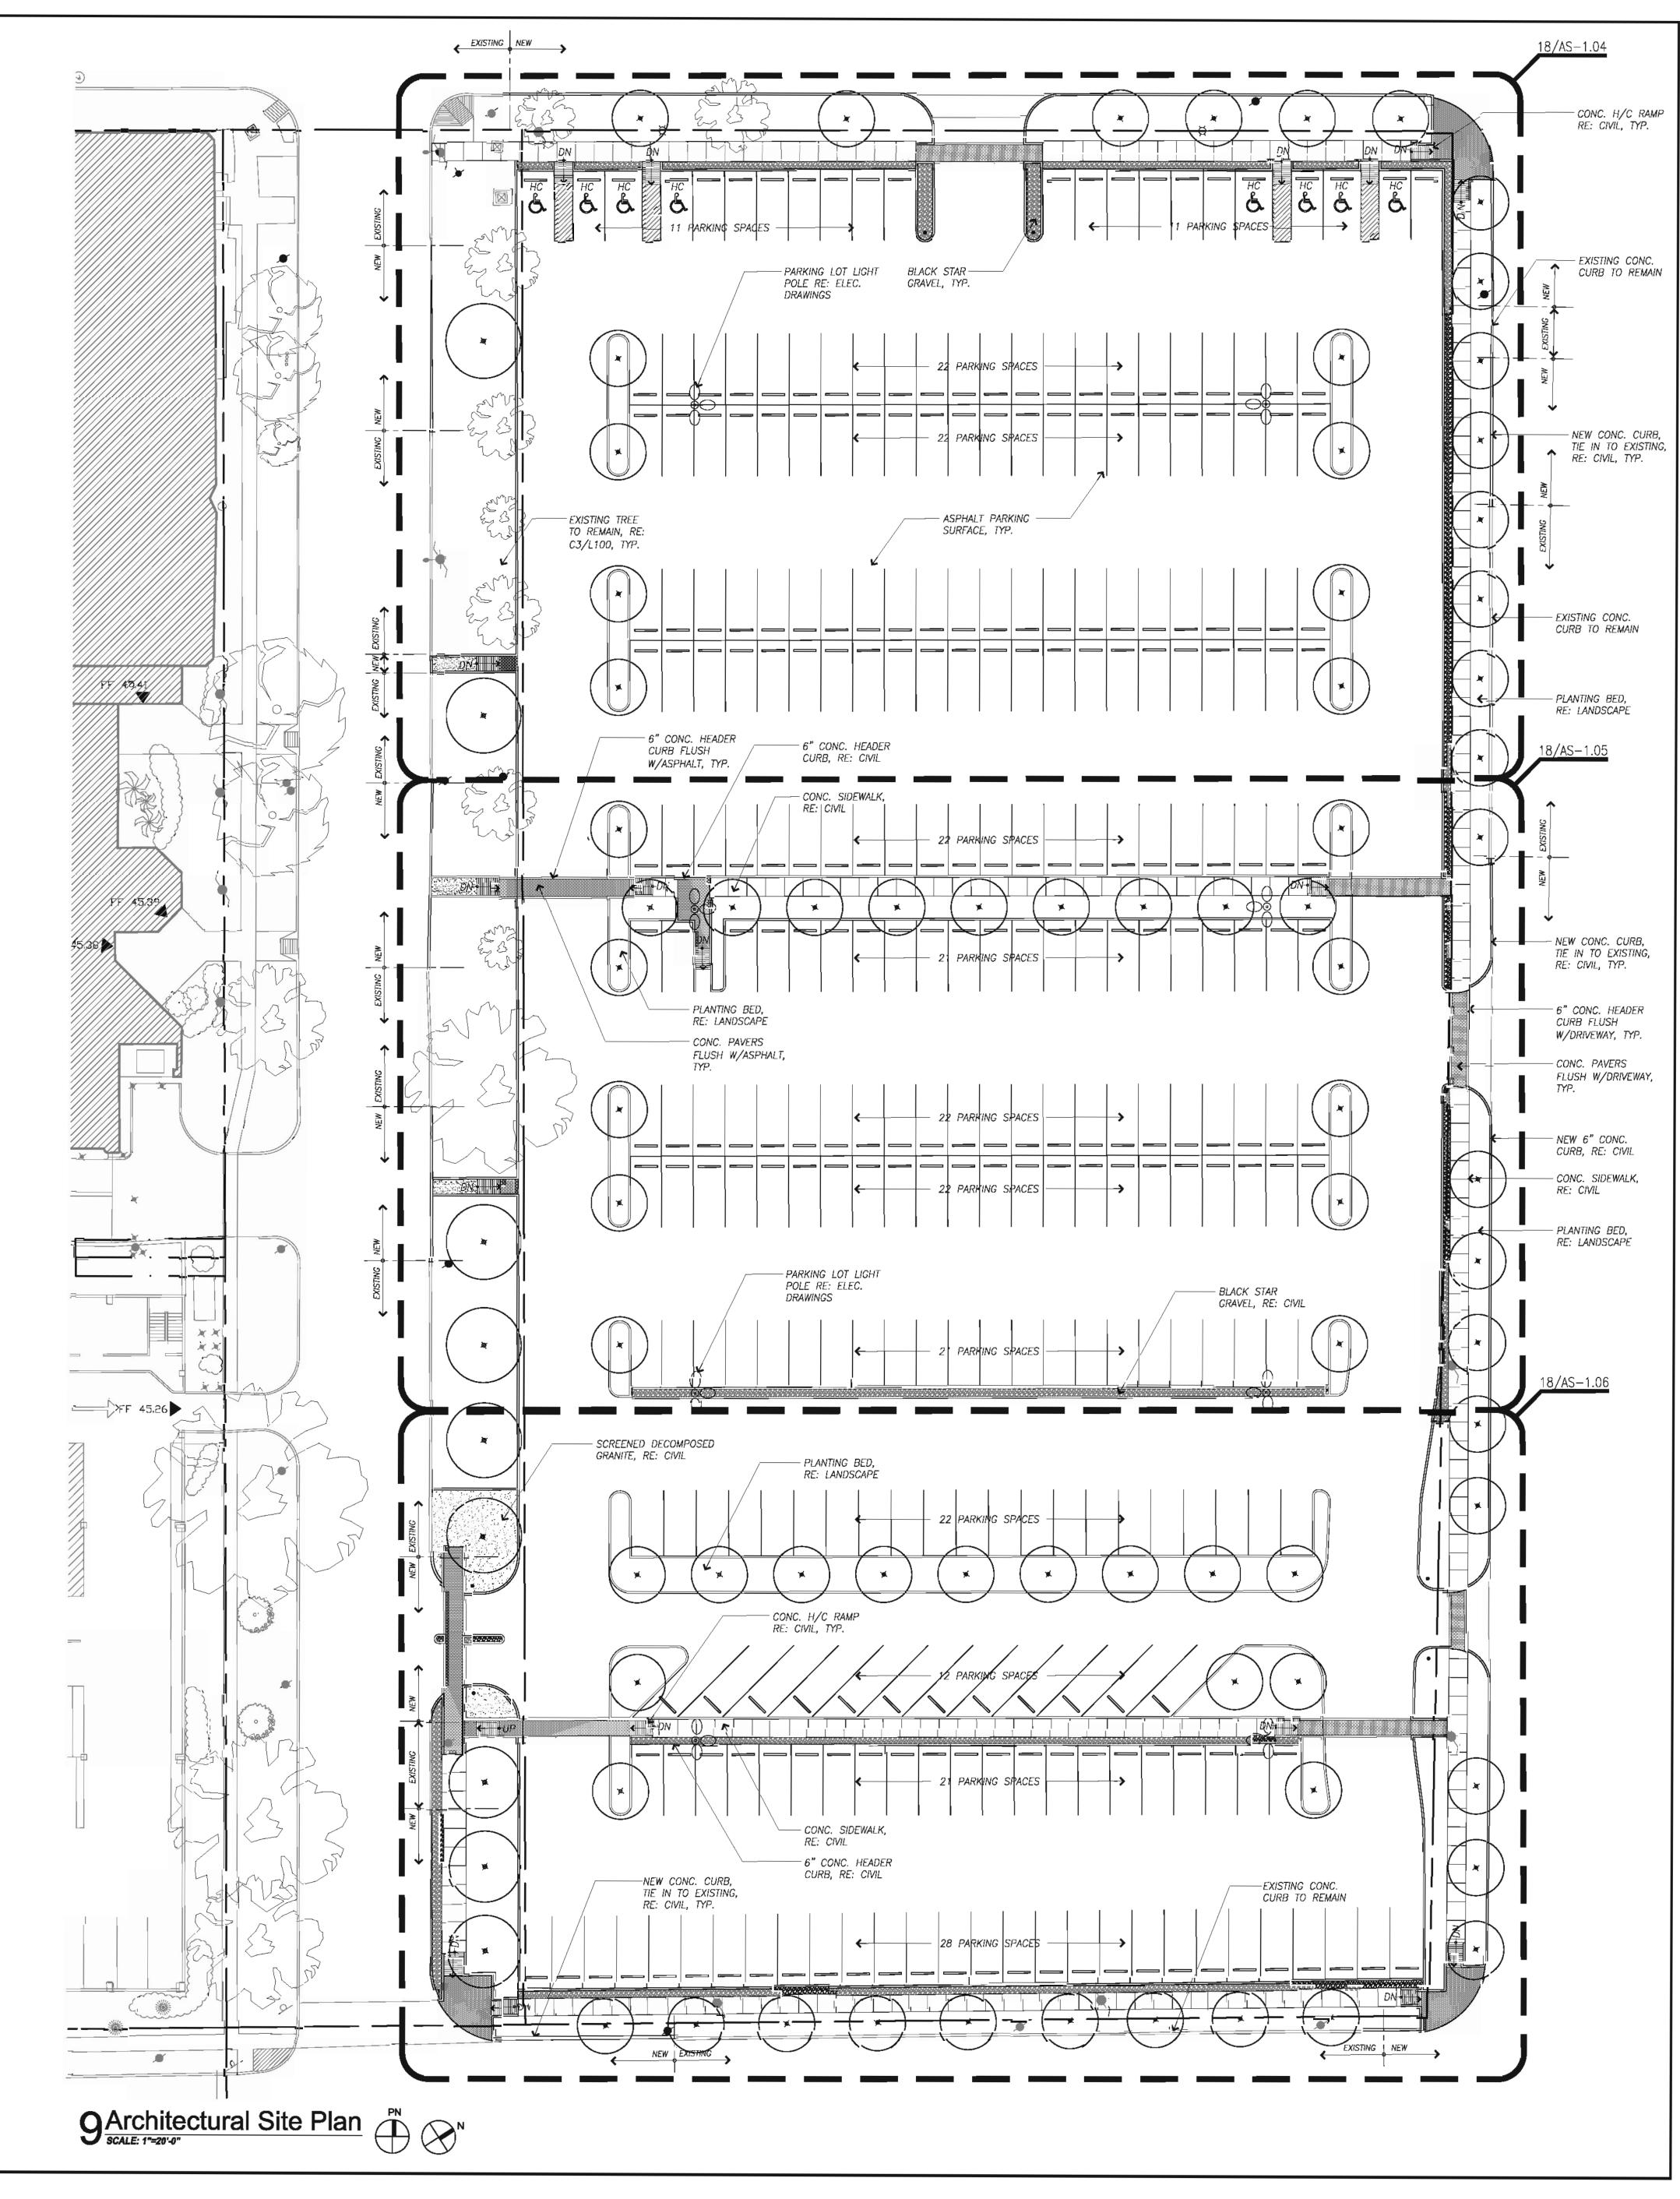



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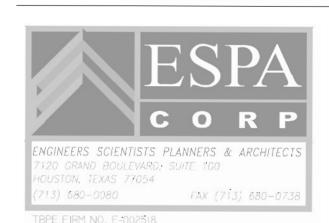
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Houston, TX 77056

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f: 713.850.1023
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### Central Campus Parking Lot Improvements

1300 Holman Street Houston, TX 77004

Contract No.:

Drawn By: XX

Checked By:

Approved By:

A/E Project No.:

Date: XX/XX/XX

Date:


Date:

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Architectural Site Plan

Scale: 1" = 20'-0"



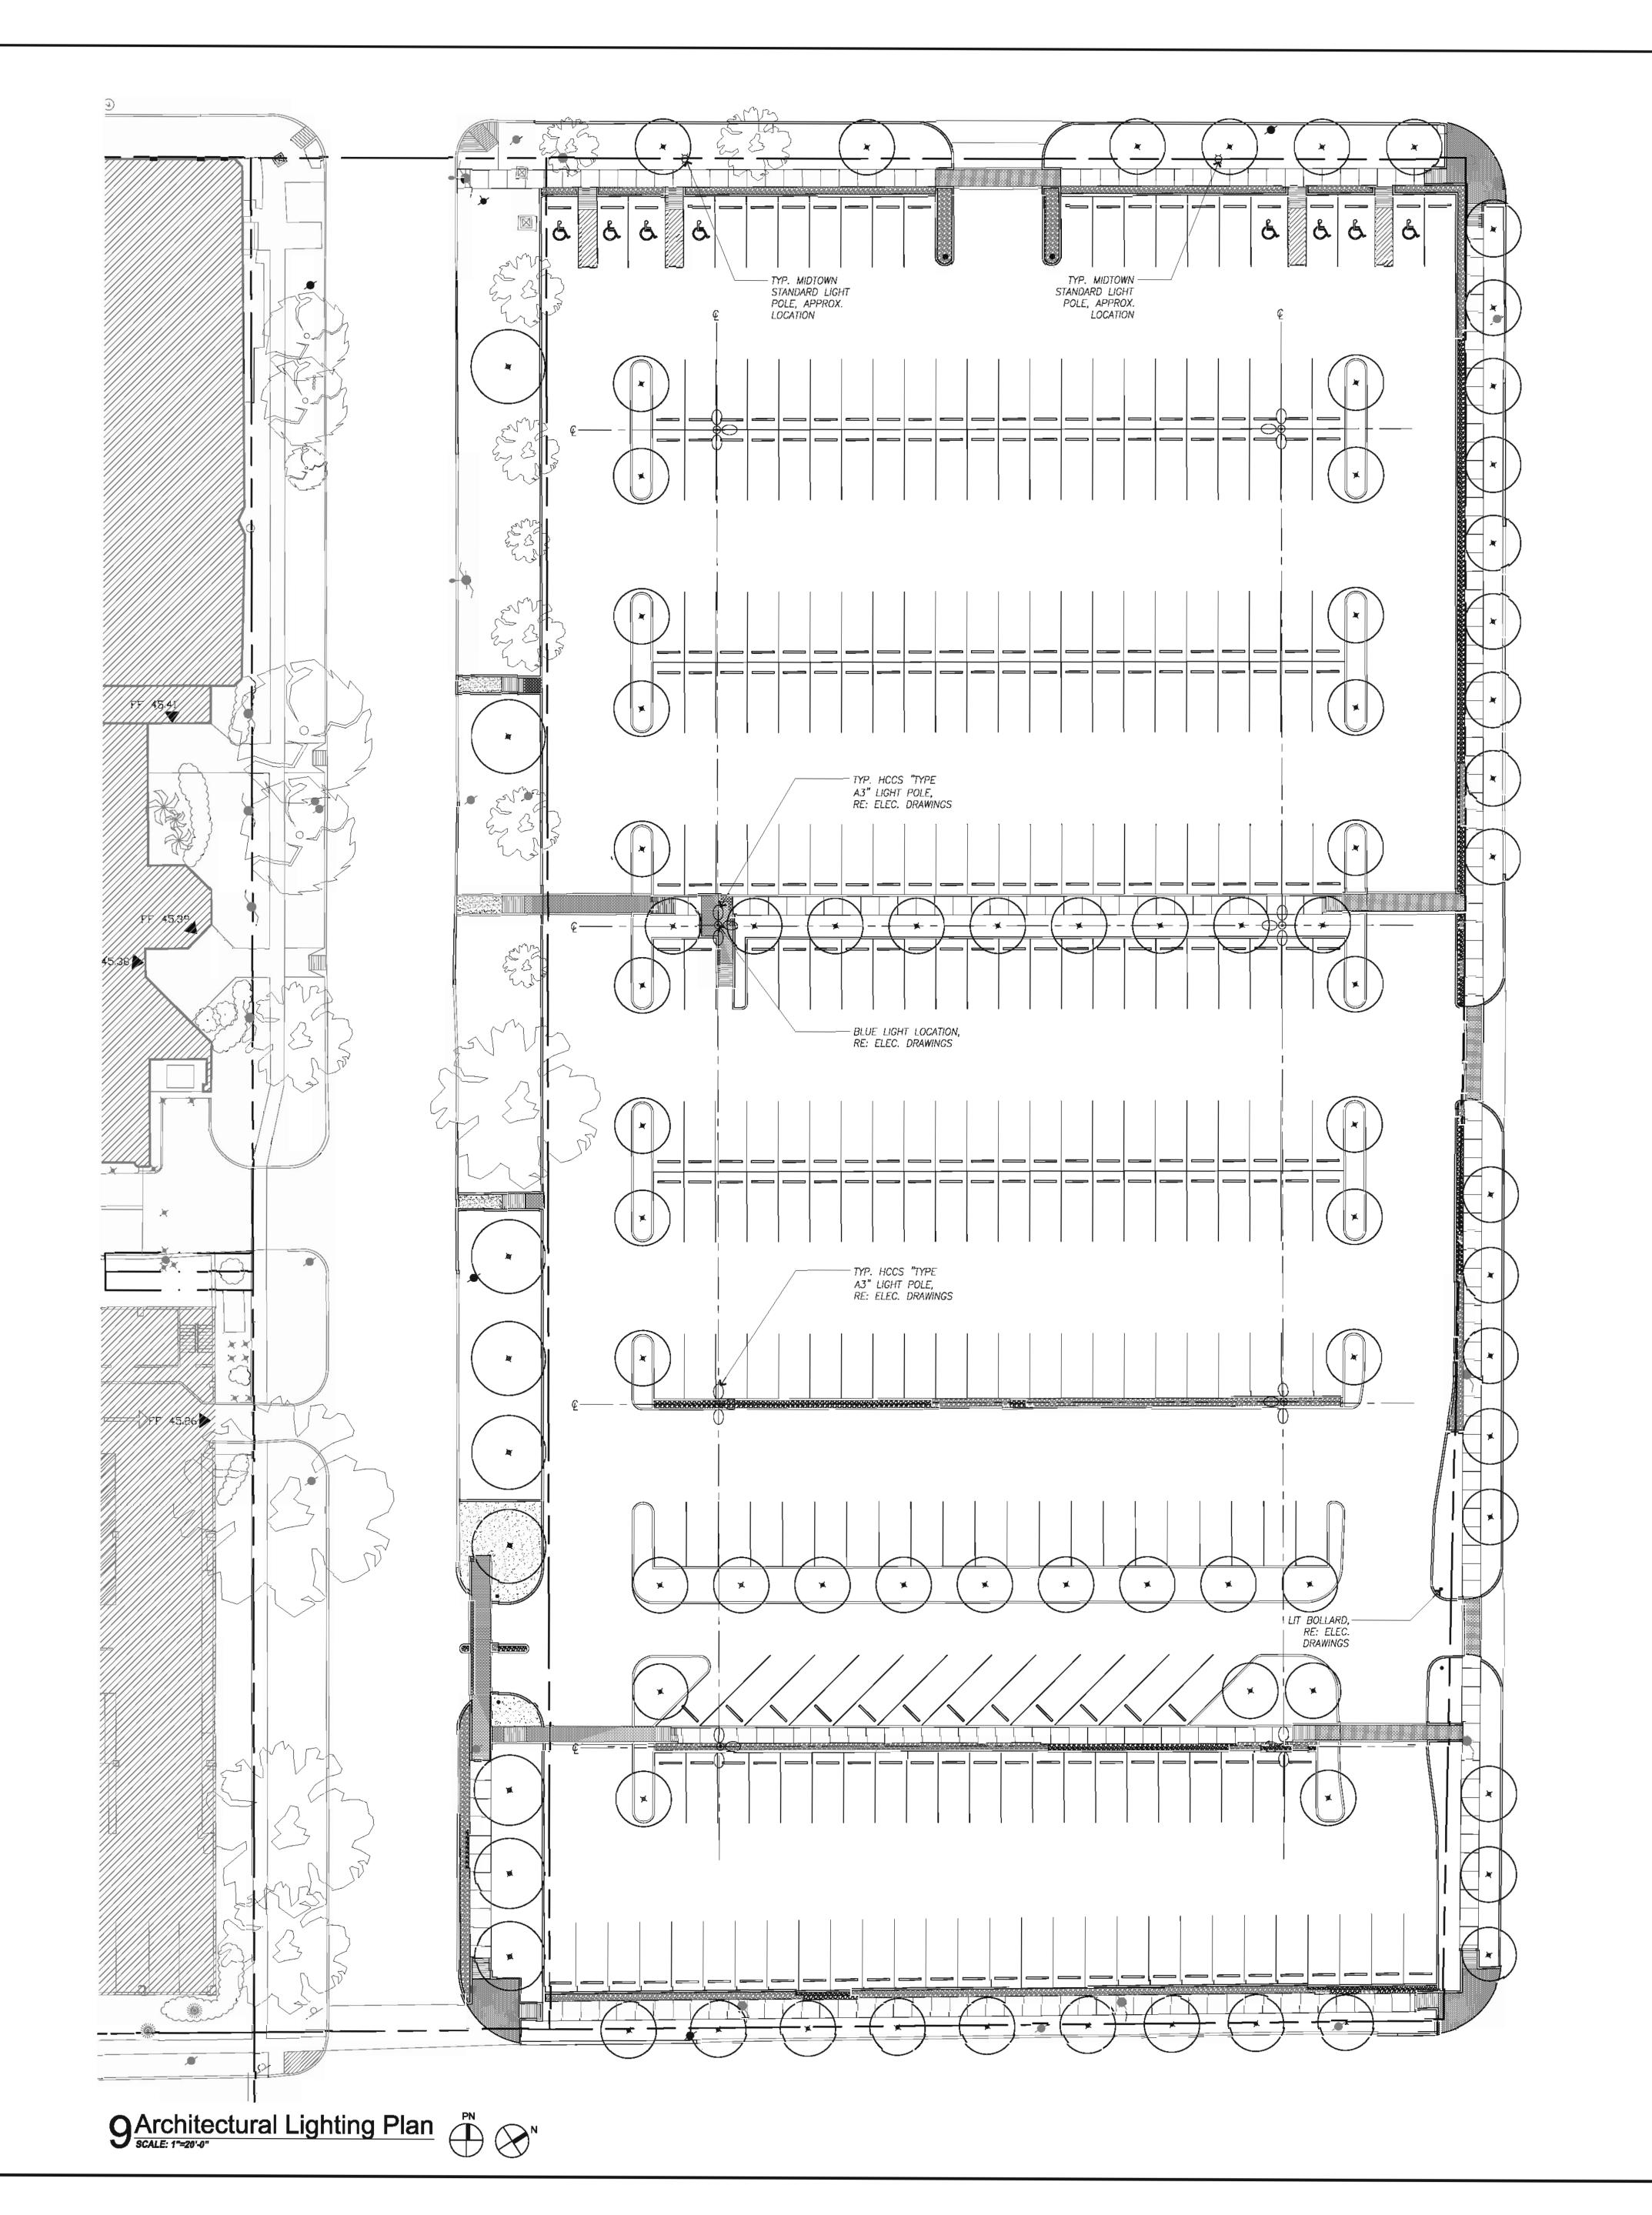

College

HCC - Construction Department
3100 Main, 12th Floor

Houston, Texas, 77002 Voice: 713.718.5168 reynaldo.pradia@hccs.edu

Houston

Community




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5120 Woodway, Suite 8010
Houston, TX 77056
p: 713.850.1500
f: 713.850.1023
e: info@theldnet.com



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281-759-1513 ph 281-759-1723 fx

STUDIO OF RICHARD JETER MFA LIGHTING DESIGNER 15903 PEBBLE BEND DR HOUSTON, TEXAS 77068

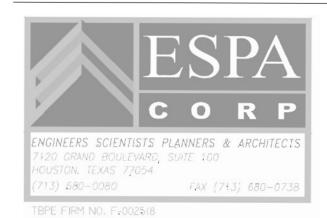

E&C Engineers & Consultants Inc. 1010 Lamar, #650 Houston, Texas 77002 713.580.8800 713.580.8888 Fax

## Central Campus Parking Lot Improvements

1300 Holman Street Houston, TX 77004

Contract No.:
Drawn By: XX
Checked By:
Approved By:

A/E Project No.:

Date: XX/XX/XX

Date:


Date:

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Architectural Lighting Plan

Scale: 1" = 20'-0"



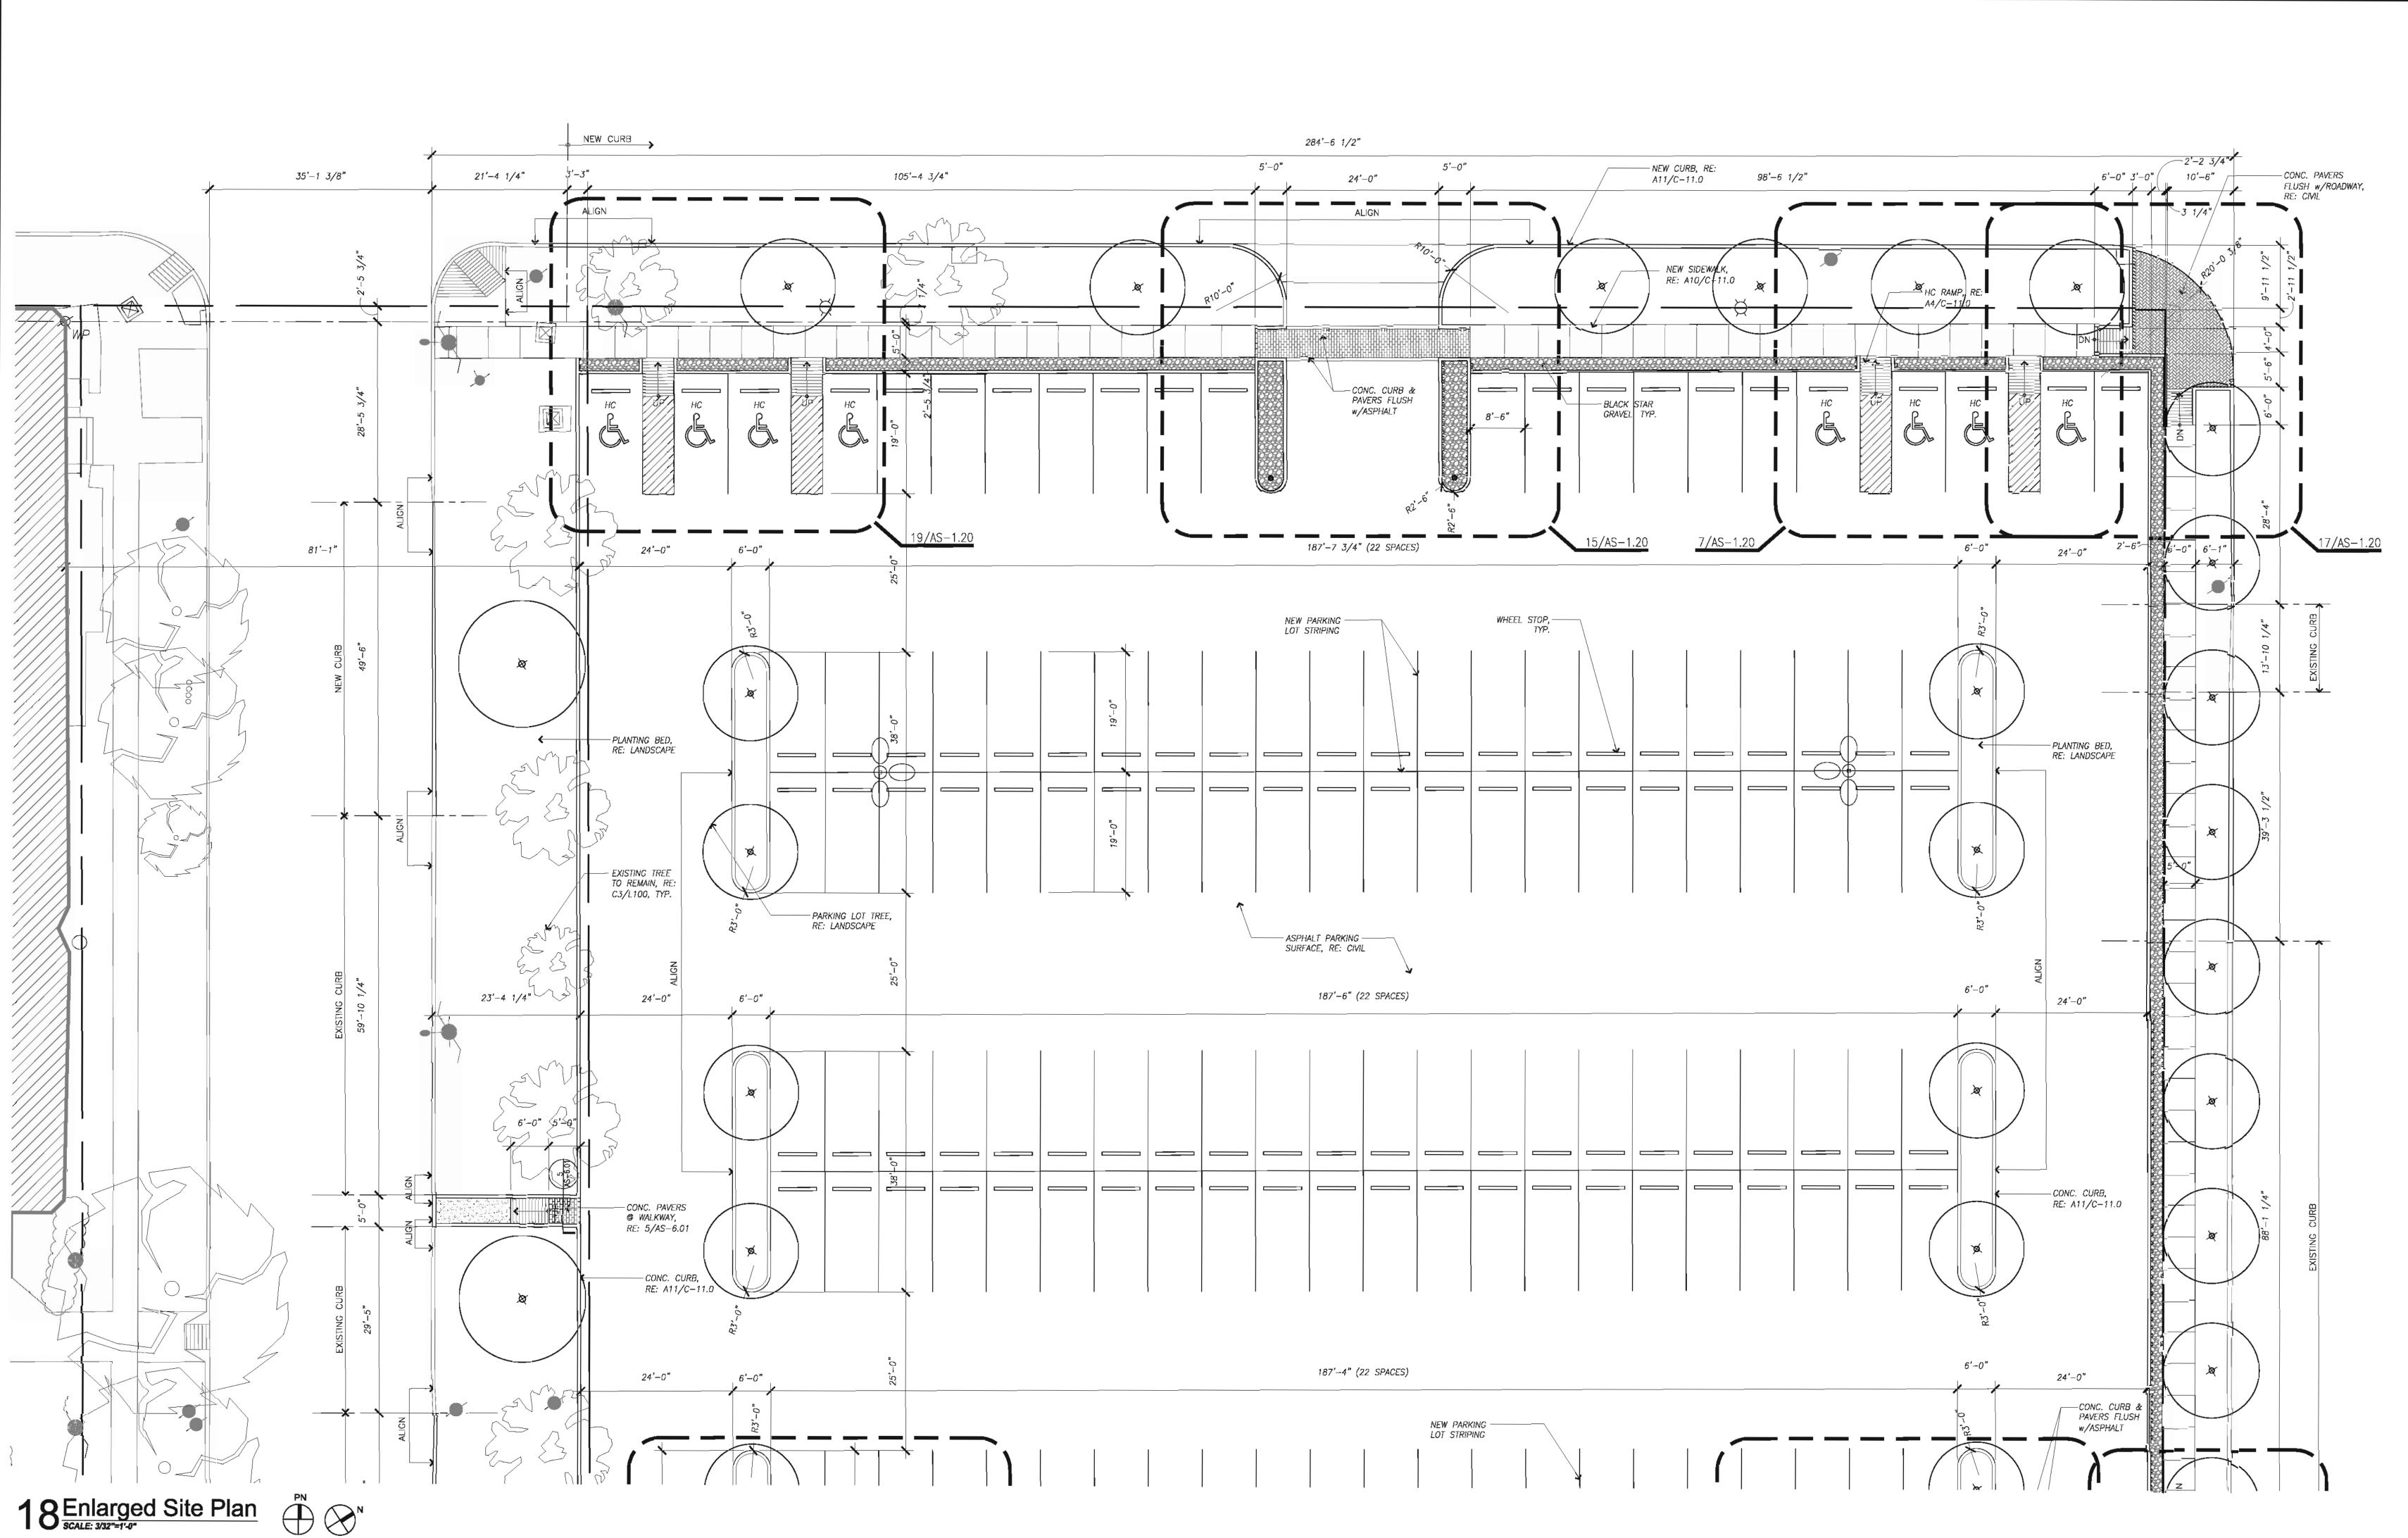

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> STUDIO OF RICHARD JETER MFA LIGHTING DESIGNER 15903 PEBBLE BEND DR HOUSTON, TEXAS 77068



Central Campus
Parking Lot Improvements

1300 Holman Street Houston, TX 77004

Contract No.:

Drawn By: XX

Checked By:

Date: XX/XX/XX

Date: Approved By:

Date: Date:


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Enlarged Site Plan

Scale: 3/32" = 1'-0"

AS-1 04



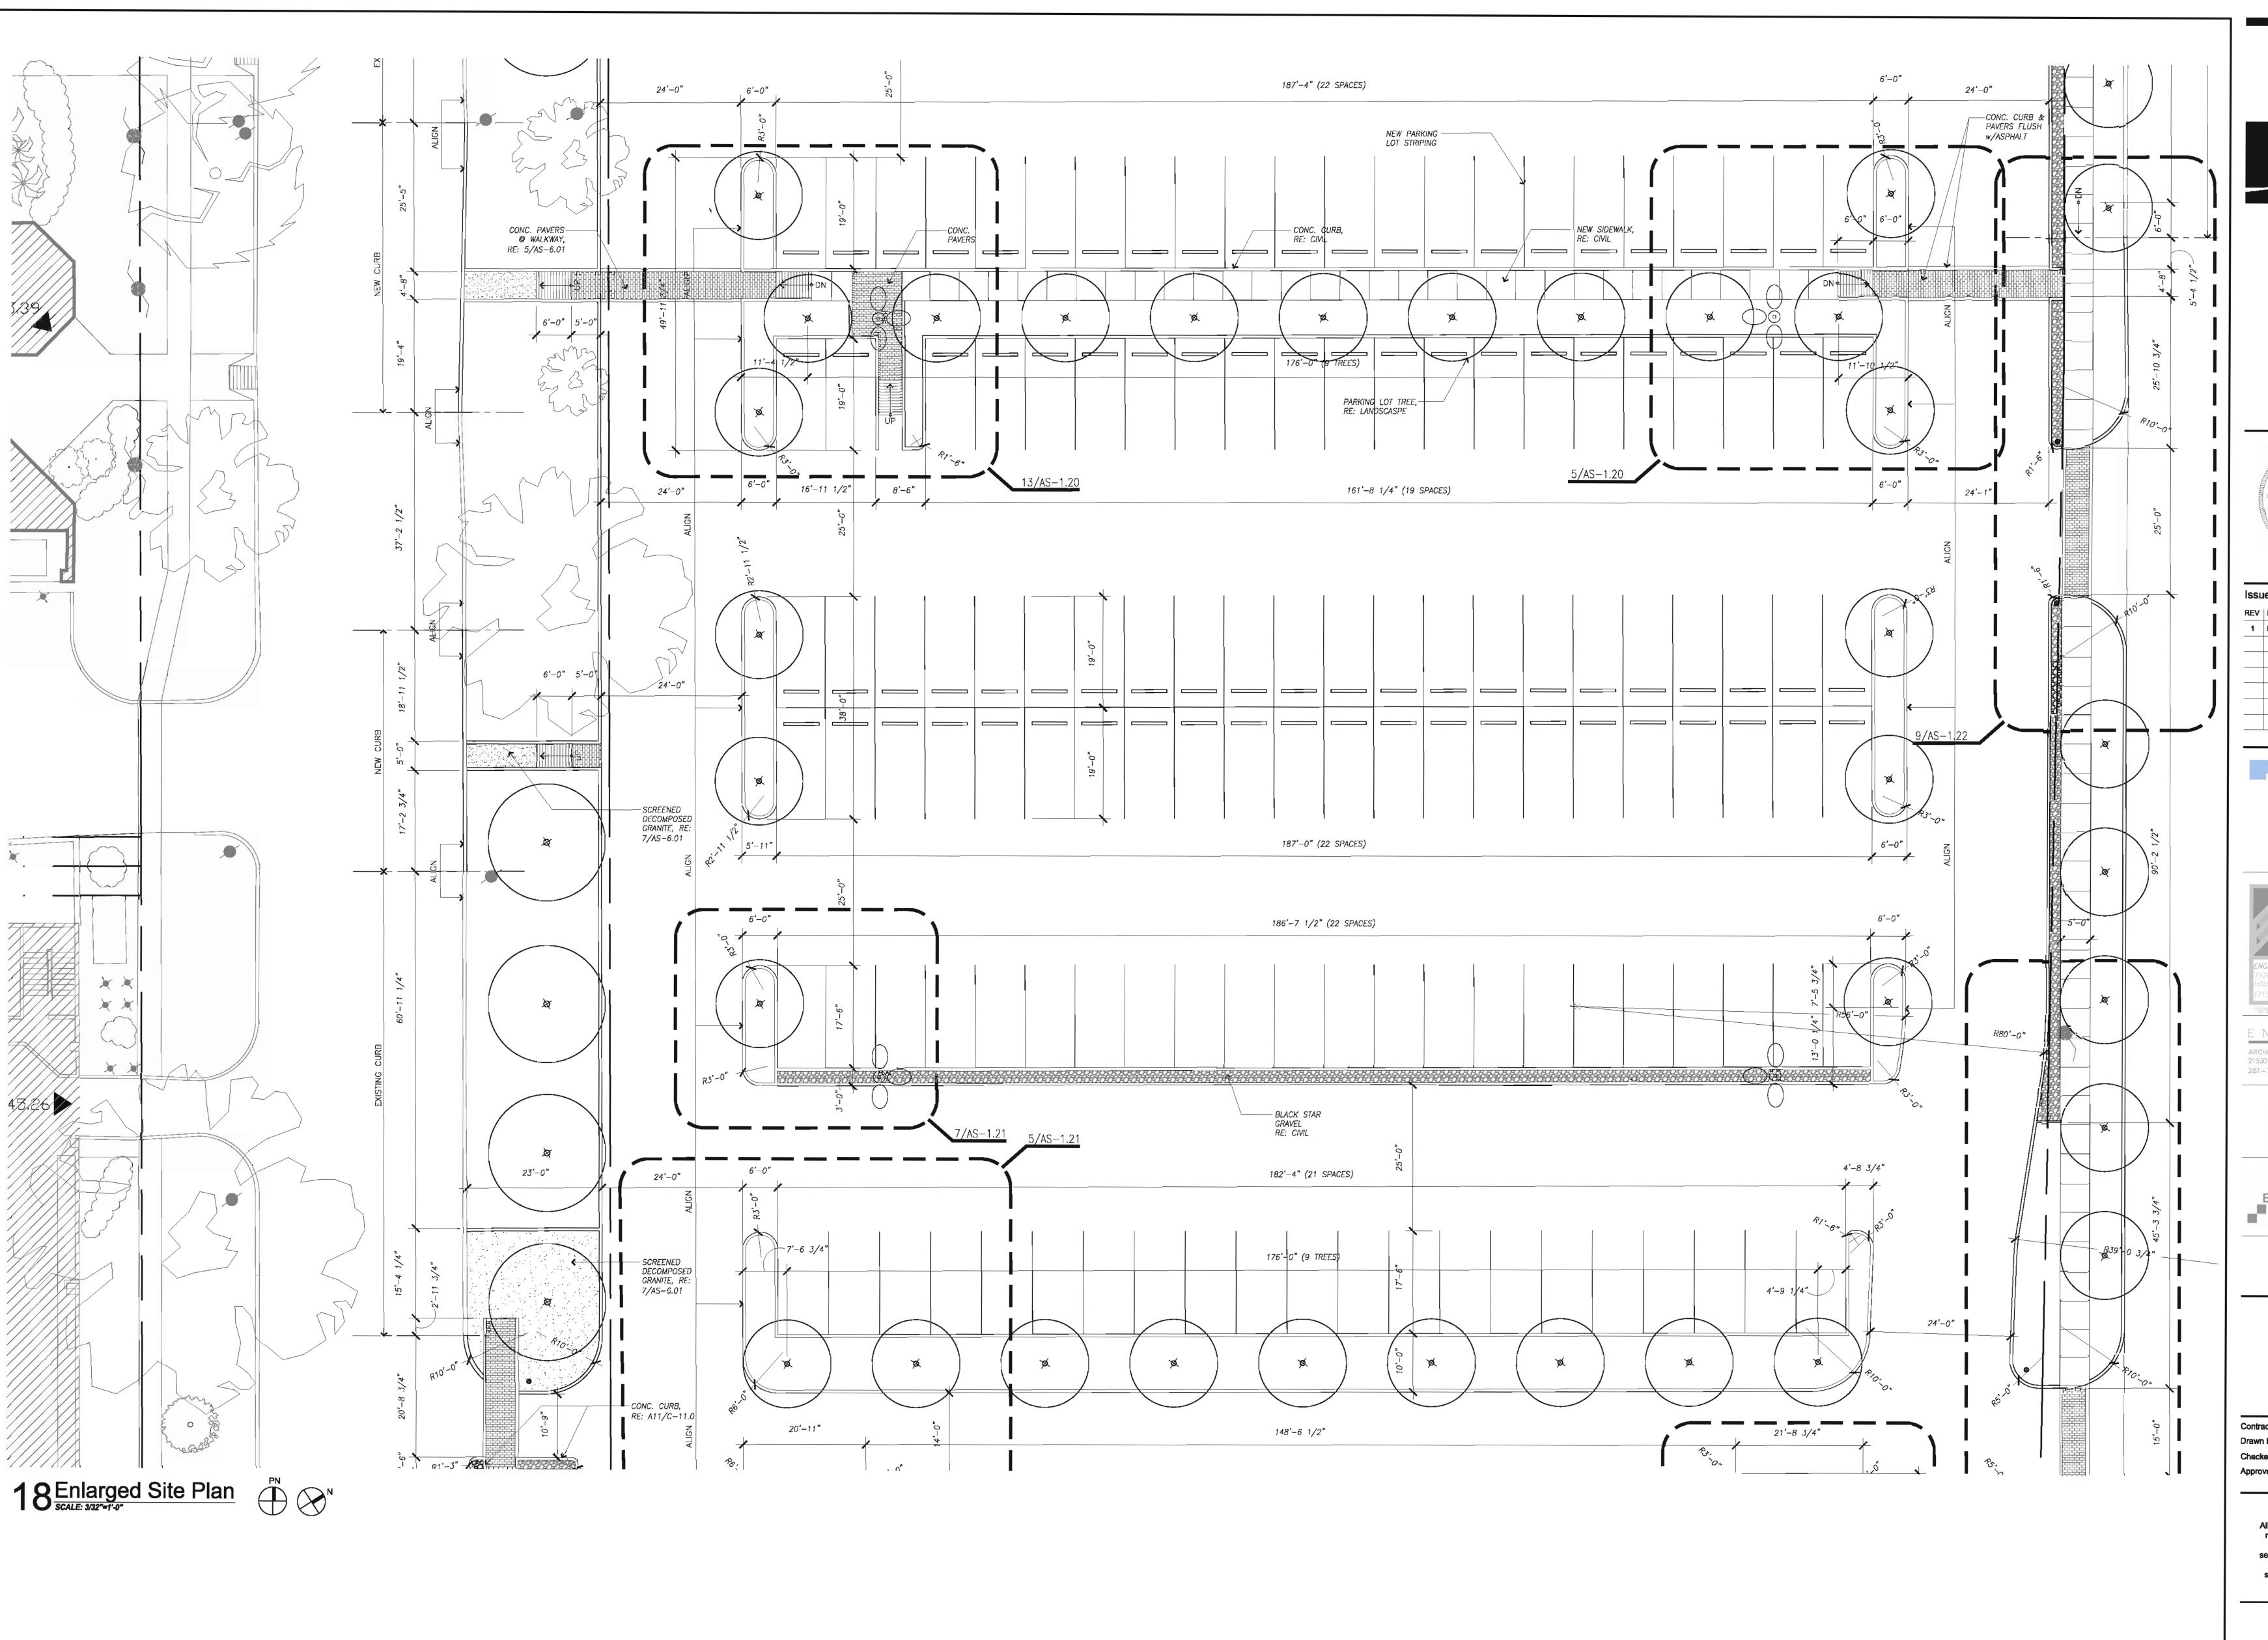

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> STUDIO OF RICHARD JETER MFA LIGHTING DESIGNER 15903 PEBBLE BEND DR. HOUSTON, TEXAS 17068



Central Campus
Parking Lot Improvements

1300 Holman Street Houston, TX 77004

Contract No.:

Drawn By: XX

Checked By:

A/E Project No.:


Date: XX/XX/XX

Date:

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Enlarged Site Plan

Scale: 3/32" = 1'-0"



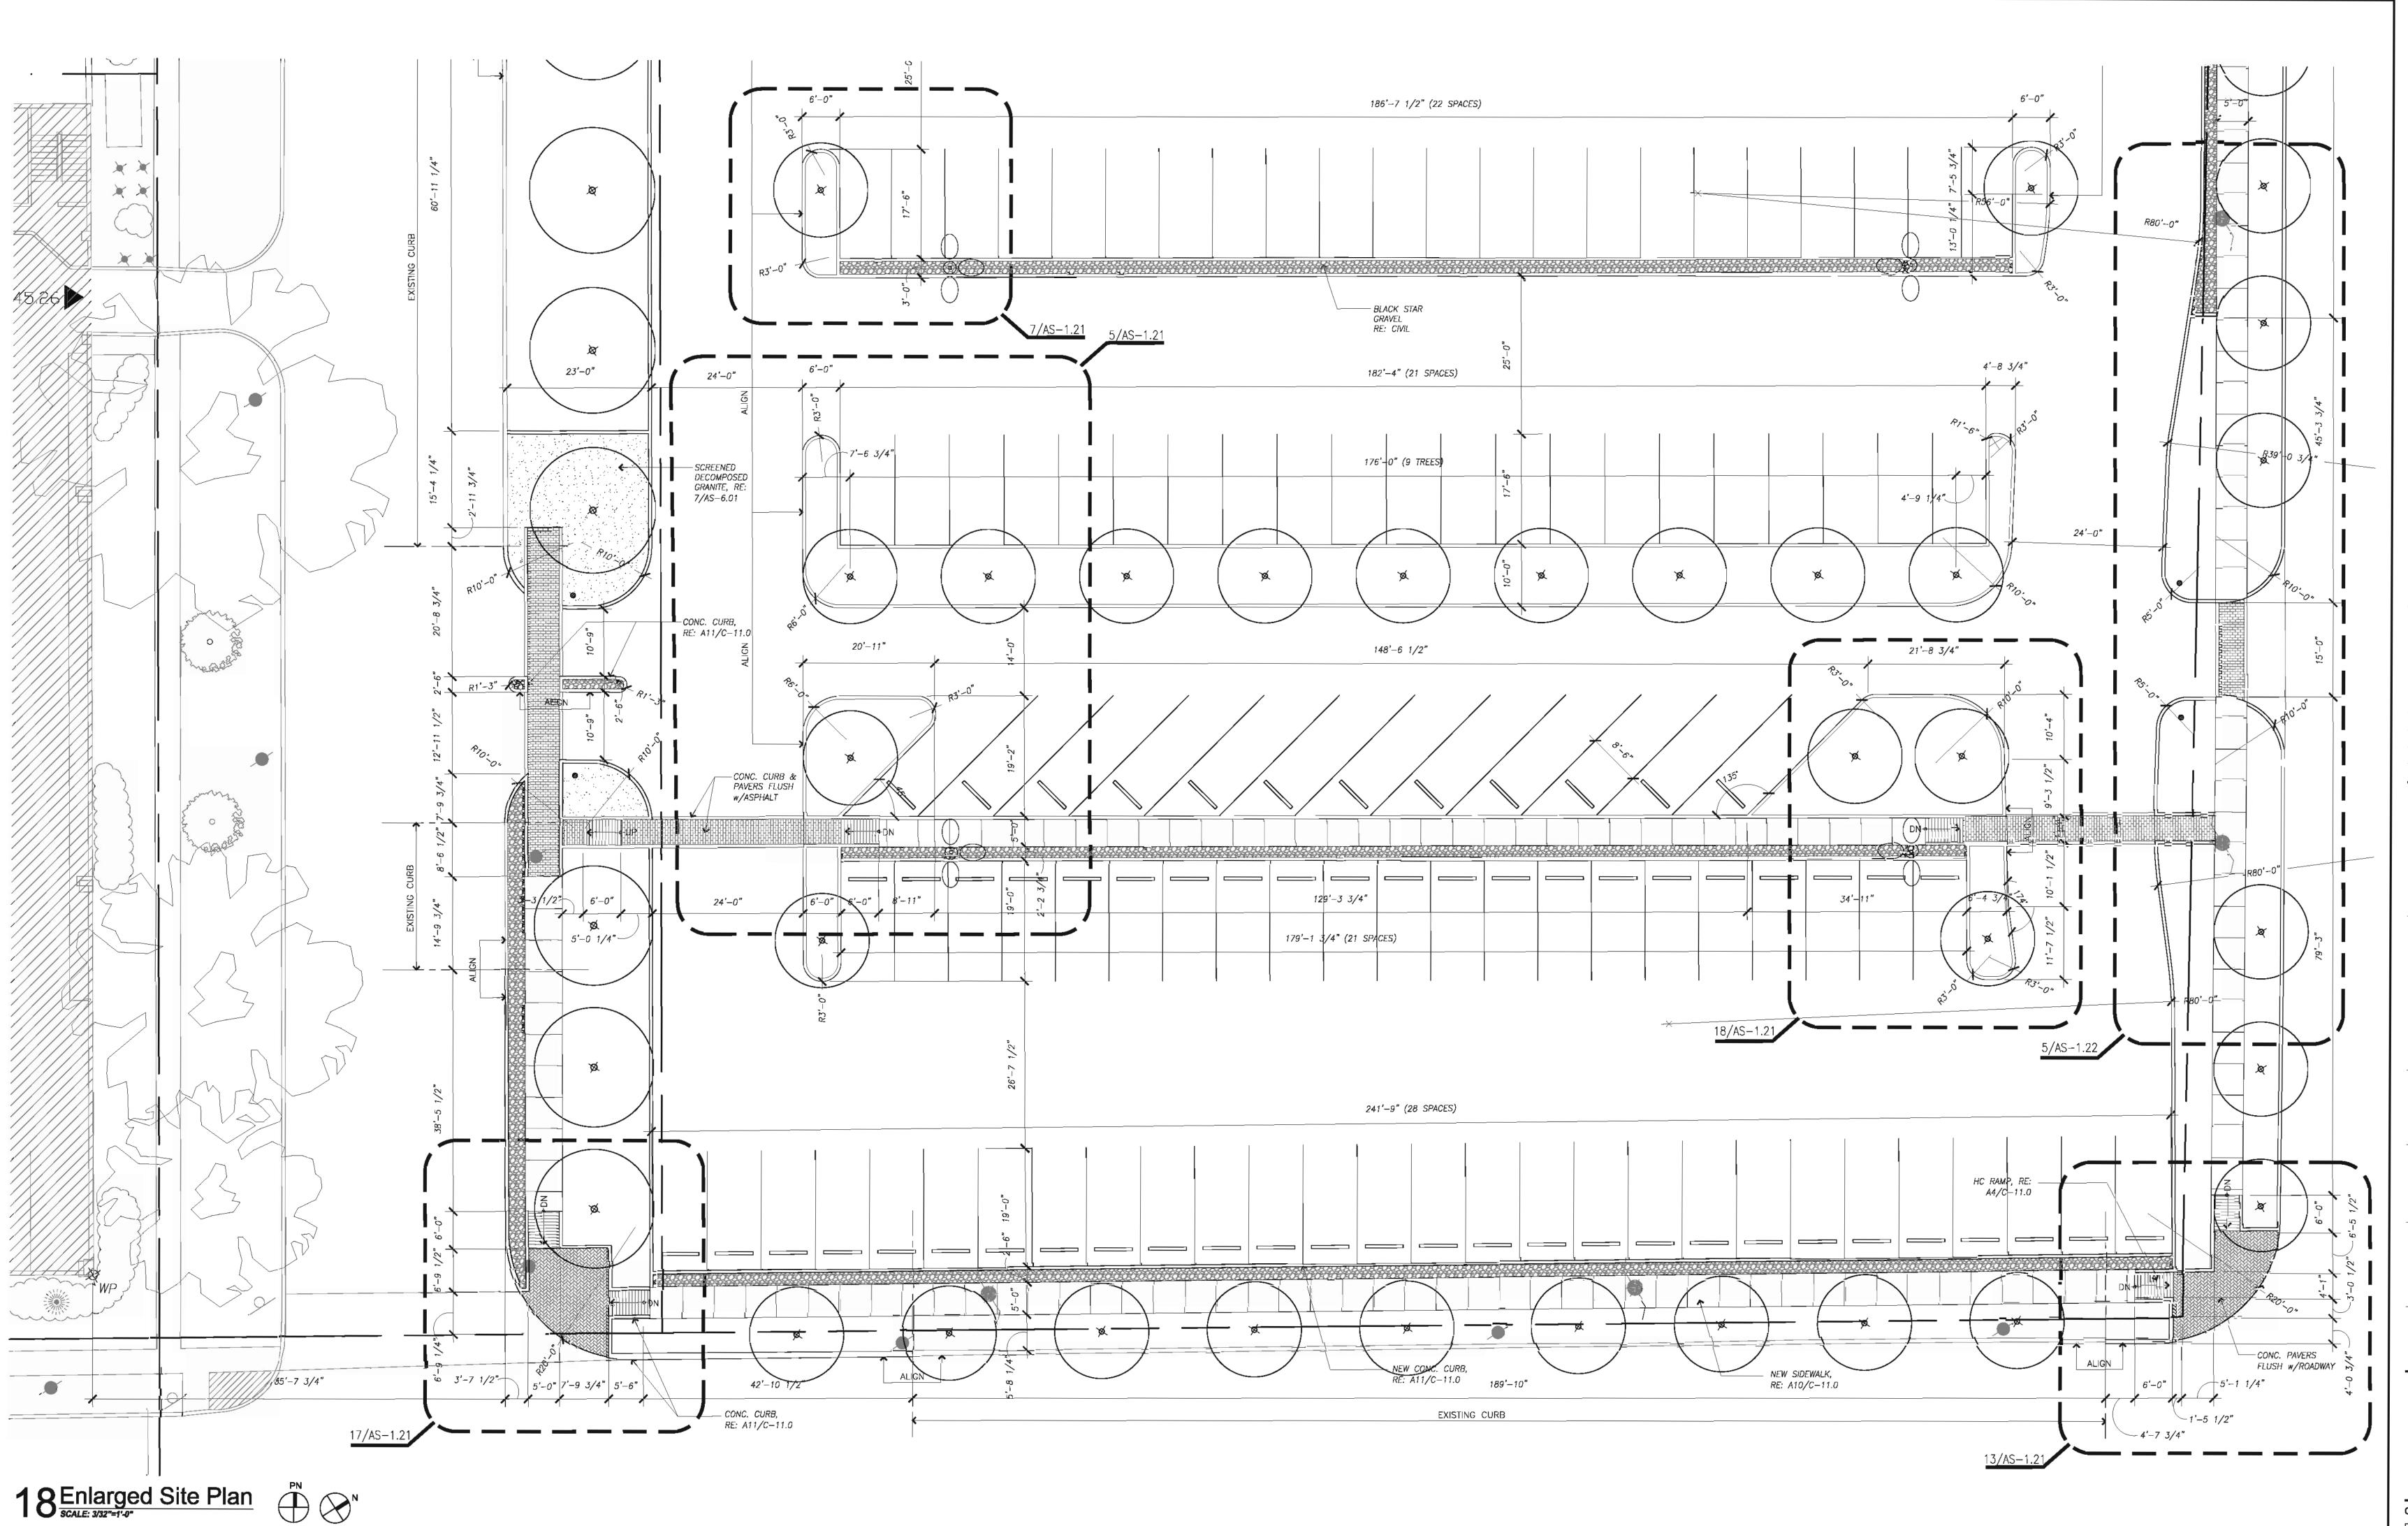


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DESCRIPTION	DATE	
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	DESCRIPTION	DESCRIPTION DATE

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E&C Engineers & Consultants Inc. 1010 Lamar, #650 Houston, Texas 77002 713.580.8800 713.580.8888 Fax

Central Campus
Parking Lot Improvements

1300 Holman Street Houston, TX 77004

Contract No.:

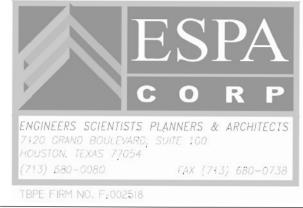Drawn By: XX

Checked By:

Approved By:

Date: Date:


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Date: XX/XX/XX

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Enlarged Site Plan

Scale: 3/32" = 1'-0"



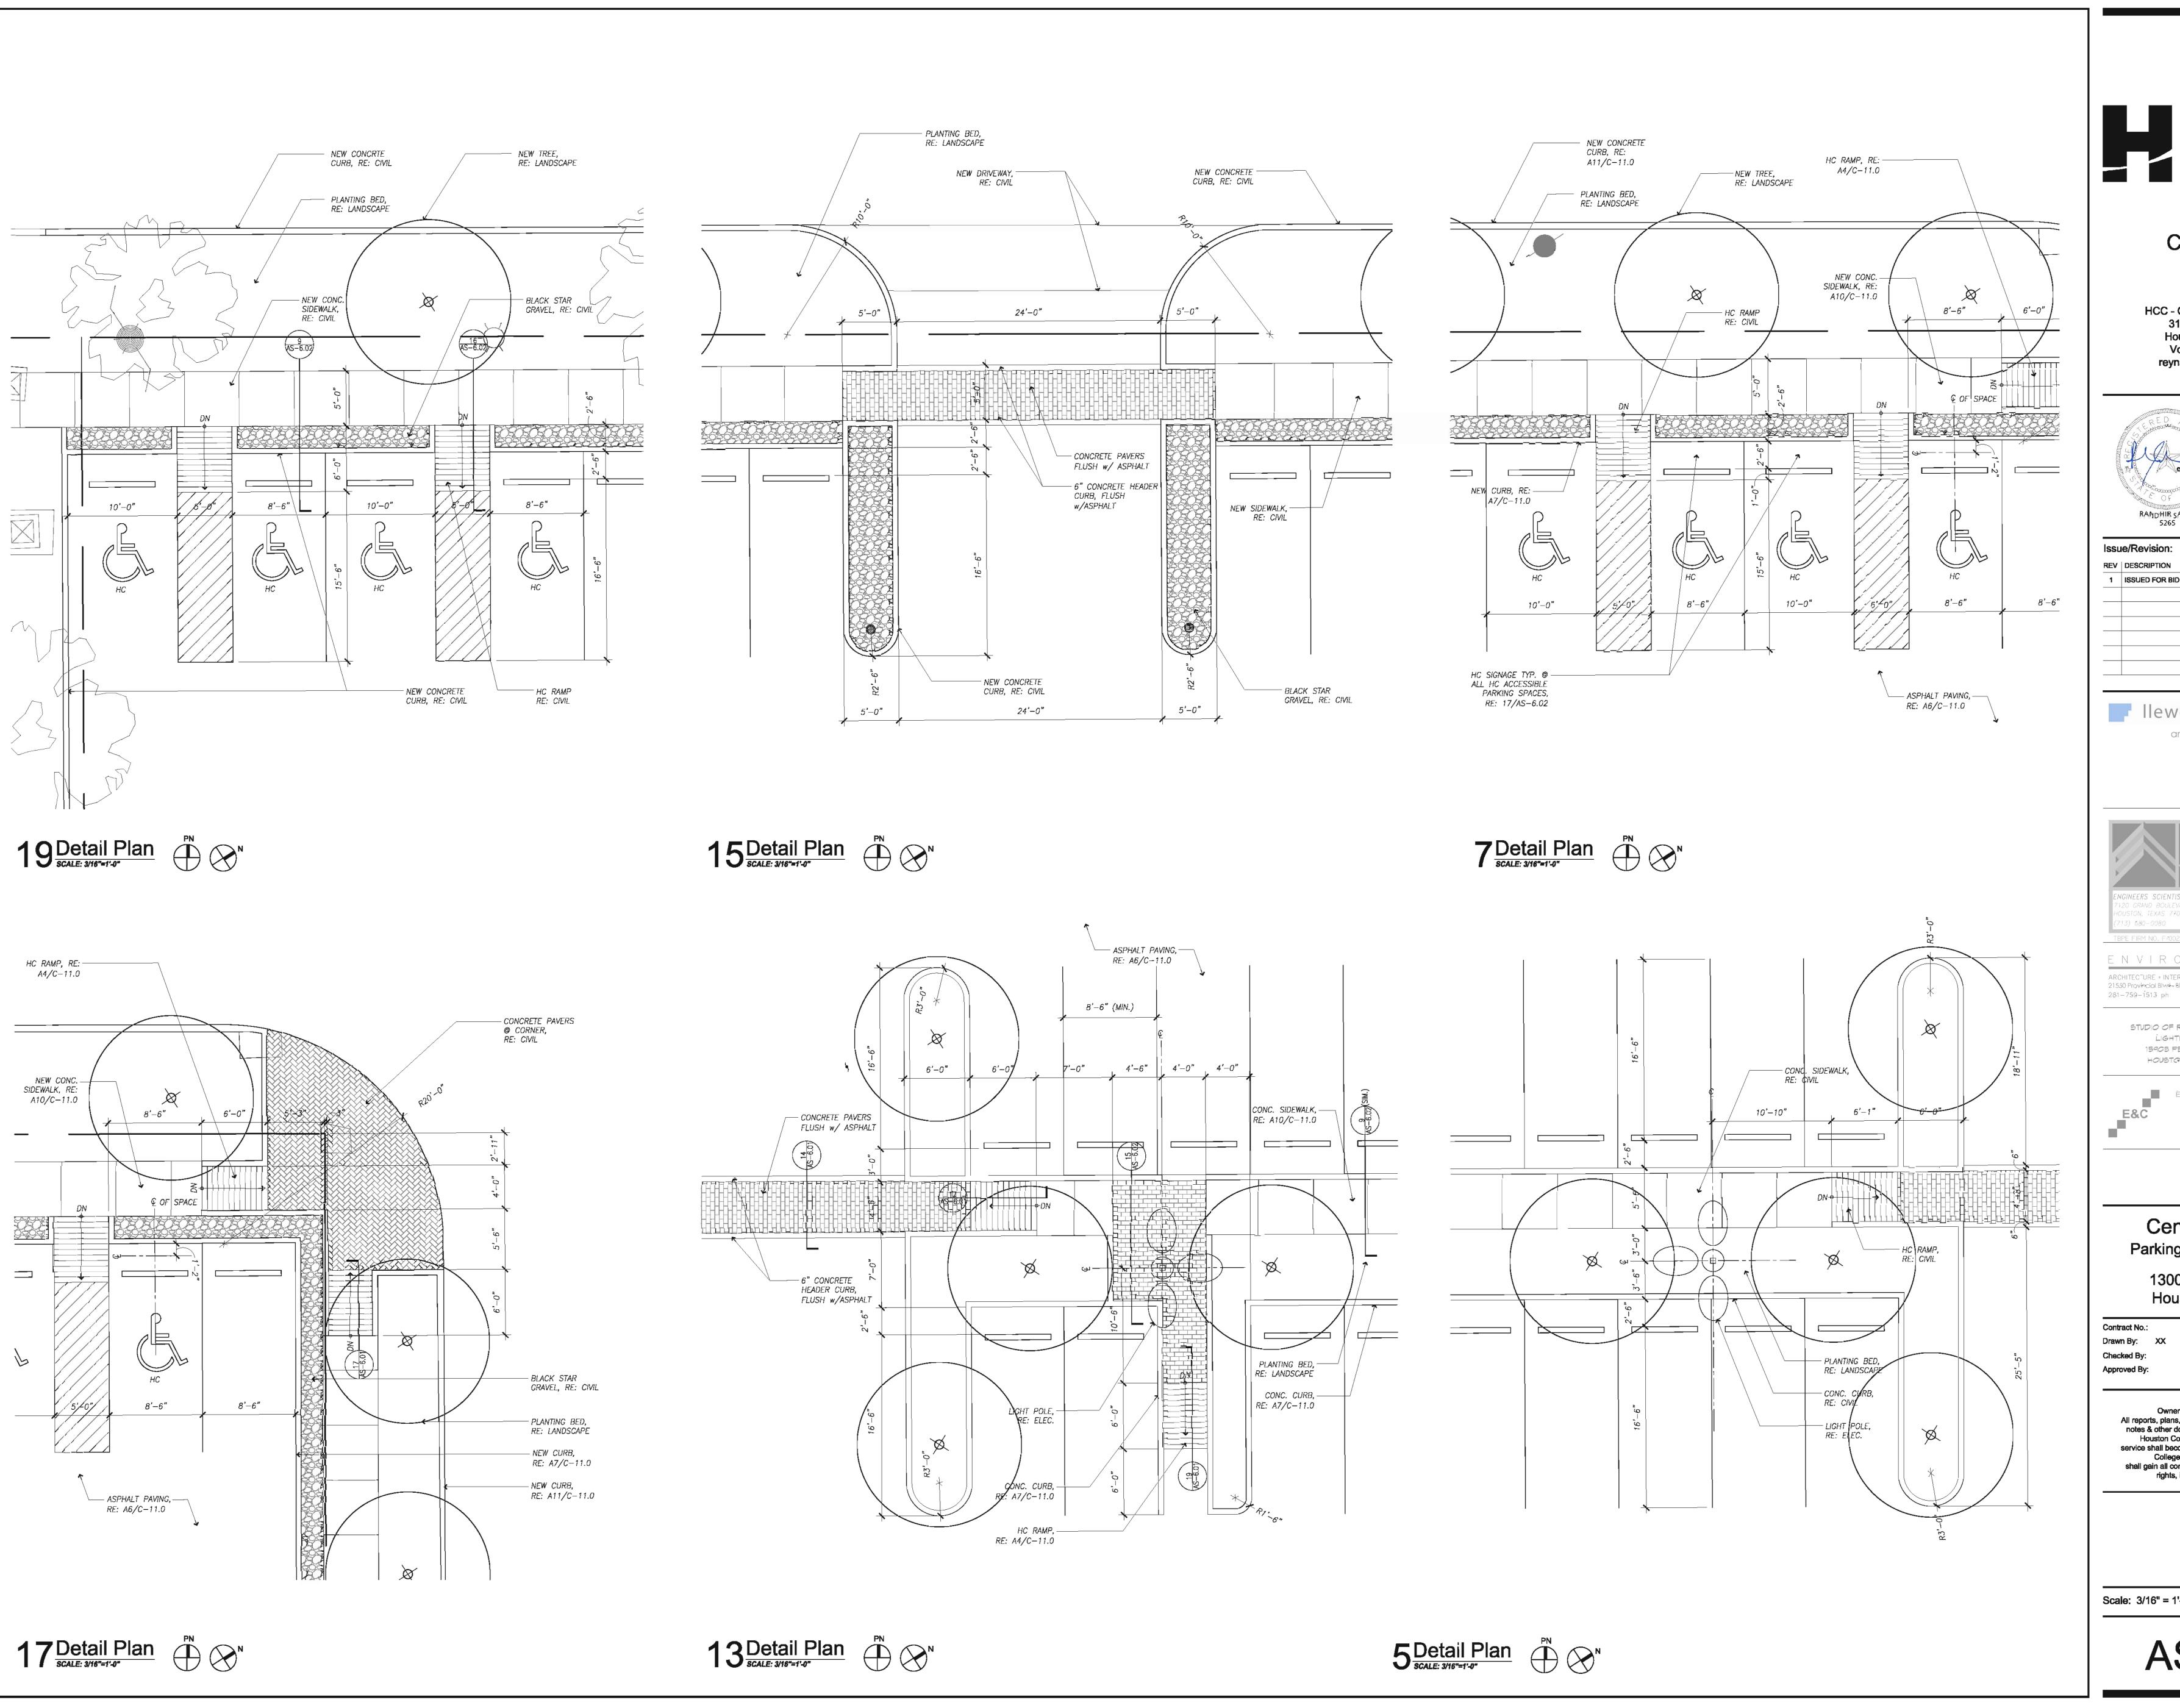

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CORF ENGINEERS SCIENTISTS PLANNERS & ARCHITE IOUSTON, TEXAS 77054

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E&C Engineers & Consultants Inc. 1010 Lamar, #650 Houston, Texas 77002 713.580.8800 713.580.8888 Fax

Central Campus Parking Lot Improvements


1300 Holman Street Houston, TX 77004

A/E Project No.: Contract No.: Date: XX/XX/XX Drawn By: XX Checked By:

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> Detail **Plans**

Scale: 3/16" = 1'-0"



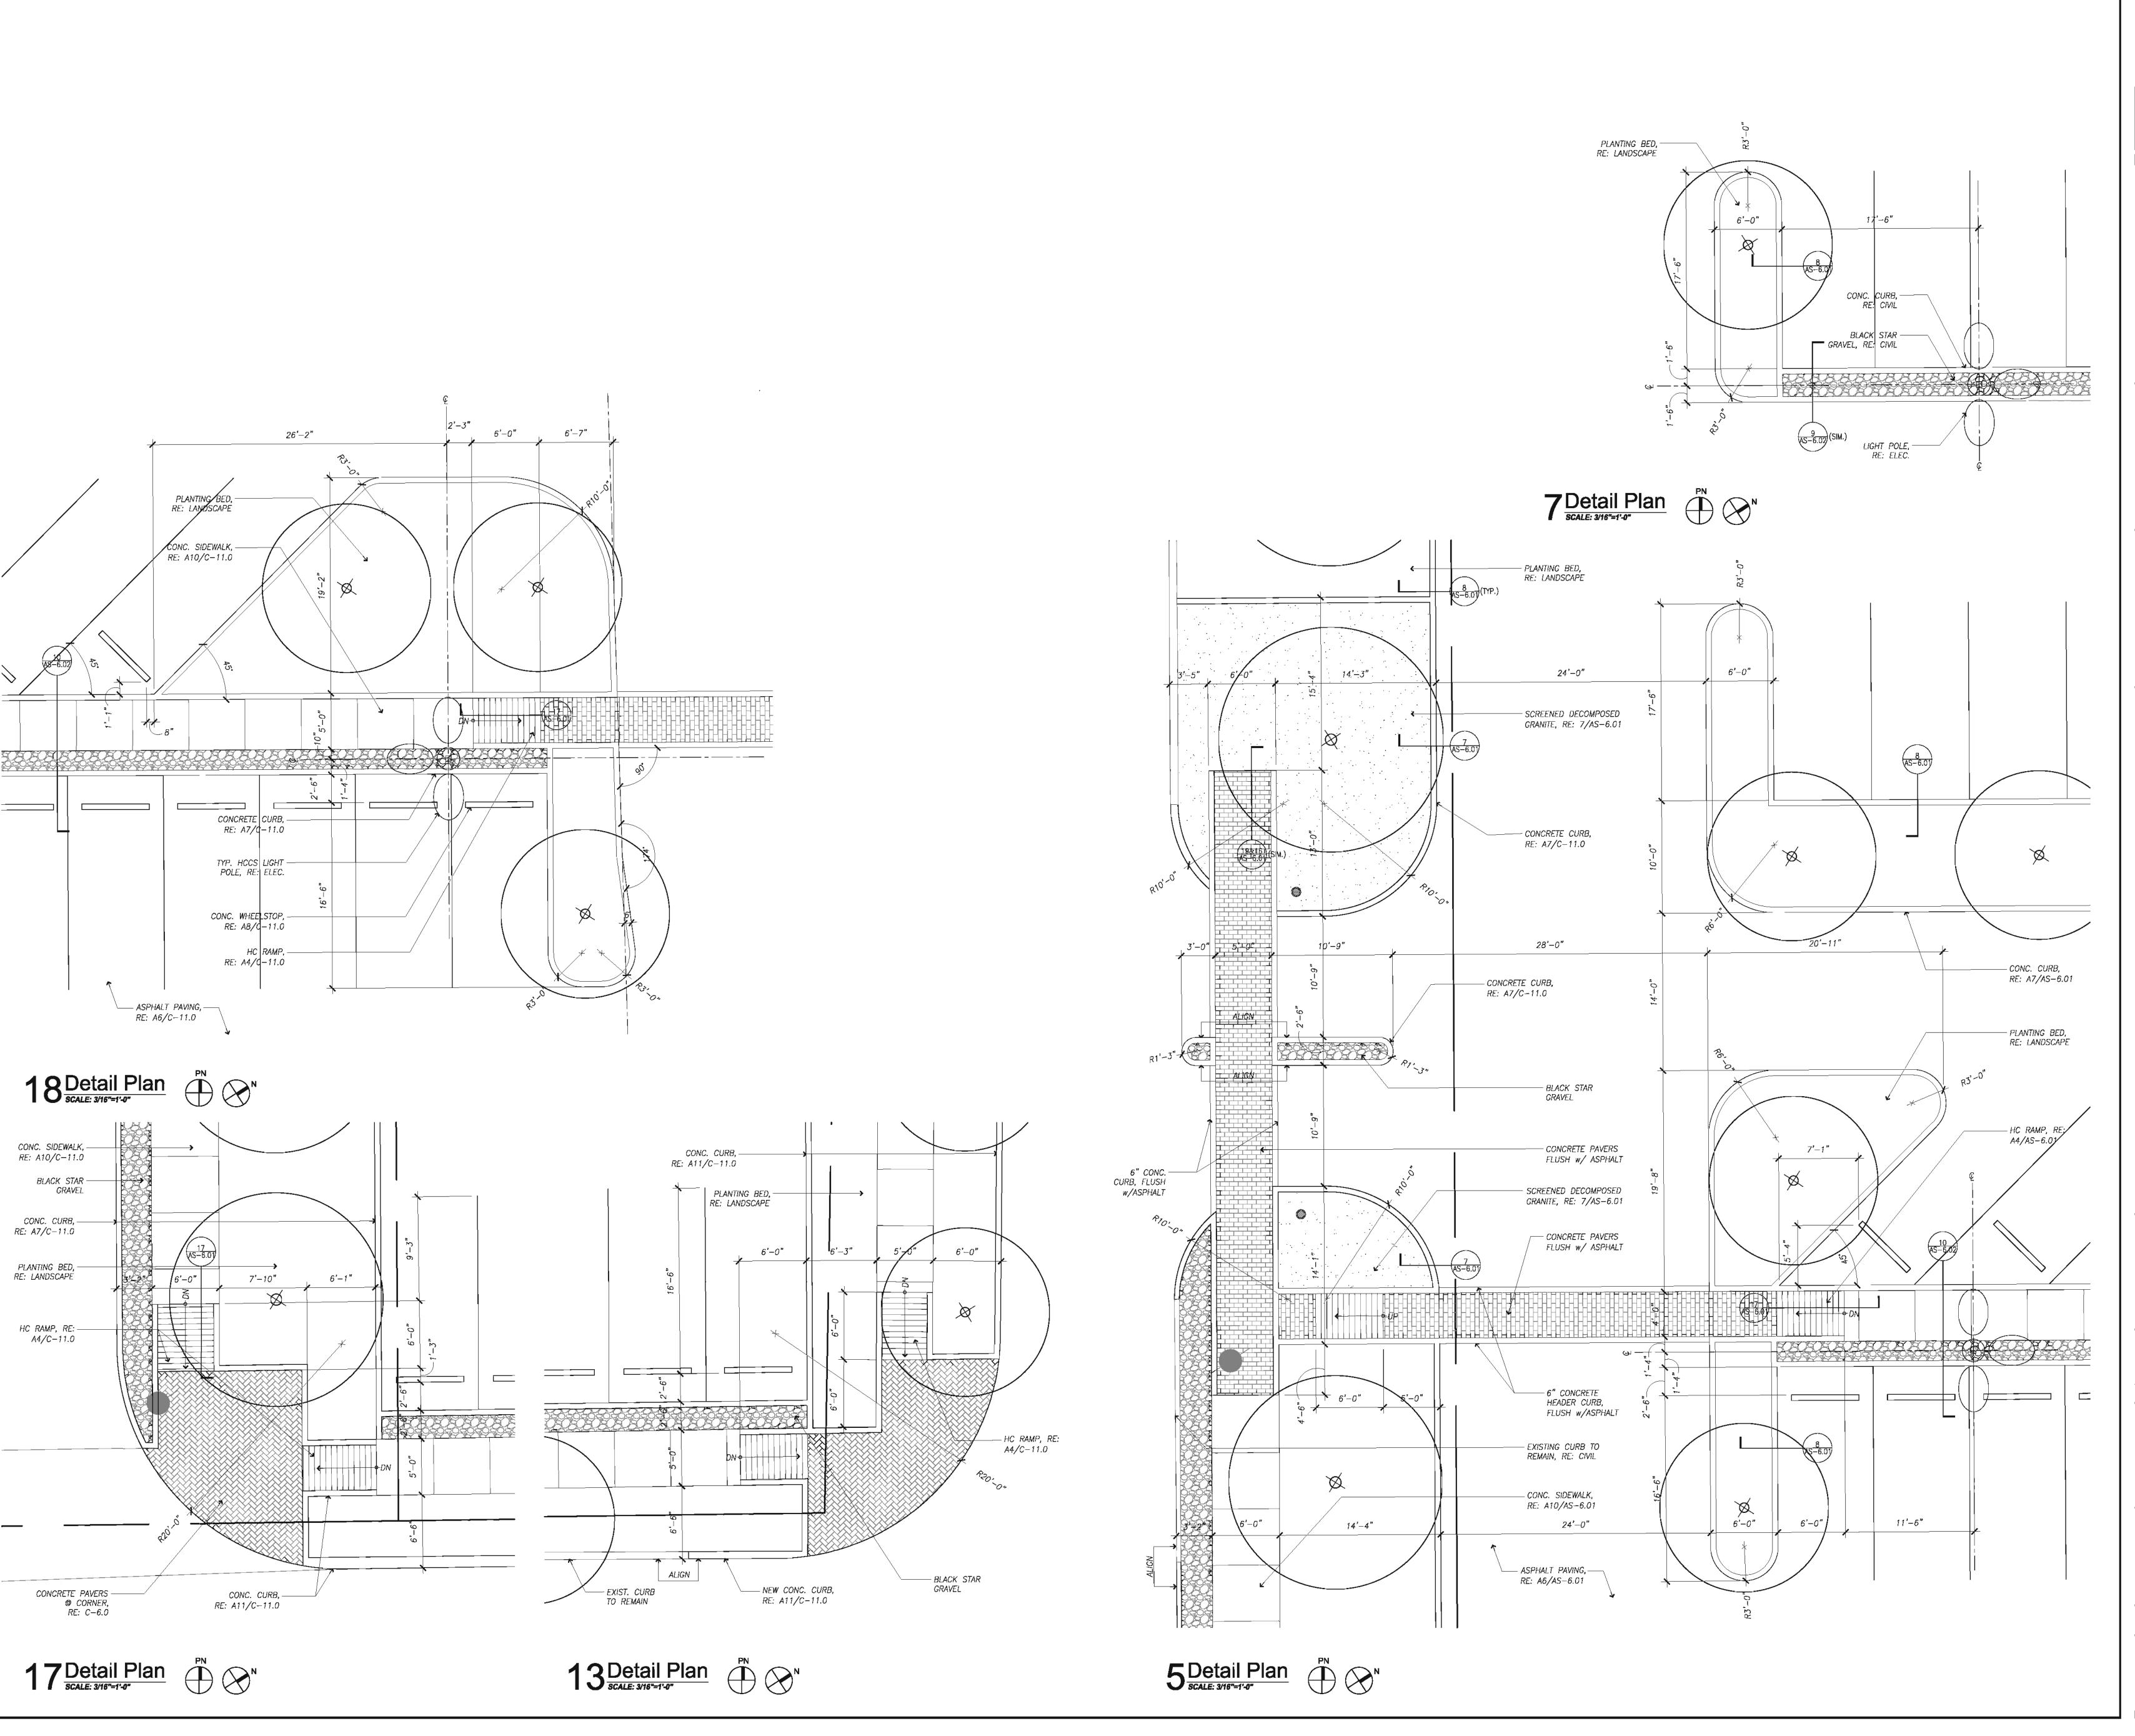

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# RANDHIR SAHNI 5265 ISSUE/Revision: REV DESCRIPTION DATE 1 ISSUED FOR BID & CONSTRUCTION 05/09/11

### Ilewelyn-davies sahni

architecture + planning + design

5120 Woodway, Suite 8010
Houston, TX 77056
p: 713.850.1500
f: 713.850.1023
e: info@theldnet.com



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STUDIO OF RICHARD JETER MFA LIGHTING DESIGNER 15903 PEBBLE BEND DR. HOUSTON, TEXAS T1068



# Central Campus Parking Lot Improvements

1300 Holman Street Houston, TX 77004


Contract No.:	A/E Project No.:
Drawn By: XX	Date: XX/XX/XX
Checked By:	Date:

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Detail Plans

Scale: 3/16" = 1'-0"



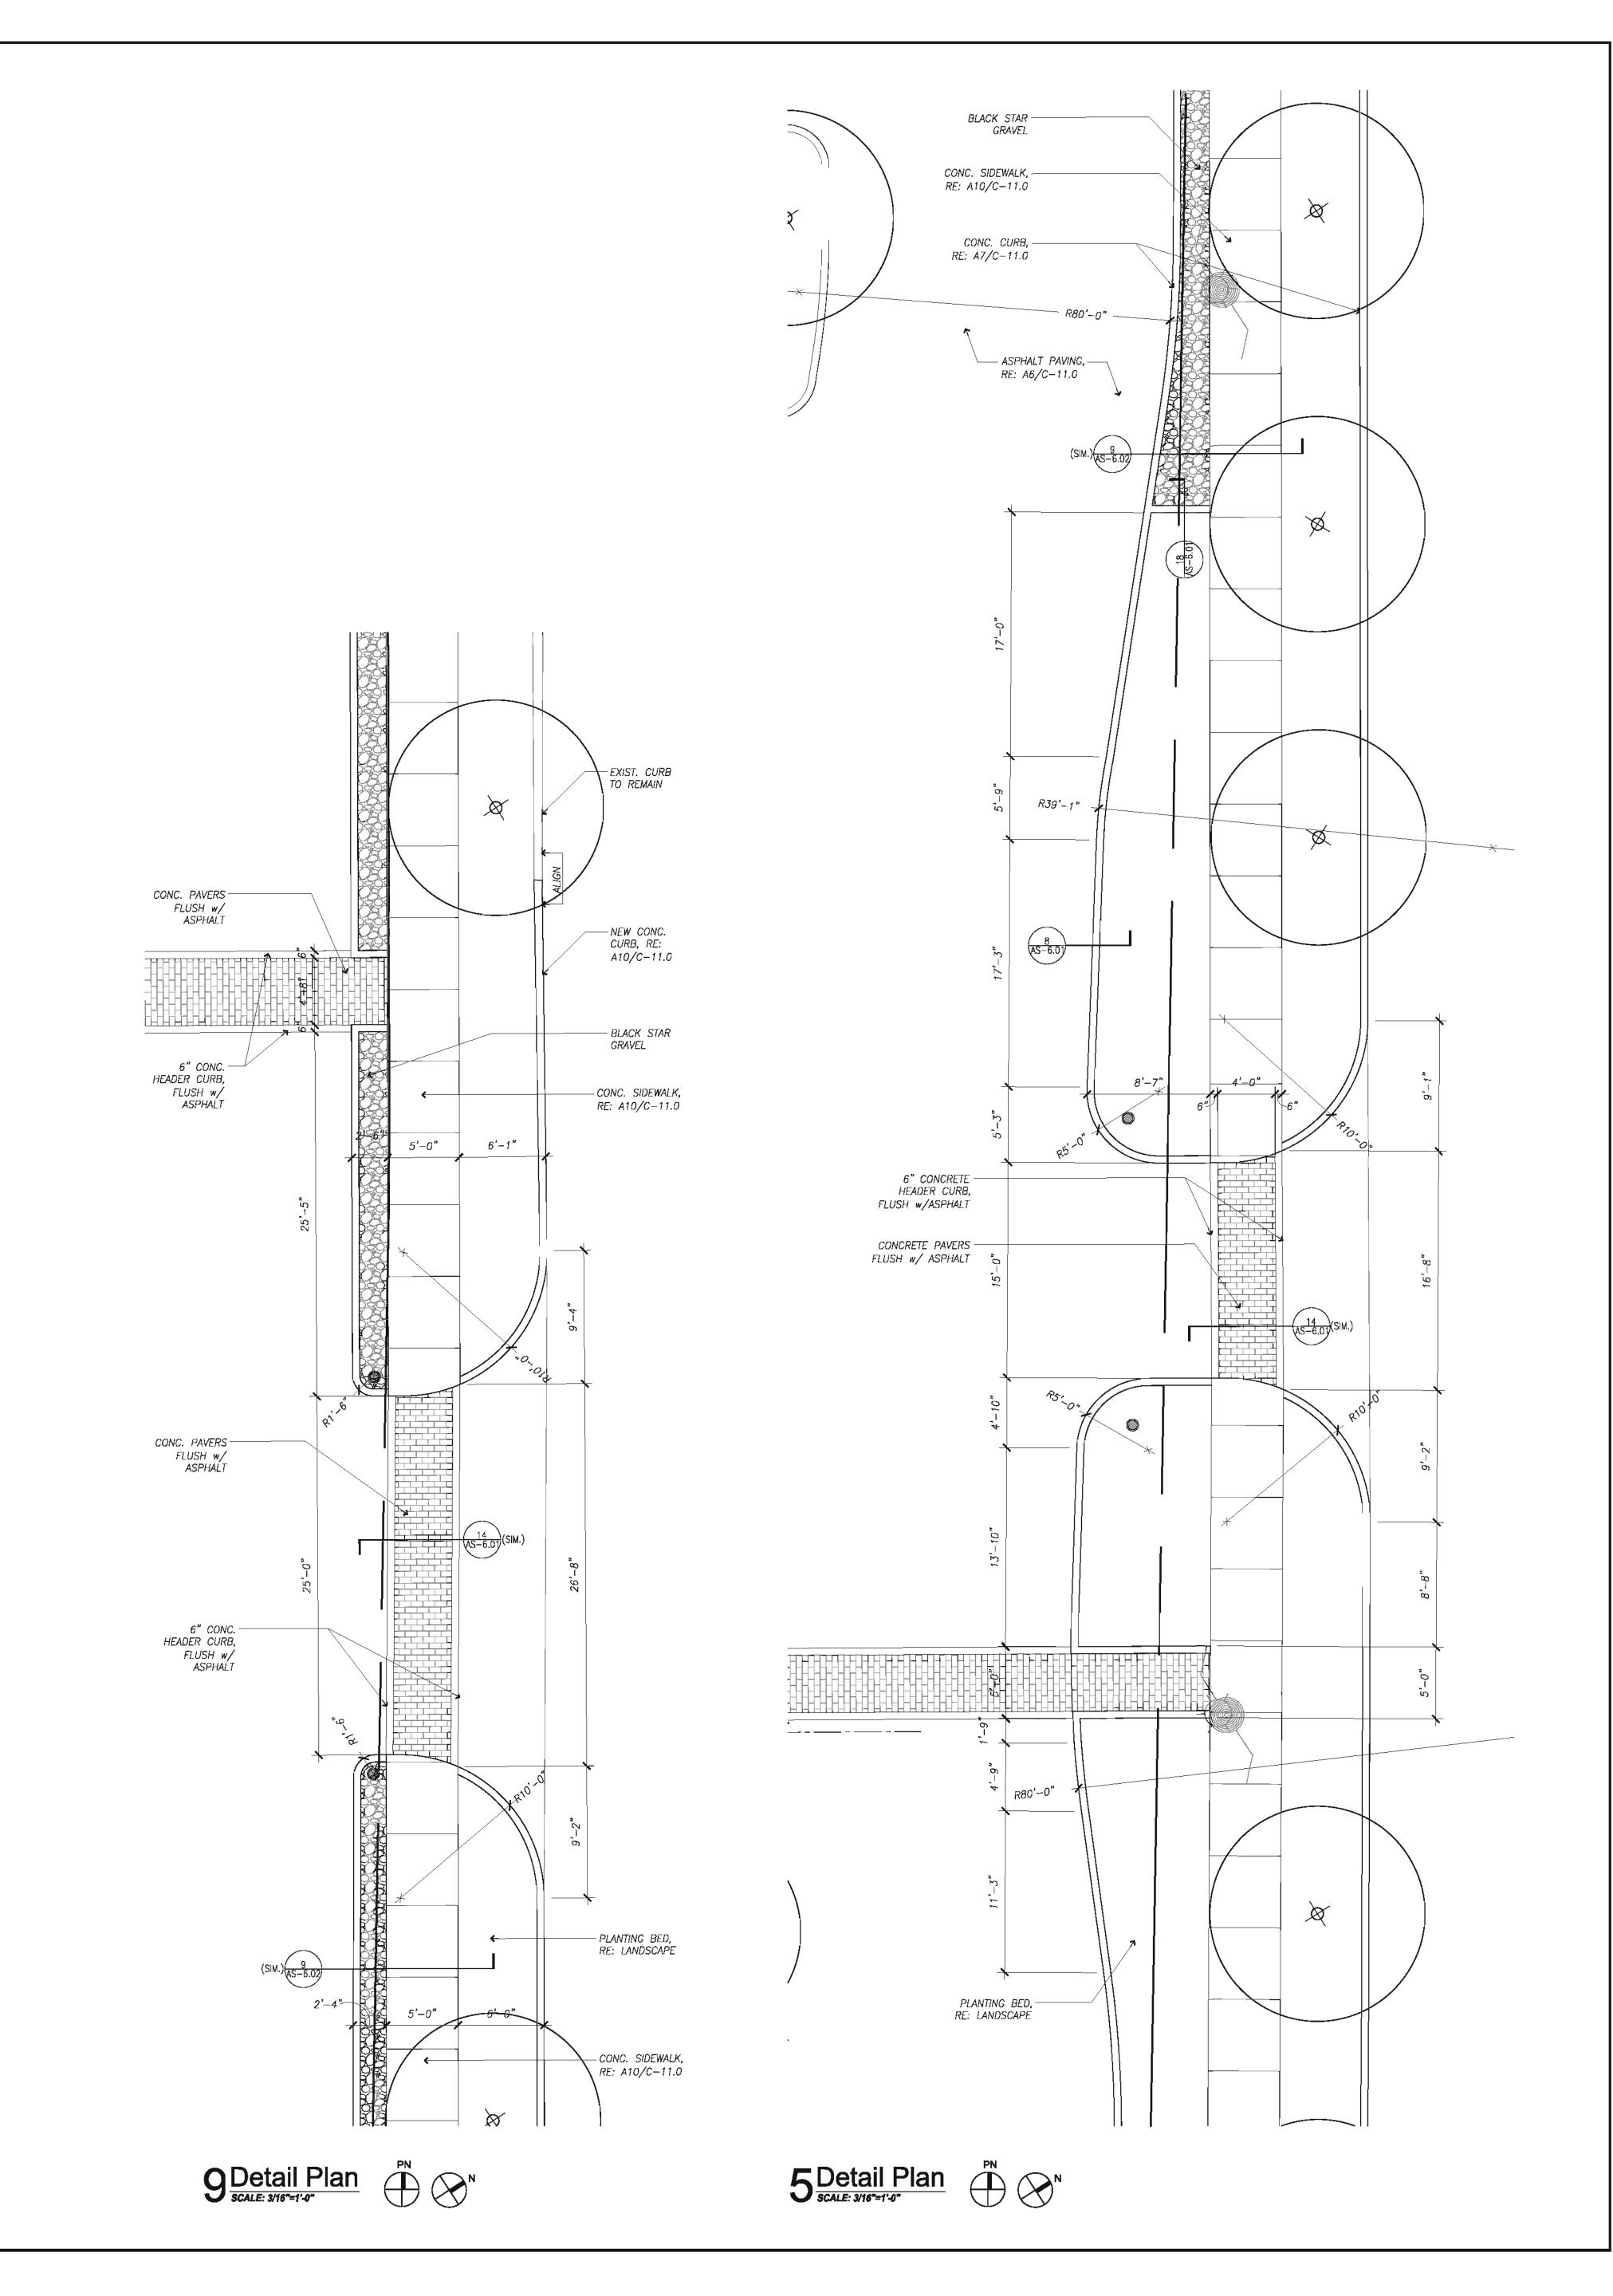

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Houston, TX 77056
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f: 713.850.1023
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STUDIO OF RICHARD JETER MFA LIGHTING DESIGNER 15903 PEBBLE BEND DR. HOUSTON, TEXAS 17063



# Central Campus Parking Lot Improvements

1300 Holman Street Houston, TX 77004

Contract No.:

Drawn By: XX

Date: XX/XX/XX


Drawn By: XX I
Checked By: I
Approved By: I

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Detail Plans

Scale: 3/16" = 1'-0"



18 Proposed Site Plan PN SCALE: 1"=30'-0"
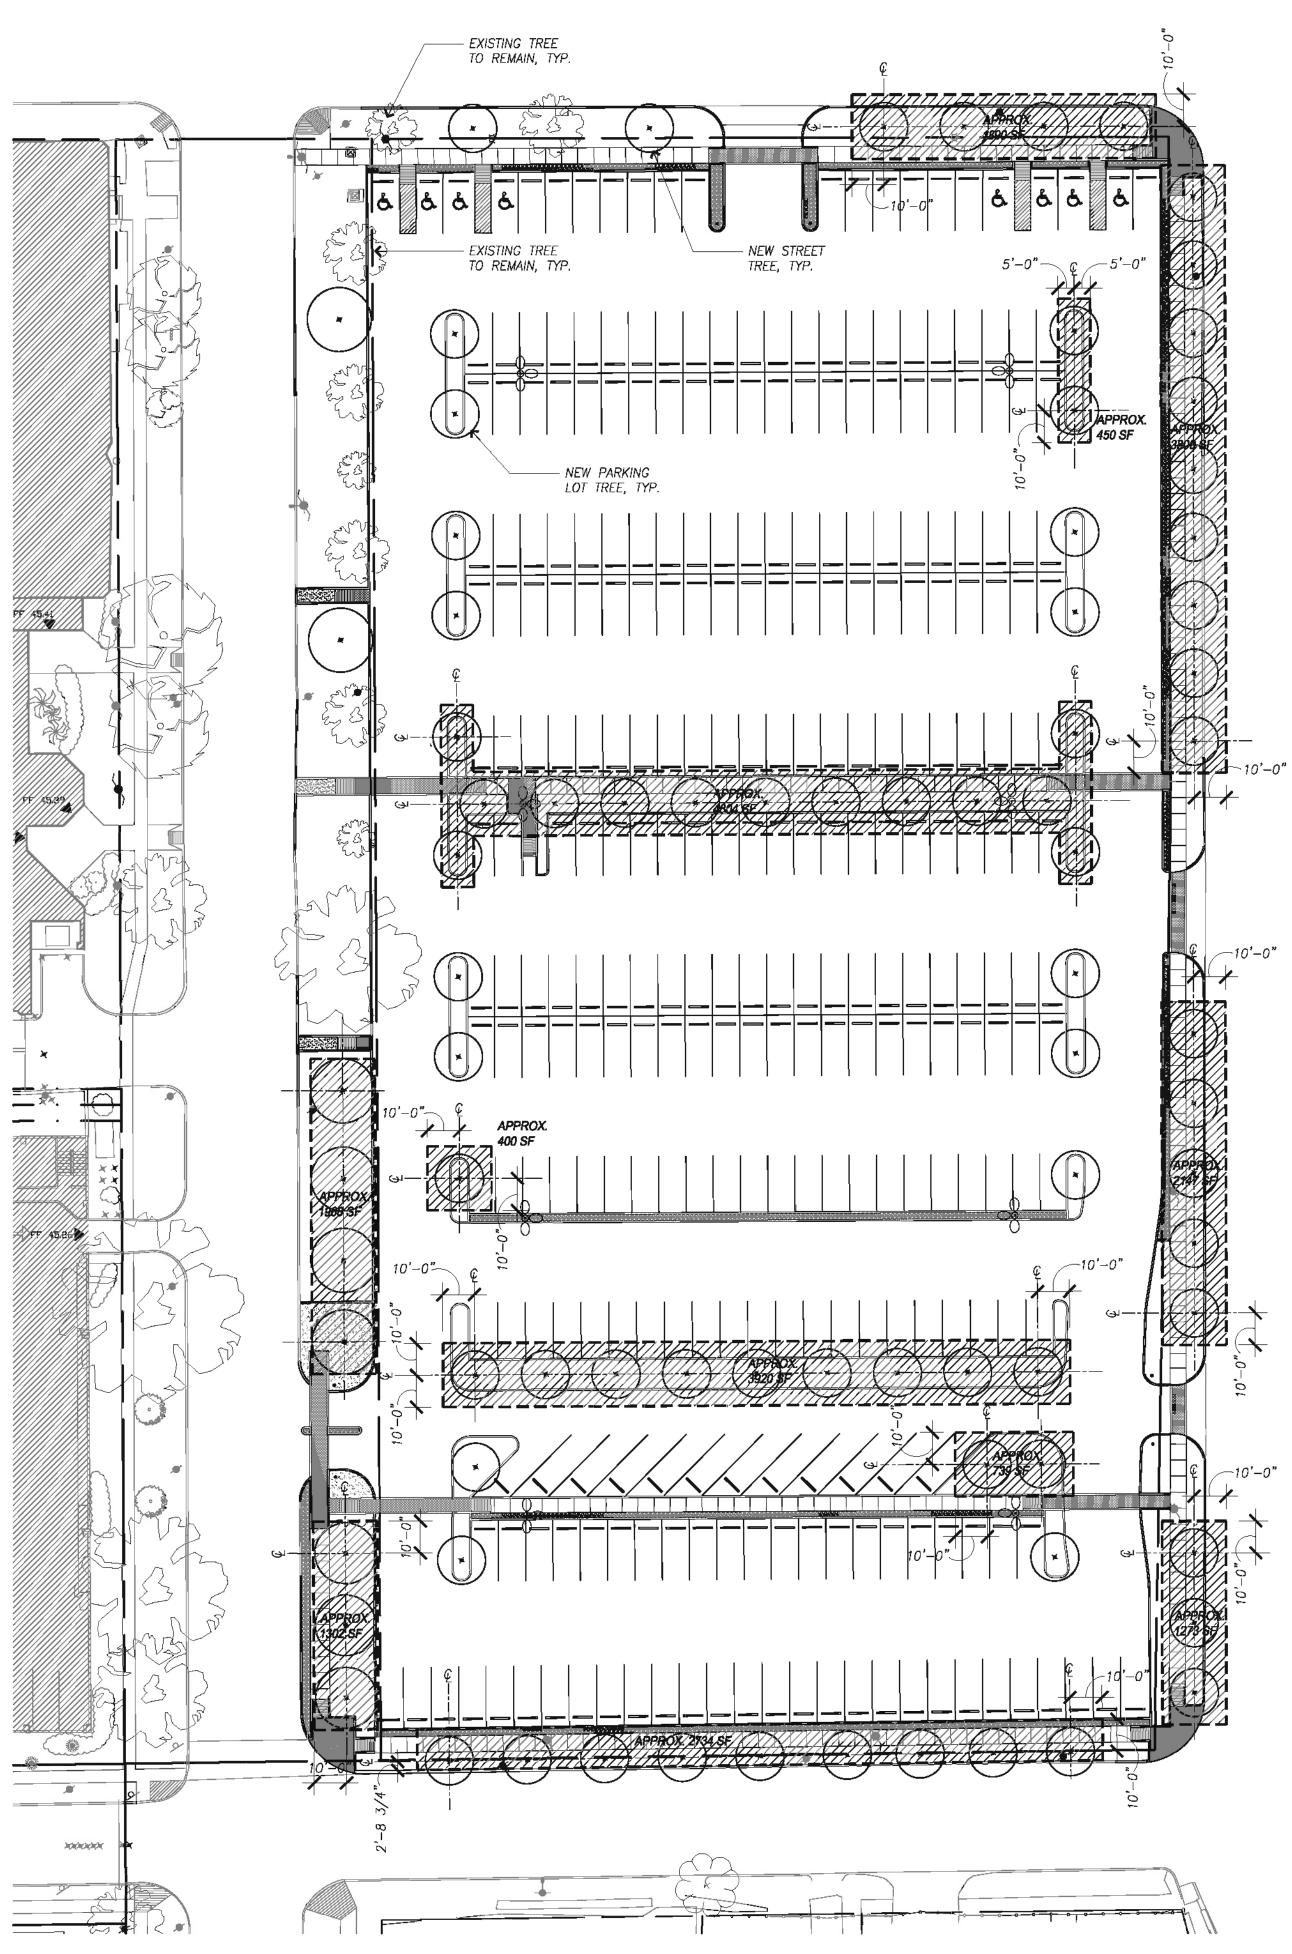
<u>GENERAL NOTES:</u>

CONTRACTOR TO NOTIFY ARCHITECT OF ANY DIMENSIONAL DISCREPANCY FOUND IN FIELD THAT CONTRADICTS WHAT IS IN THE DOCUMENTS.
 ALL WORK RELATED TO EXISTING SOILS MUST FOLLOW HEALTH & SAFETY REPORT

3. FOR SHADED AREAS ON DRAWING 10/AS-6.00, SEE TREE PROTECTION DETAIL D3/L1.00.


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6. AMEND SOIL AS REQUIRED BY SOIL TESTING RESULTS IN ALL AREAS WHERE NEW PARKING LOT & STREET TREES ARE TO BE PLANTED.

7. SHADED AREAS ON DRAWING 18/AS-6.00 ARE SHOWN FOR TYPICAL EXTENT OF SOIL WORK IN LOCATIONS UNDER NEW STREET & PARKING LOT TREES. SOIL WORK

TO BE PERFORMED WHERE ALL NEW TREES ARE LOCATED.



10 Existing Site Plan PN SCALE: 1"=30'-0"

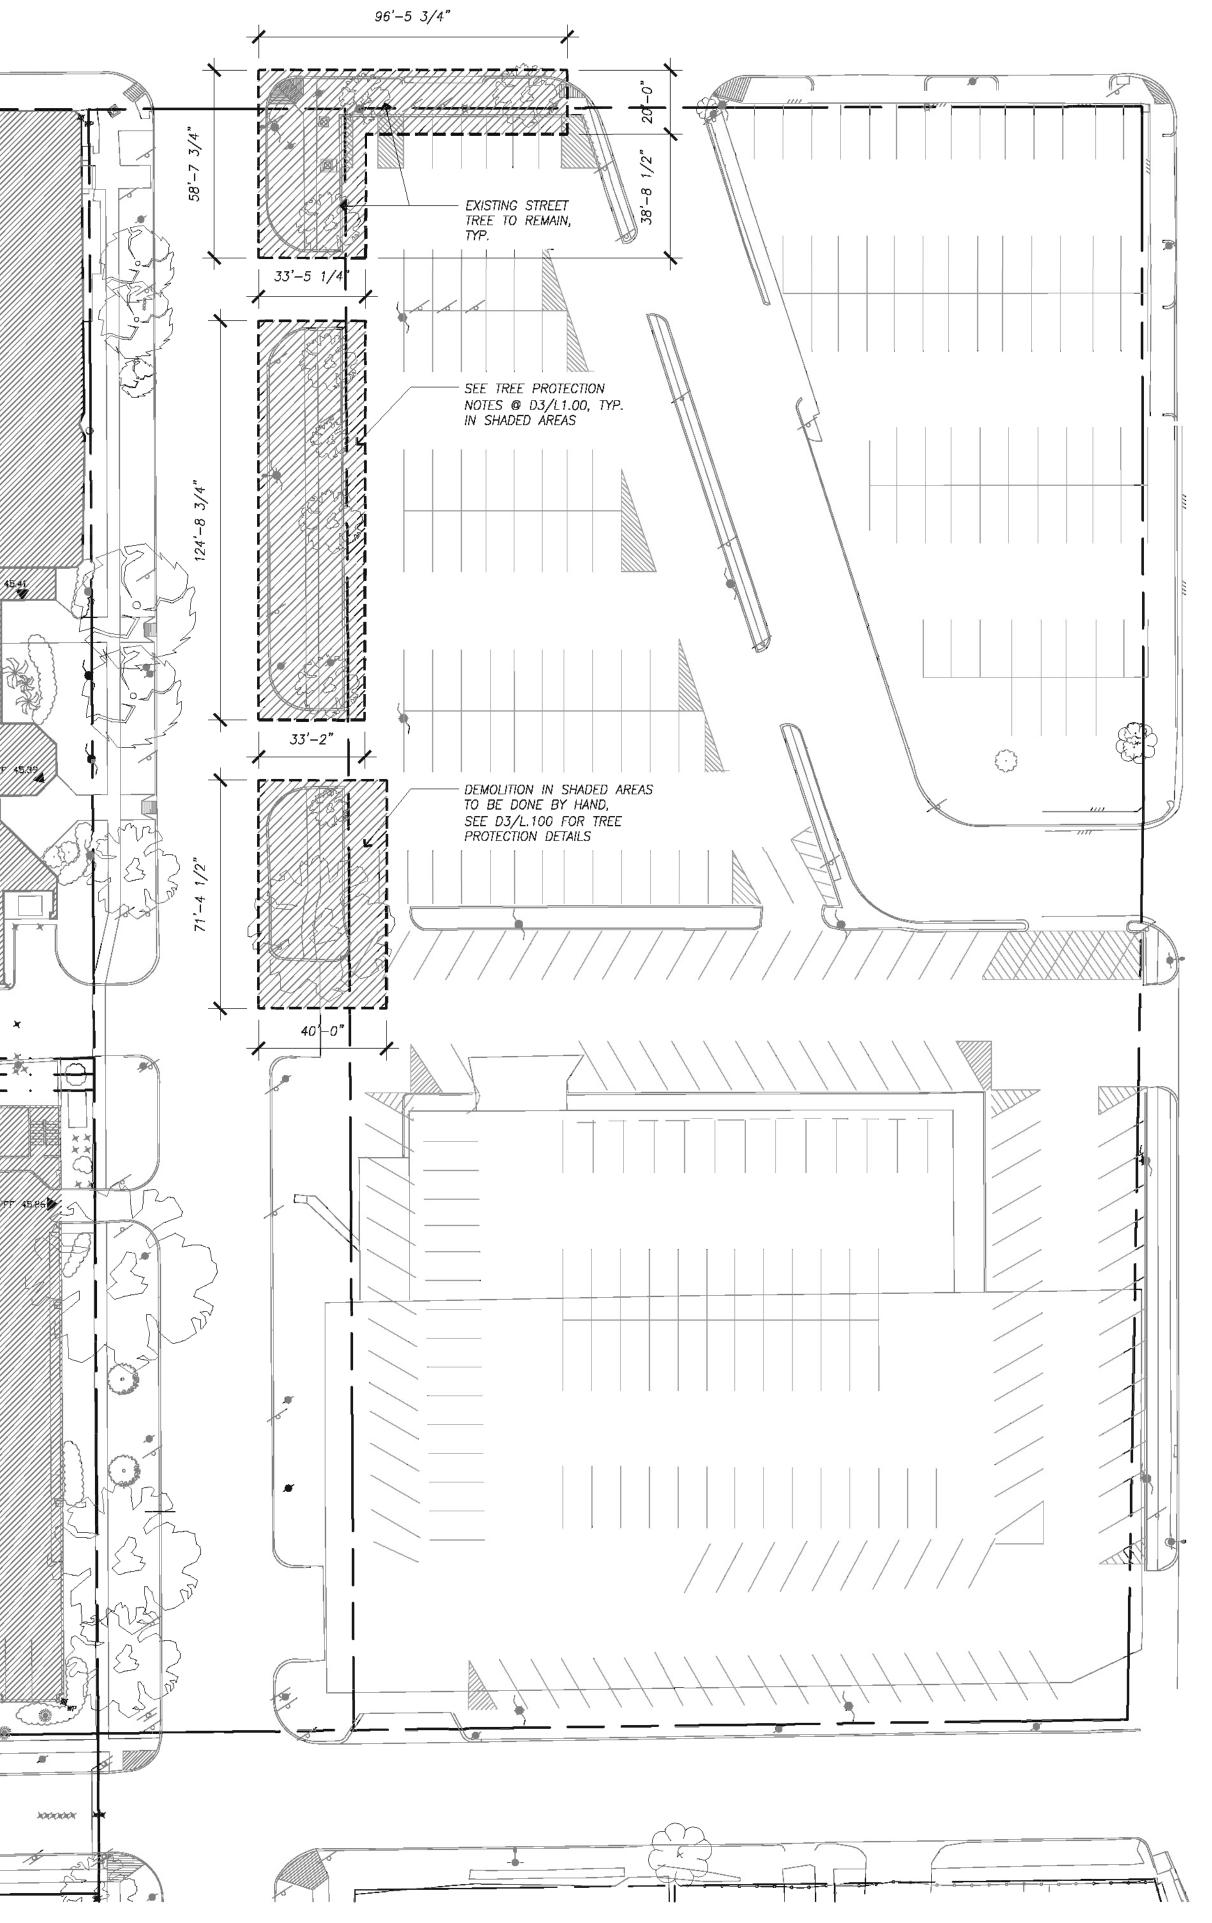

# Houston Community College

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# Central Campus Parking Lot Improvements

1300 Holman Street Houston, TX 77004

Contract No.:

Drawn By: XX

Checked By:

Date: XX/XX/XX

Date:


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Soil Amendment & Tree Protection Plan

Scale: 1" = 20'-0"

AS-6.00



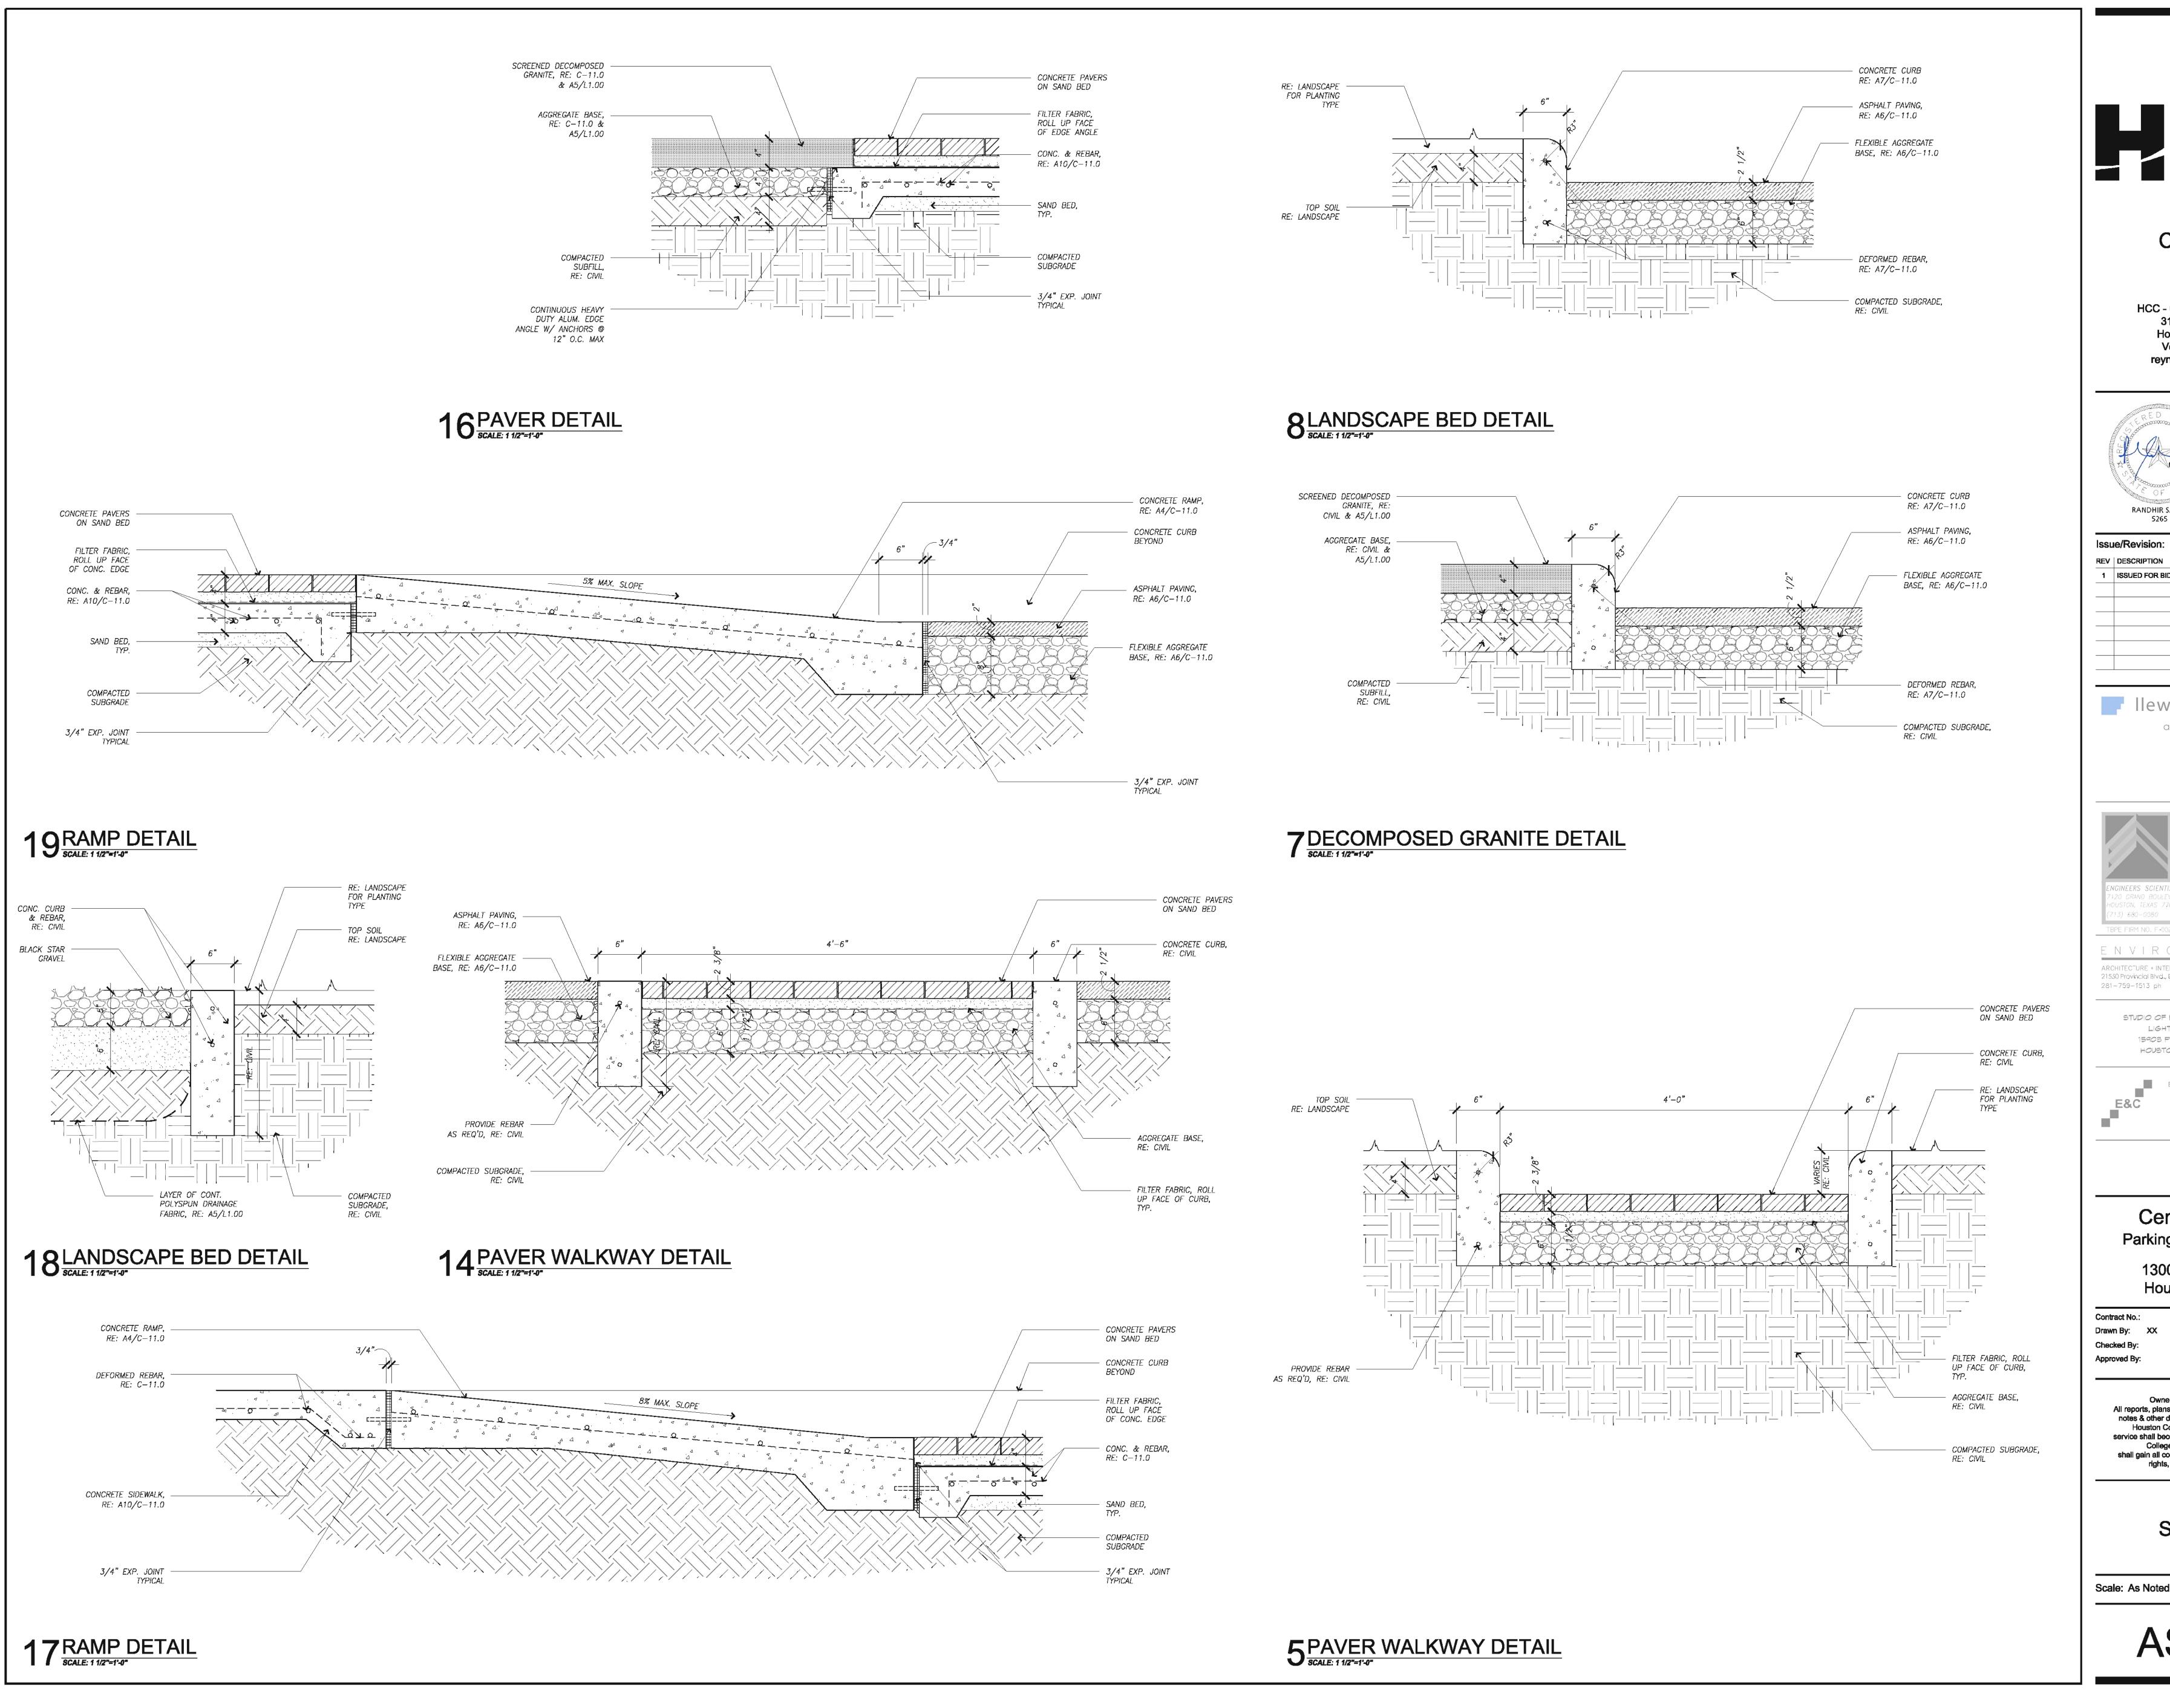

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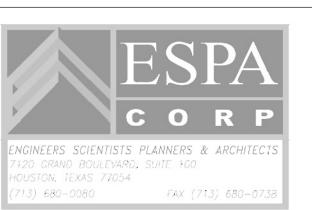
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1010 Lamar, #650 Houston, Texas 77002 713.580.8800 713.580.8888 Fax

Parking Lot Improvements 1300 Holman Street

**Central Campus** 

Houston, TX 77004 A/E Project No.:


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Site Details

Scale: As Noted

AS-6.01



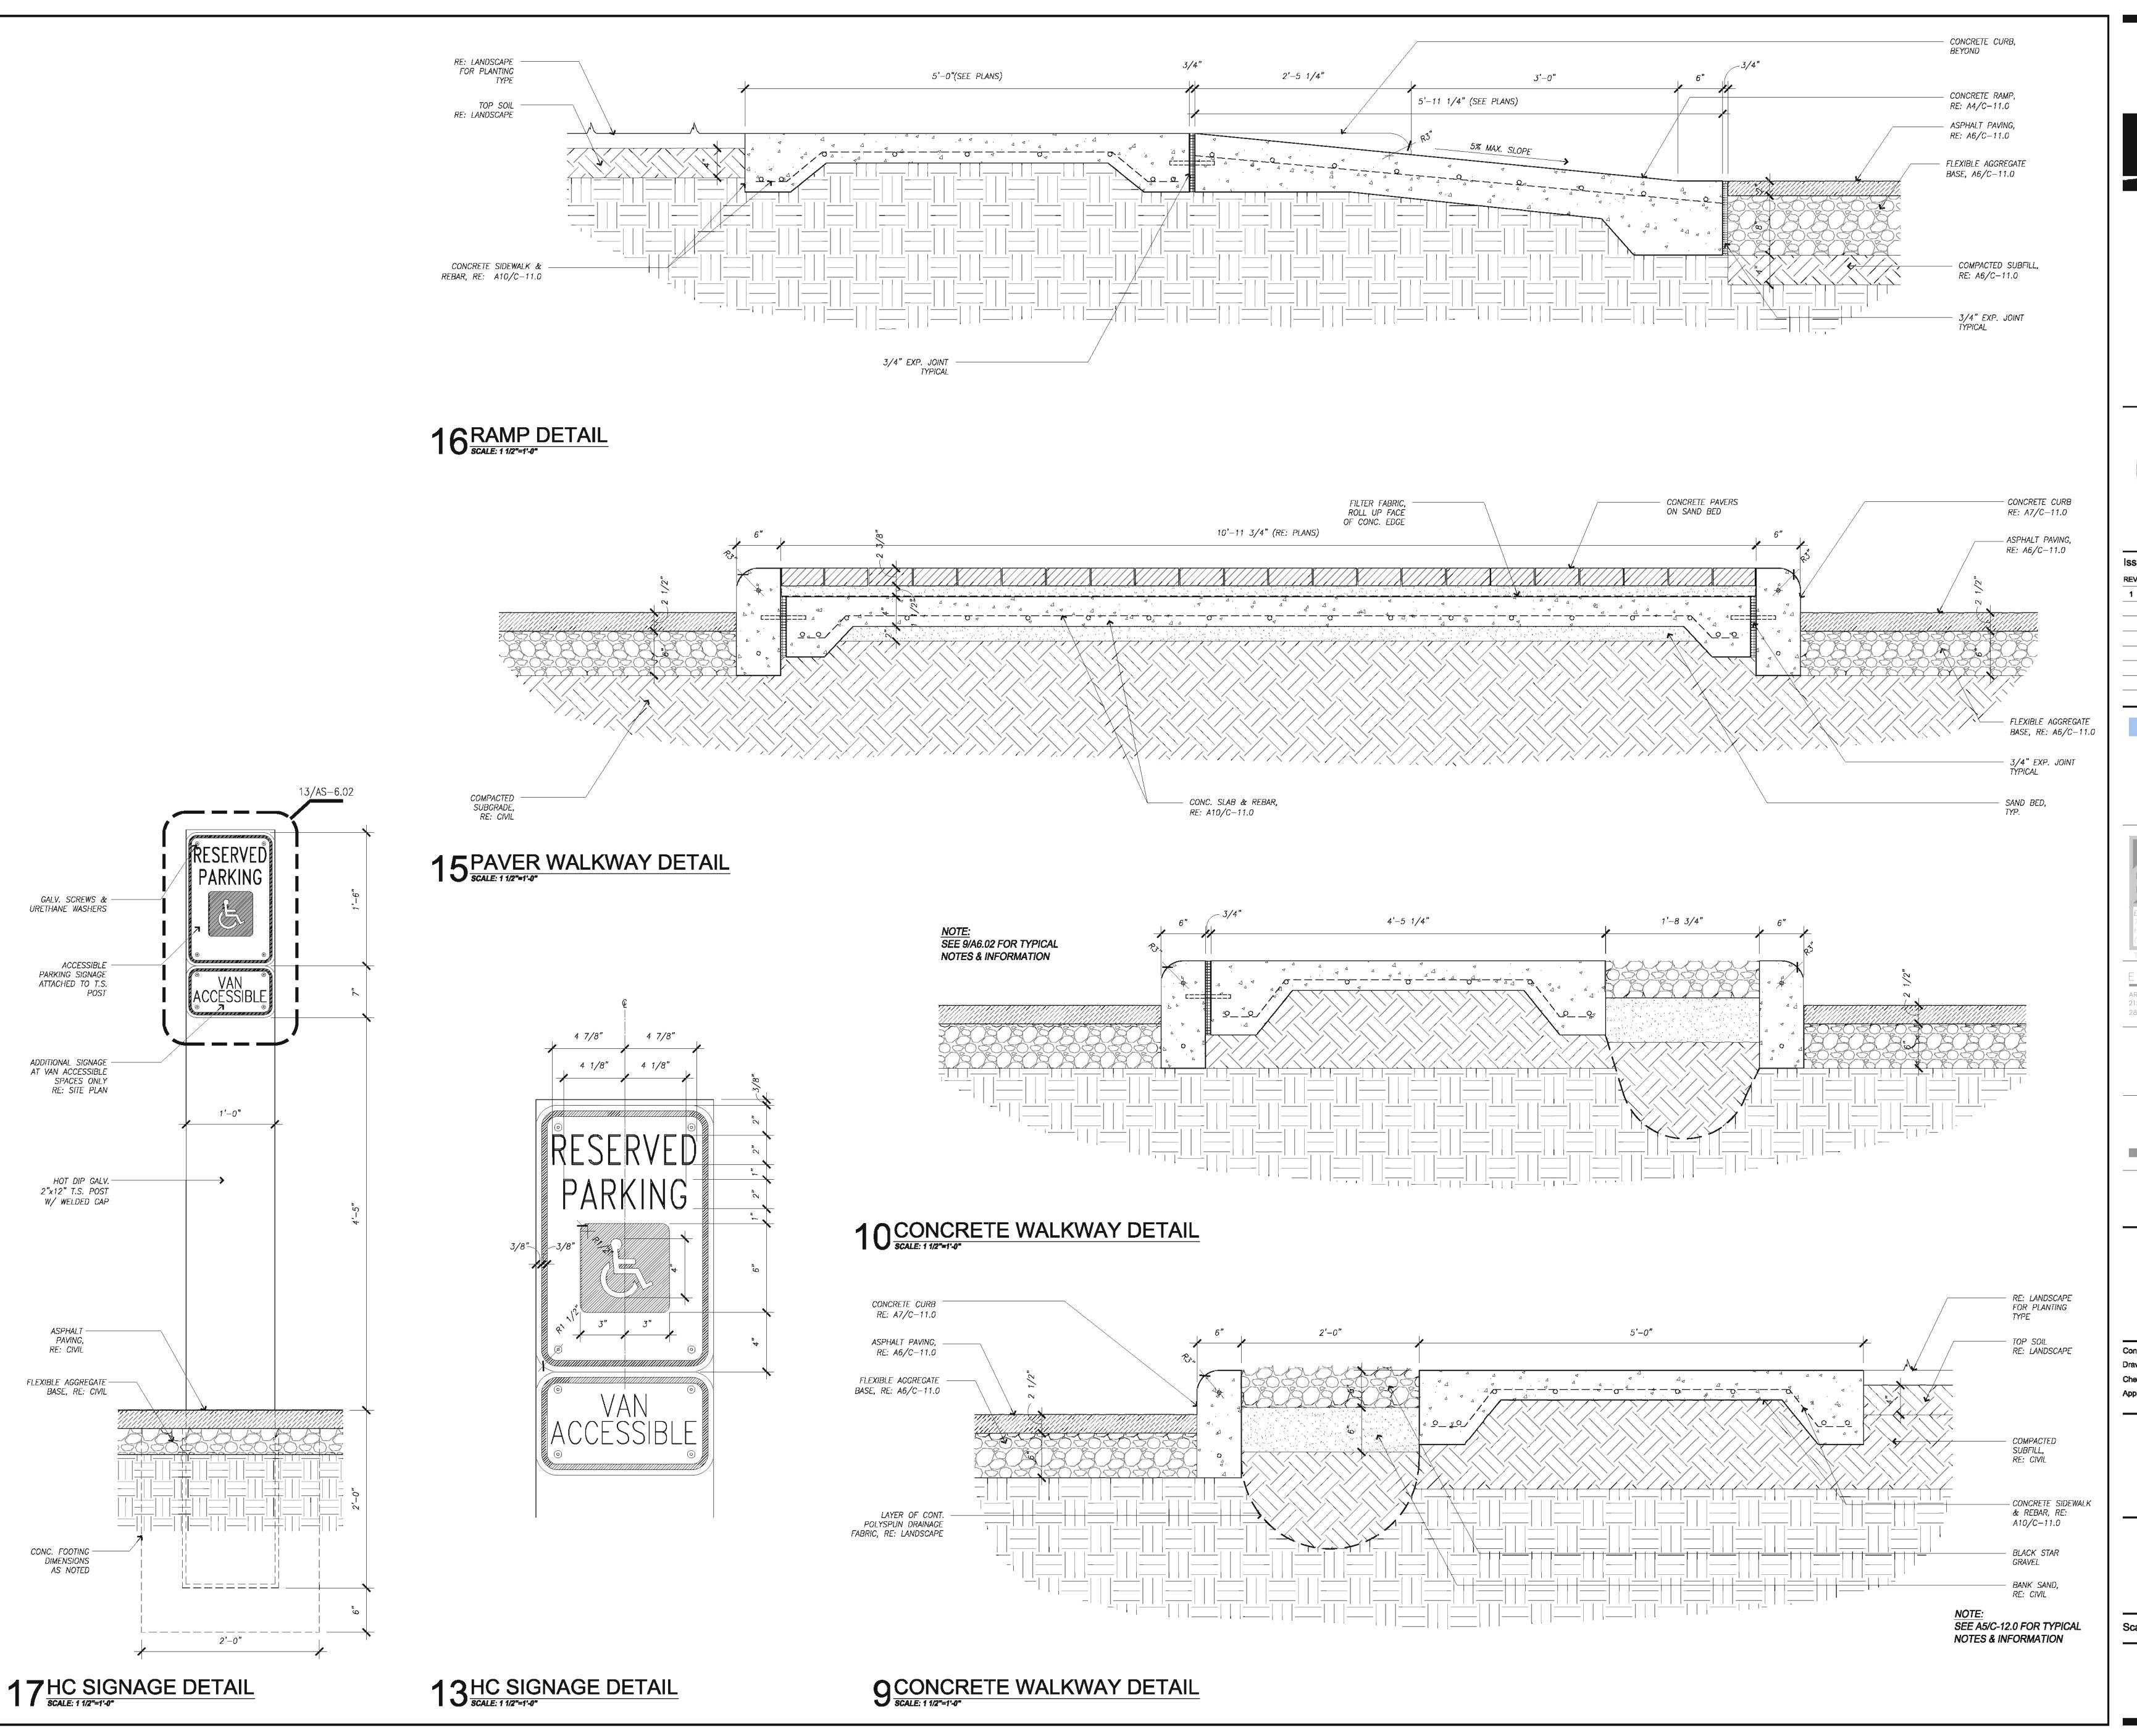

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#### Central Campus Parking Lot Improvements

1300 Holman Street Houston, TX 77004

Contract No.: A/E Project No.: Drawn By: Date: XX/XX/XX Checked By:


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Site Details

Scale: As Noted

AS-6.02



	ELECTR	ICAL SYMBOLS (ALL SYMBOLS SHOWN ARE	NOT NECESSAR	ILY USED ON THE DRAWINGS)
		INE/RISER DIAGRAMS		TACLES/OUTLETS
- UNIT	سلب		→ · · · · · · · · · · · · · · · · · · ·	SIMPLEX WALL RECEPTACLE, NEMA 5-20R, 20A, 125V
	₹800A/3P			NEW DUPLEX WALL RECEPTACLE, NEMA 5-15R, 15A, 125
		SWITCH, RATING AS SHOWN	<b>●</b>	OR NEMA 5-20R, 20A, 125V, RE: SPECIFICATIONS, DO INDICATES ABOVE COUNTER
	[] 225A/ 3F	FUSE, RATING AS SHOWN	₽ <sub>R</sub>	RELOCATED EXISTING DUPLEX RECEPTACLE
SOUND		CIRCUIT BREAKER, RATINGS AS SHOWN, 3 POLE UNLESS NOTED OTHERWISE	<b>43</b> 23	EXISTING DUPLEX RECEPTACLE TO REMAIN
	2000A/3	3P DRAWOUT CIRCUIT BREAKER, RATINGS AS SHOWN,	i ii  EXISTING DUPLEX RECEPTACLE TO BE REMOVED AND REUSED AS APPLICABLE	
	<b>→</b>	3 POLE UNLESS NOTED OTHERWISE	<b>⊕</b> =	DUPLEX WALL RECEPTACLE ON EMERGENCY CIRCUIT, RED COLOR
ER PUMP   CTIFIER	<b>(1)</b>	SHUNT TRIP	<b>←</b>	DUPLEX WALL RECEPTACLE ON A CIRCUIT DEDICATED TO DATA PROCESSING, GRAY COLOR. PROVIDE ISOLATED
	(GFR)	GROUND FAULT RELAY	_	GROUND TYPE RECEPTACLES WHERE NOTED WITH IG.
	$\otimes$	KIRK-KEY INTERLOCK	<del> </del> ₩₽	DUPLEX WALL RECEPTACLE. "WP" DENOTES WEATHERPROOF TP" DENOTES SAFETY TYPE.
	A 0-2000	AMMETER, RANGE AS SHOWN	<del> </del>	FOURPLEX WALL RECEPTACLE. NEMA 5-15R, 15A, 125V
	AS	AMMETER SWITCH	₩©	CLOCK OUTLET, NEMA 15-20R SIMPLEX, RE: SPECS
	\ <u>\\\\\\\\\\\\\\\\\\\\\\\\\\\\\\\\\\\</u>		<b>#</b>	SPECIAL RECEPTACLE, NEMA CONFIGURATION AS NOTED
	_	VOLTMETER, RANGE AS SHOWN	● PA	FLOOR OUTLET, "P" DENOTES POKE-THRU, "F" DENOTES FLUSH, "A" DENOTES TYPE WHERE APPLICABLE.
	<b>(</b> (s)	VOLTMETER SWITCH		MULTI-OUTLET SURFACE RACEWAY
	<b>₩</b> D-15	WATT-HOUR METER, "D" DENOTES DEMAND REGISTER "15" DENOTES MINUTES OF DEMAND INTERVAL	<b>( ( ( ( ( ( ( ( ( (</b>	JUNCTION BOX DIRECT CONNECTION TO EQUIPMENT
	1200/5		P	PULL BOX (OVER 4" SQUARE)
		/KV/   20V	⟨Ľ⟩	TENANT LIGHTING JUNCTION BOX
	<del>├</del> ≪⊞ <del>\</del>	POTENTIAL TRANSFORMER, RATING AS SHOWN	<u>(ē</u> )	TENANT POWER JUNCTION BOX
	<del> </del>  I	GROUND CONNECTION	ELECT	RICAL EQUIPMENT/CIRCUITING
ED	<b></b>	LIGHTNING ARRESTOR		DISTRIBUTION PANEL
FAN	©	GENERATOR SET		SWITCHBOARD OR MOTOR CONTROL CENTER
	-	AUTOMATIC TRANSFER SWITCH		NEW PANELBOARD (FLUSH/SURFACE MOUNT)
١,	□≫	BUS DUCT PLUG		EXISTING PANELBOARD
rrol i	CIDE A	I ADM		DRY-TYPE TRANSFORMER AUTOMATIC TRANSFER SWITCH
	FIRE A	LARM	ATS	PLYWOOD TERMINAL BOARD, TYPE AS NOTED,
۰,	FACP FACP	FIRE ALARM CONTROL PANEL (FLUSH/SURFACE)	<del></del>	4' X 8' X 3/4", UNLESS NOTED OTHERWISE TERMINAL CABINET (FLUSH/SURFACE MOUNT), TYPE AS
		FIRE ALARM REMOTE ANNUNCIATOR (FLUSH/SURFACE) FIRE ALARM AUDIO VISUAL SIGNAL, WALL MOUNTED		NOTED, 24" x48" x3 1/2", UNLESS NOTED OTHERWISE.
-	V	FIRE ALARM VISUAL SIGNAL, WALL MOUNTED	BAT	BATTERY/INVERTER UNIT CIRCUIT CONCEALED IN WALL OR CEILING
ASS		FIRE ALARM AUDIO SIGNAL, WALL MOUNTED		CONDUIT CAST IN CONCRETE OR BELOW SLAB
	(A)	FIRE ALARM CEILING SPEAKER		EXPOSED CONDUIT
	(H) (S)	HEAT DETECTOR  AREA SMOKE DETECTOR		CONDUIT TURNED UP
-	© ©	AREA SMOKE DETECTOR WITH LOCAL ALARM		CONDUIT TURNED DOWN HASH MARKS INDICATE NUMBER OF CONDUCTORS
	(D) <sub>RA</sub>	DUCT SMOKE DETECTOR. "RA" DENOTES RETURN AIR,	'''( ⊢ILA-2, 4	PHASE/NEUTRAL/SWITCH LEG/GROUND LEFT TO RIGHT. N HASH MARKS INDICATES 2*12, UNLESS OTHERWISE NOTE
₹	RI	SMOKE DETECTOR REMOTE INDICATOR STATION	<b>→</b> III	HOMERUN TO PANEL WITH CIRCUIT NUMBER(S) AS INDICATED.
	d <sub>ا</sub>	FIREFIGHTER'S COMMUNICATION JACK	+	PARTIAL CIRCUIT HOMERUN TO PANEL
	⊲ <sub>H</sub>	STAIRWAY EMERGENCY TELEPHONE	— T —	COMMUNICATIONS CONDUIT OR CABLE. "V" DENOTES
	F	FIRE ALARM MANUAL PULL STATION		VOICE, "D" DENOTES DATA, "I" DENOTES INTERCOM, "PA" DENOTES PAGING, "S" DENOTES SECURITY, "FA" DENOTES FIRE ALARM
<u>.                                    </u>	FJ WF	FIRE ALARM MANUAL PULL STATION WITH FIREMAN'S JACK SPRINKLER WATER FLOW SWITCH	<i>\O</i>	SINGLE OR THREE PHASE MOTOR
-	VS	VALVE SUPERVISORY SWITCH	CTT3	ELECTRIC DUCT HEATER
	DH	MAGNETIC DOOR HOLDER	다	DISCONNECT (SAFETY) SWITCH "200/3/150" DENOTES AMPERES/POLE/FUSE, "NF" DENOTES NON-FUSED
	<del>ф</del>	ELECTRIC DOOR LOCK	8-	ENCLOSED CIRCUIT BREAKER
	R (V)	FIRE ALARM RELAY FIRE ALARM VISUAL STROBE CEILING MOUNTED	⊠ 53	MOTOR STARTER
	<b>₩</b>	FIRE ALARM AUDIO VISUAL SIGNAL CEILING MOUNTED	⊠-	MOTOR STARTER FURNISHED WITH EQUIPMENT COMBINATION DISCONNECT (SAFETY) SWITCH AND MOTOR
			<b>.</b>	STARTER, "30/3/15/#0" DENOTES AMPERES/POLES/FUSE STARTER SIZE, "NF" DENOTES NON-FUSED.
	COMMU	INICATIONS	⊠-	COMBINATION DISCONNECT (SAFETY) SWITCH AND MOTOR STARTER FURNISHED WITH EQUIPMENT
	<b>⋖</b> ,	NEW VOICE WALL OUTLET. "W" DENOTES WALL PHONE HEIGHT, "P" DENOTES PAY PHONE, DOT INDICATES ABOVE COUNTER	<del>-∽</del> MS	MANUAL MOTOR STARTING WITH THERMAL OVERLOAD
	⋖ <sub>F</sub>	EXISTING VOICE WALL OUTLET TO REMAIN	C	LIGHTING CONTACTOR
	In the second secon	EXISTING VOICE WALL OUTLET TO BE REMOVED	ĪS	TIME SWITCH
	۵ م	NEW DATA WALL OUTLET	PC	PHOTOCELL
ED	⊲ <sub>R</sub>	RELOCATED EXISTING DATA WALL OUTLET		PUSH BUTTON
/E	्य सम	EXISTING DATA WALL OUTLET TO REMAIN EXISTING DATA WALL OUTLET TO BE REMOVED AND	<u>DC</u>	DOOR CONTACT SWITCH
,	·□ <sub>R</sub>	REUSED AS APPLICABLE	PANFI I	DESIGNATIONS
,	ICM	COMBINATION VOICE/DATA WALL OUTLET  INTERCOM MASTER STATION		
	ICS	INTERCOM STAFF STATION	2HEA-3	"2" DENOTES FLOOR WHERE PANEL IS LOCATED "H" DENOTES VOLTAGE - "H" = 480Y/277V,
	ICP	INTERCOM EQUIPMENT PANEL		"L" = 208Y/120V "E" DENOTES SYSTEM TYPE - BLANK = NORMAL POWER,
	<b>S</b>	CEILING MOUNTED SPEAKER		E=EMERGENCY POWER, U = UPS POWER  "A" DENOTES PANEL SEQUENCE
)	<b>S</b> □ M	PAGING HORN		A DENOTES FAREE SEGUENCE
	PATC	PAGING SYSTEM MICROPHONE PAGING SYSTEM TERMINAL CABINET		
	LIGHTIN	NG/SWITCHES		
	O <sub>A</sub> O <sub>B</sub>	NEW INCANDESCENT OR HID LIGHTING FIXTURE, LETTER		
	A OB	DENOTES TYPE, H PREFIX DENOTES HID		
	®	RELOCATED EXISTING INCANDESCENT OR HID LIGHTING FIXTURE, LETTER DENOTES TYPE WHERE APPLICABLE		
	0	EXISTING INCANDESCENT OR HID LIGHTING FIXTURE TO REMAIN		
	(Ē)	EXISTING INCANDESCENT OR HID LIGHTING FIXTURE TO		
		BE REMOVED AND REUSED AS APPLICABLE NEW EXIT SIGN, ARROWS AS INDICATED, LETTER		
	<b>⊈</b> x	DENOTES TYPE		
	<b>e</b> <sub>R</sub>	RELOCATED EXISTING EXIT SIGN, ARROWS AS INDICATED		
	0	EXISTING EXIT SIGN TO REMAIN, ARROWS AS INDICATED EXISTING EXIT SIGN TO BR REMOVED AND REUSED AS		
	⊖ <sub>R</sub>	APPLICABLE		
	FB	NEW FLUORESCENT LIGHTING FIXTURE, LETTER DENOTES TYPE, F PREFIX DENOTES FLUORESCENT		
	□R□ <sub>FB</sub>	RELOCATED EXISTING FLUORESCENT LIGHT FIXTURE, LETTER DENOTES TYPE WHERE APPLICABLE		
		EXISTING FLUORESCENT LIGHT FIXTURE TO REMAIN		
		EXISTING FLUORESCENT LIGHT FIXTURE TO BE REMOVED AND REUSED AS APPLICABLE		
	гр	MUR VERSER WR WELFTOWDEE		

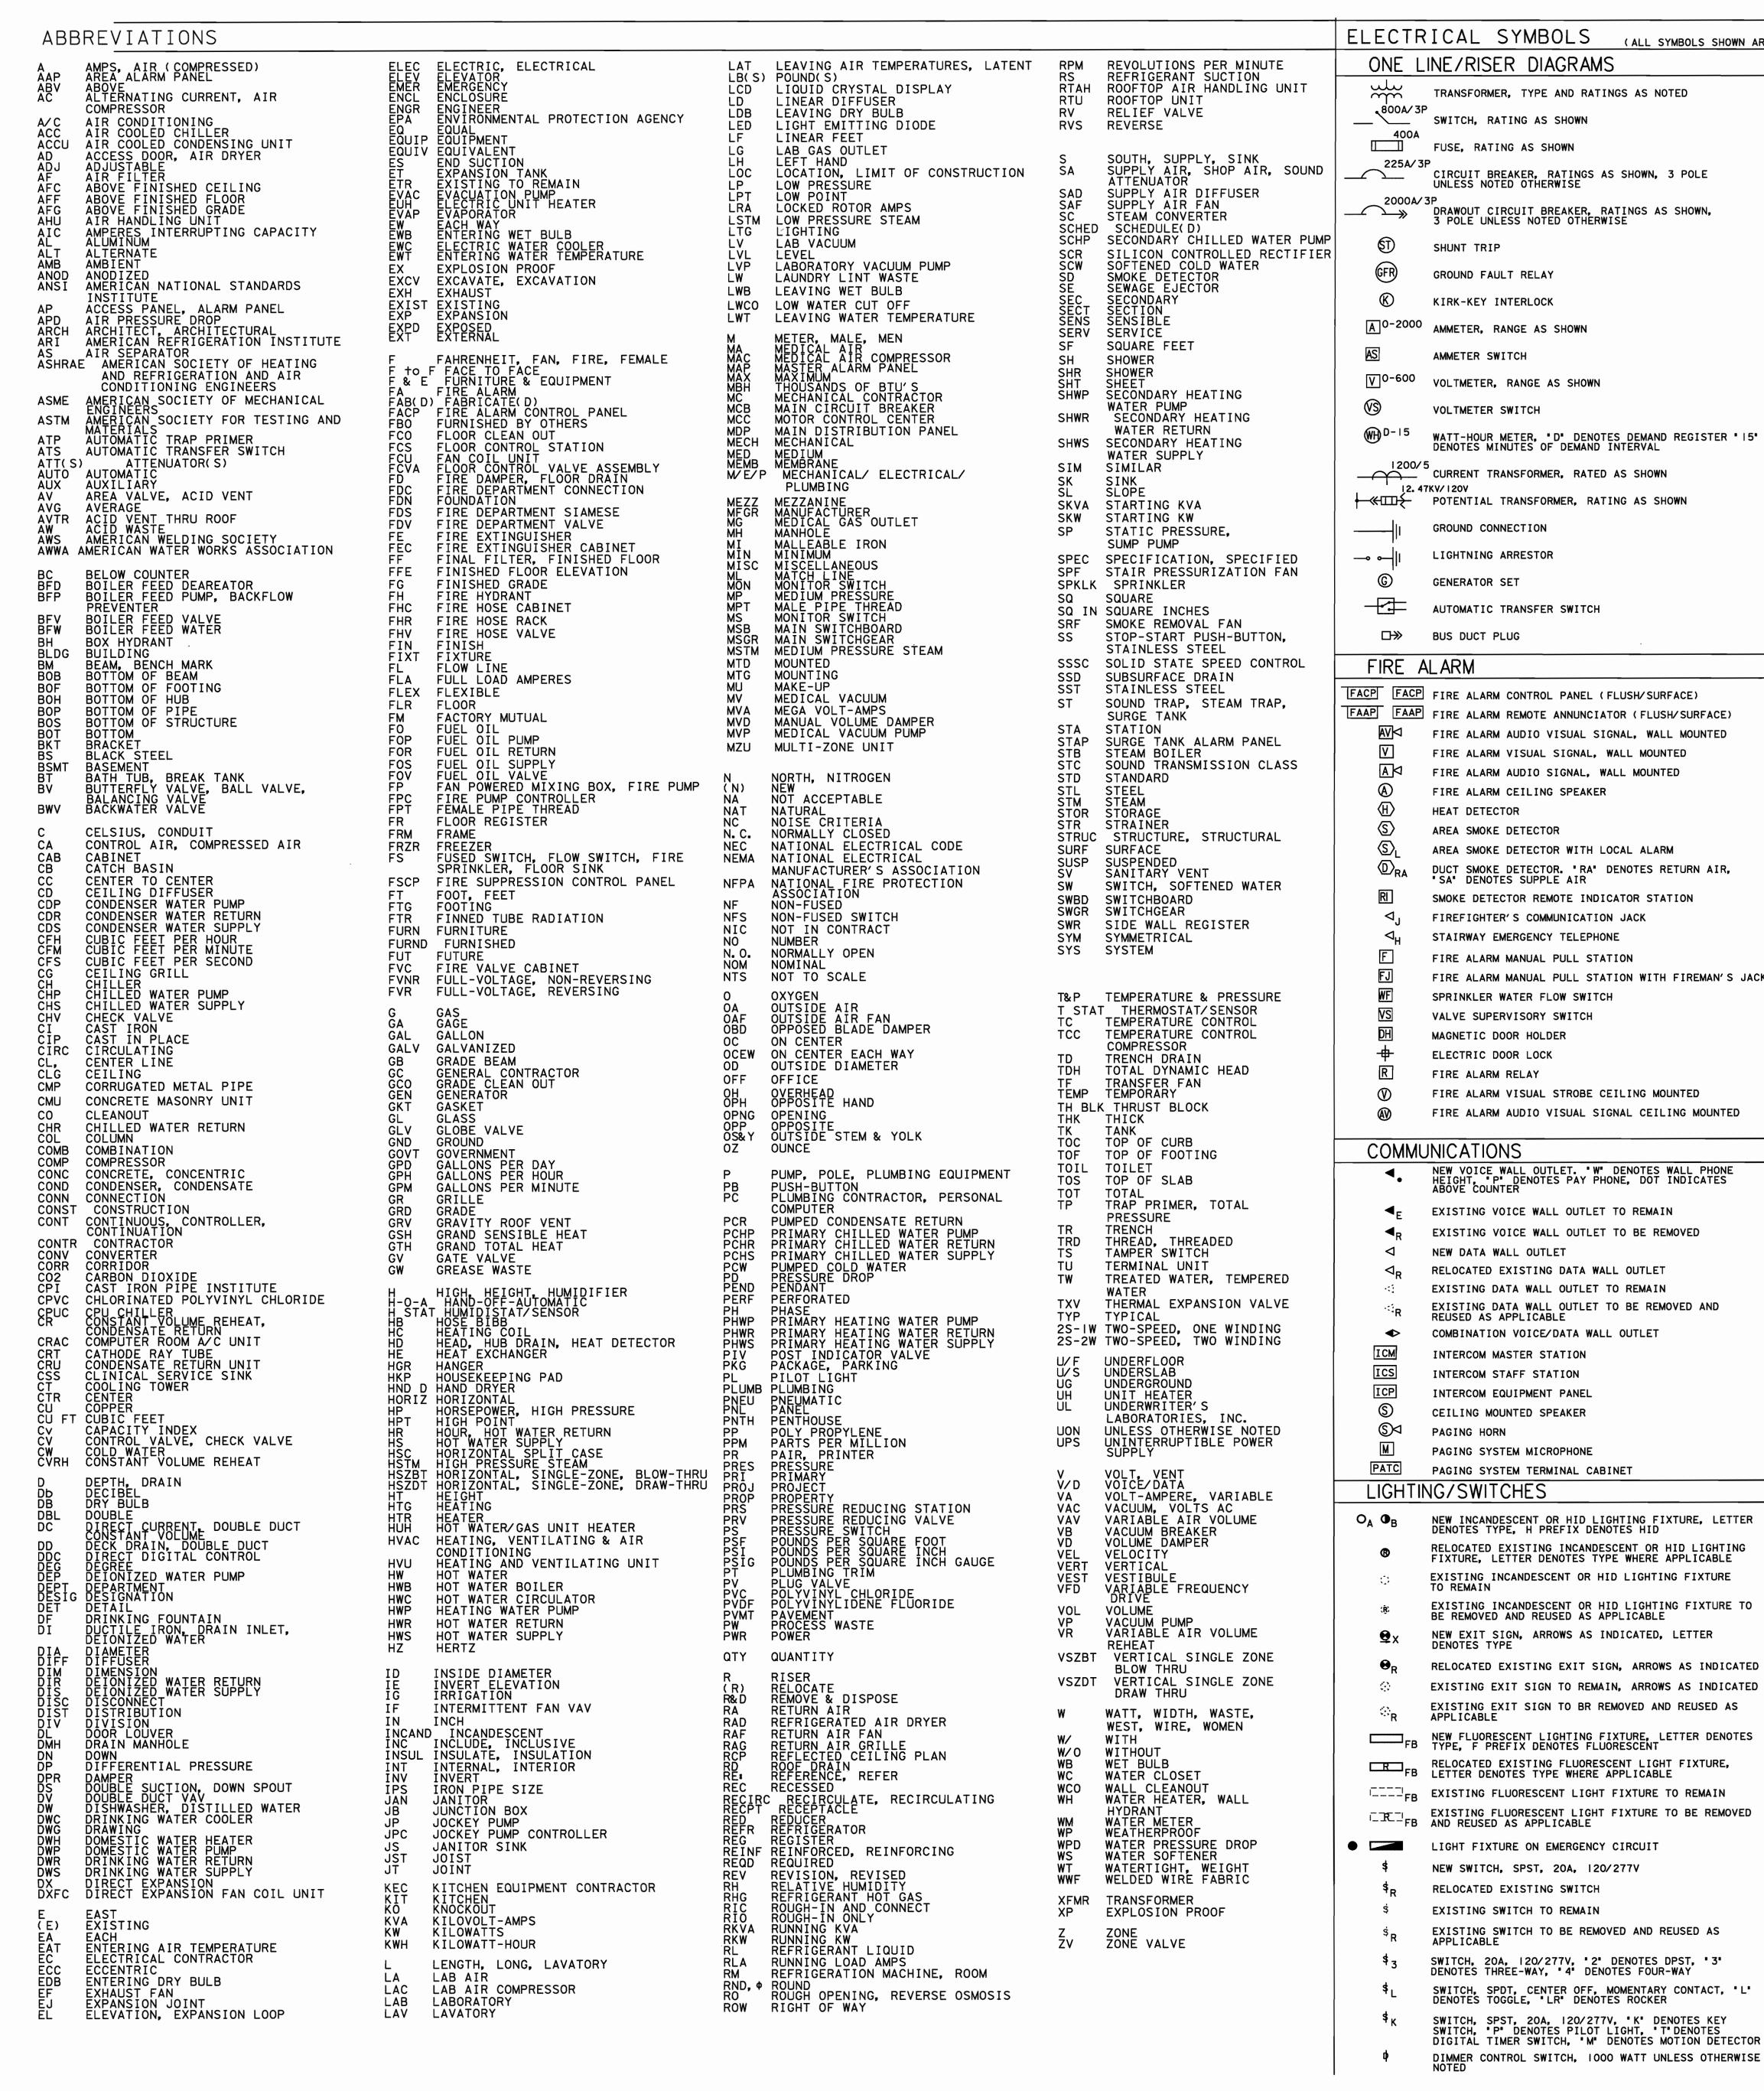GENERAL NOTES LY USED ON THE DRAWINGS) TACLES/OUTLETS SIMPLEX WALL RECEPTACLE, NEMA 5-20R, 20A, 125V REQUIREMENTS. NEW DUPLEX WALL RECEPTACLE, NEMA 5-15R, 15A, 125V OR NEMA 5-20R, 20A, 125V, RE: SPECIFICATIONS, DOT INDICATES ABOVE COUNTER RELOCATED EXISTING DUPLEX RECEPTACLE EXISTING DUPLEX RECEPTACLE TO REMAIN REQUIREMENTS. EXISTING DUPLEX RECEPTACLE TO BE REMOVED AND REUSED AS APPLICABLE DUPLEX WALL RECEPTACLE ON EMERGENCY CIRCUIT, RED COLOR DUPLEX WALL RECEPTACLE ON A CIRCUIT DEDICATED TO DATA PROCESSING, GRAY COLOR. PROVIDE ISOLATED GROUND TYPE RECEPTACLES WHERE NOTED WITH IG. DUPLEX WALL RECEPTACLE. "WP" DENOTES WEATHERPROOF, "TP" DENOTES SAFETY TYPE. DEVICES. FOURPLEX WALL RECEPTACLE. NEMA 5-15R, 15A, 125V RE: ARCHITECTURAL INTERIOR ELEVATIONS, IF CLOCK OUTLET, NEMA 15-20R SIMPLEX, RE: SPECS PROVIDED FOR LOCATIONS OF WALL MOUNTED DEVICES. SPECIAL RECEPTACLE, NEMA CONFIGURATION AS NOTED FLOOR OUTLET, "P" DENOTES POKE-THRU, "F" DENOTES FLUSH, "A" DENOTES TYPE WHERE APPLICABLE. MULTI-OUTLET SURFACE RACEWAY JUNCTION BOX DIRECT CONNECTION TO EQUIPMENT CONTRACTOR. PULL BOX (OVER 4" SQUARE) TENANT LIGHTING JUNCTION BOX OTHERWISE. TENANT POWER JUNCTION BOX RICAL EQUIPMENT/CIRCUITING DISTRIBUTION PANEL SWITCHBOARD OR MOTOR CONTROL CENTER NEW PANELBOARD (FLUSH/SURFACE MOUNT) EXISTING PANELBOARD DRY-TYPE TRANSFORMER AUTOMATIC TRANSFER SWITCH PLYWOOD TERMINAL BOARD, TYPE AS NOTED 4' X 8' X 3/4", UNLESS NOTED OTHERWISE TERMINAL CABINET (FLUSH/SURFACE MOUNT), TYPE AS NOTED, 24" x48" x3 1/2", UNLESS NOTED OTHERWISE. BATTERY/INVERTER UNIT CIRCUIT CONCEALED IN WALL OR CEILING CONDUIT CAST IN CONCRETE OR BELOW SLAB EXPOSED CONDUIT CONDUIT TURNED UP CONDUIT TURNED DOWN HASH MARKS INDICATE NUMBER OF CONDUCTORS PHASE/NEUTRAL/SWITCH LEG/GROUND LEFT TO RIGHT. NO HASH MARKS INDICATES 2#12, UNLESS OTHERWISE NOTED. HOMERUN TO PANEL WITH CIRCUIT NUMBER(S) AS INDICATED. PARTIAL CIRCUIT HOMERUN TO PANEL COMMUNICATIONS CONDUIT OR CABLE. "V" DENOTES VOICE, "D" DENOTES DATA, "I" DENOTES INTERCOM, "PA" DENOTES PAGING, "S" DENOTES SECURITY, "FA" DENOTES FIRE ALARM SINGLE OR THREE PHASE MOTOR ELECTRIC DUCT HEATER DISCONNECT (SAFETY) SWITCH "200/3/150" DENOTES AMPERES/POLE/FUSE, "NF" DENOTES NON-FUSED ENCLOSED CIRCUIT BREAKER MOTOR STARTER MOTOR STARTER FURNISHED WITH EQUIPMENT COMBINATION DISCONNECT (SAFETY) SWITCH AND MOTOR STARTER, "30/3/15/#0" DENOTES AMPERES/POLES/FUSE/STARTER SIZE, "NF" DENOTES NON-FUSED. COMBINATION DISCONNECT (SAFETY) SWITCH AND MOTOR STARTER FURNISHED WITH EQUIPMENT MANUAL MOTOR STARTING WITH THERMAL OVERLOAD LIGHTING CONTACTOR DRAWING LIST TIME SWITCH PHOTOCELL **PUSH BUTTON** SE000 Electrical Symbol & Abbreviations DOOR CONTACT SWITCH SEIOO Electrical Site Plan Demolition ESIGNATIONS SE200 Electrical Site Plan Alteration "2" DENOTES FLOOR WHERE PANEL IS LOCATED Electrical One Line and Schedules "H" DENOTES VOLTAGE - "H" = 480Y/277V, SE301 Wiring Diagram and Details "L" = 208Y/120V

ALL ELECTRICAL WORK SHALL COMPLY WITH APPLICABLE STATE & LOCAL BUILDING CODES & REFER TO THE SPECS FOR MATERIALS & METHODS FOR ELECTRICAL CONSTRUCTION. REFER TO THE SPECS FOR SUBMITTAL

THE ELECTRICAL CONTRACTOR SHALL VISIT THE SITE & FAMILIARIZE THEMSELF WITH EXISTING CONDITIONS WHICH WILL IMPACT CONSTRUCTION OF THIS PROJECT, PRIOR TO SUBMITTING BIDS.

RE: ARCHITECTURAL REFLECTED CEILING PLANS FOR THE EXACT LOCATION OF ALL CEILING MOUNTED

FURNISH ACCESS DOORS FOR INSTALLATION BY THE GENERAL CONTRACTOR WHERE ACCESS IS REQUIRED TO CONCEALED ELECTRICAL EQUIPMENT.


ALL REQUIRED HVAC CONTROL WIRING & EQUIPMENT SHALL BE PROVIDED BY THE MECHANICAL

ALL WIRING SHALL BE 2#12, #12G, 3/4"C, UNLESS NOTED OR SHOWN ON THE DRAWINGS

ALL RATED PARTITION PENETRATIONS SHALL BE SEALED WITH A UL-LISTED FIRE SAFING SYSTEM, IN ACCORDANCE WITH APPLICABLE STATE AND LOCAL REQUIREMENTS.

#### Houston Community College

HCC - Construction Department 3100 Main, 12th Floor Houston, Texas, 77002 Voice: 713.718.5168 reynaldo.pradia@hccs.edu

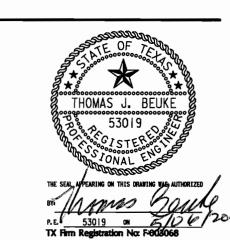

Issu	ue/Revision:		
REV	DESCRIPTION	DATE	BY
1	ISSUED FOR BID & CONSTRUCTION	05/09/11	JA

#### Ilewelyn-davies sahni

architecture + planning + design

5120 Woodway, Suite 8010 Houston, TX 77056 p: 713.850.1500 f: 713.850.1023 e: info@theldnet.com



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> STUDIO OF RICHARD JETER MFA LIGHTING DESIGNER

15908 PEBBLE BEND DR. HOUSTON, TEXAS 17068 E&C Engineers & Consultants Inc



Approved By: MHS

281-759-1513 ph

1010 Lamar, #650 Houston, Texas 77002 713.580.8800 713.580.8888 Fax

281-759-1723 fx

Central Campus Parking Lot Improvements

1300 Holman Street Houston, TX 77004

A/E Project No.: 2643.00 Contract No.: Date: 2011-05-06 Drawn By: Date: 2011-05-06 Checked By:

Ownership of Instruments of Service: All reports, plans, specifications, computer files, field data notes & other documents and instruments prepared for Houston Community College as instruments of service shall become the property of Houston Community

Date: 2011-05-06


College. Houston Community College shall gain all common law, statutory and other reserved rights, including the copyright thereto.

**Electrical Symbols** and Abbreviations

A. REFER TO SEOOO FOR SYMBOLS AND ABBREVIATIONS.

#### DRAWING NOTES:


- EXISTING ELECTRICAL SERVICE TO BE REMOVED, COORDINATE WITH CENTERPOINT ENERGY FOR THE REMOVAL OF THE POLE MOUNTED TRANSFORMERS, SERVICE POLES AND TRANSMISSION LINES.
- 2 REMOVE EXISTING ELECTRICAL RACK WITH METER AND DISCONNECTS.
- 3 REMOVE THE EXISTING POLE MOUNTED LIGHT AND ASSOCIATED CONDUIT AND WIRING.
- 4 STREET BEING ABANDONED, COORDINATE WITH CENTERPOINT TO REMOVE STREET LIGHTS AND OVERHEAD SERVICE.
- 5 EXISTING CENTERPOINT TIRZ STANDARD FIXTURE STREET LIGHT TO REMAIN,
- 6 COORDINATE WITH CENTERPOINT TO REMOVE THE EXISTING COBRA HEAD FIXTURE AND REPLACE WITH TIRZ STANDARD.

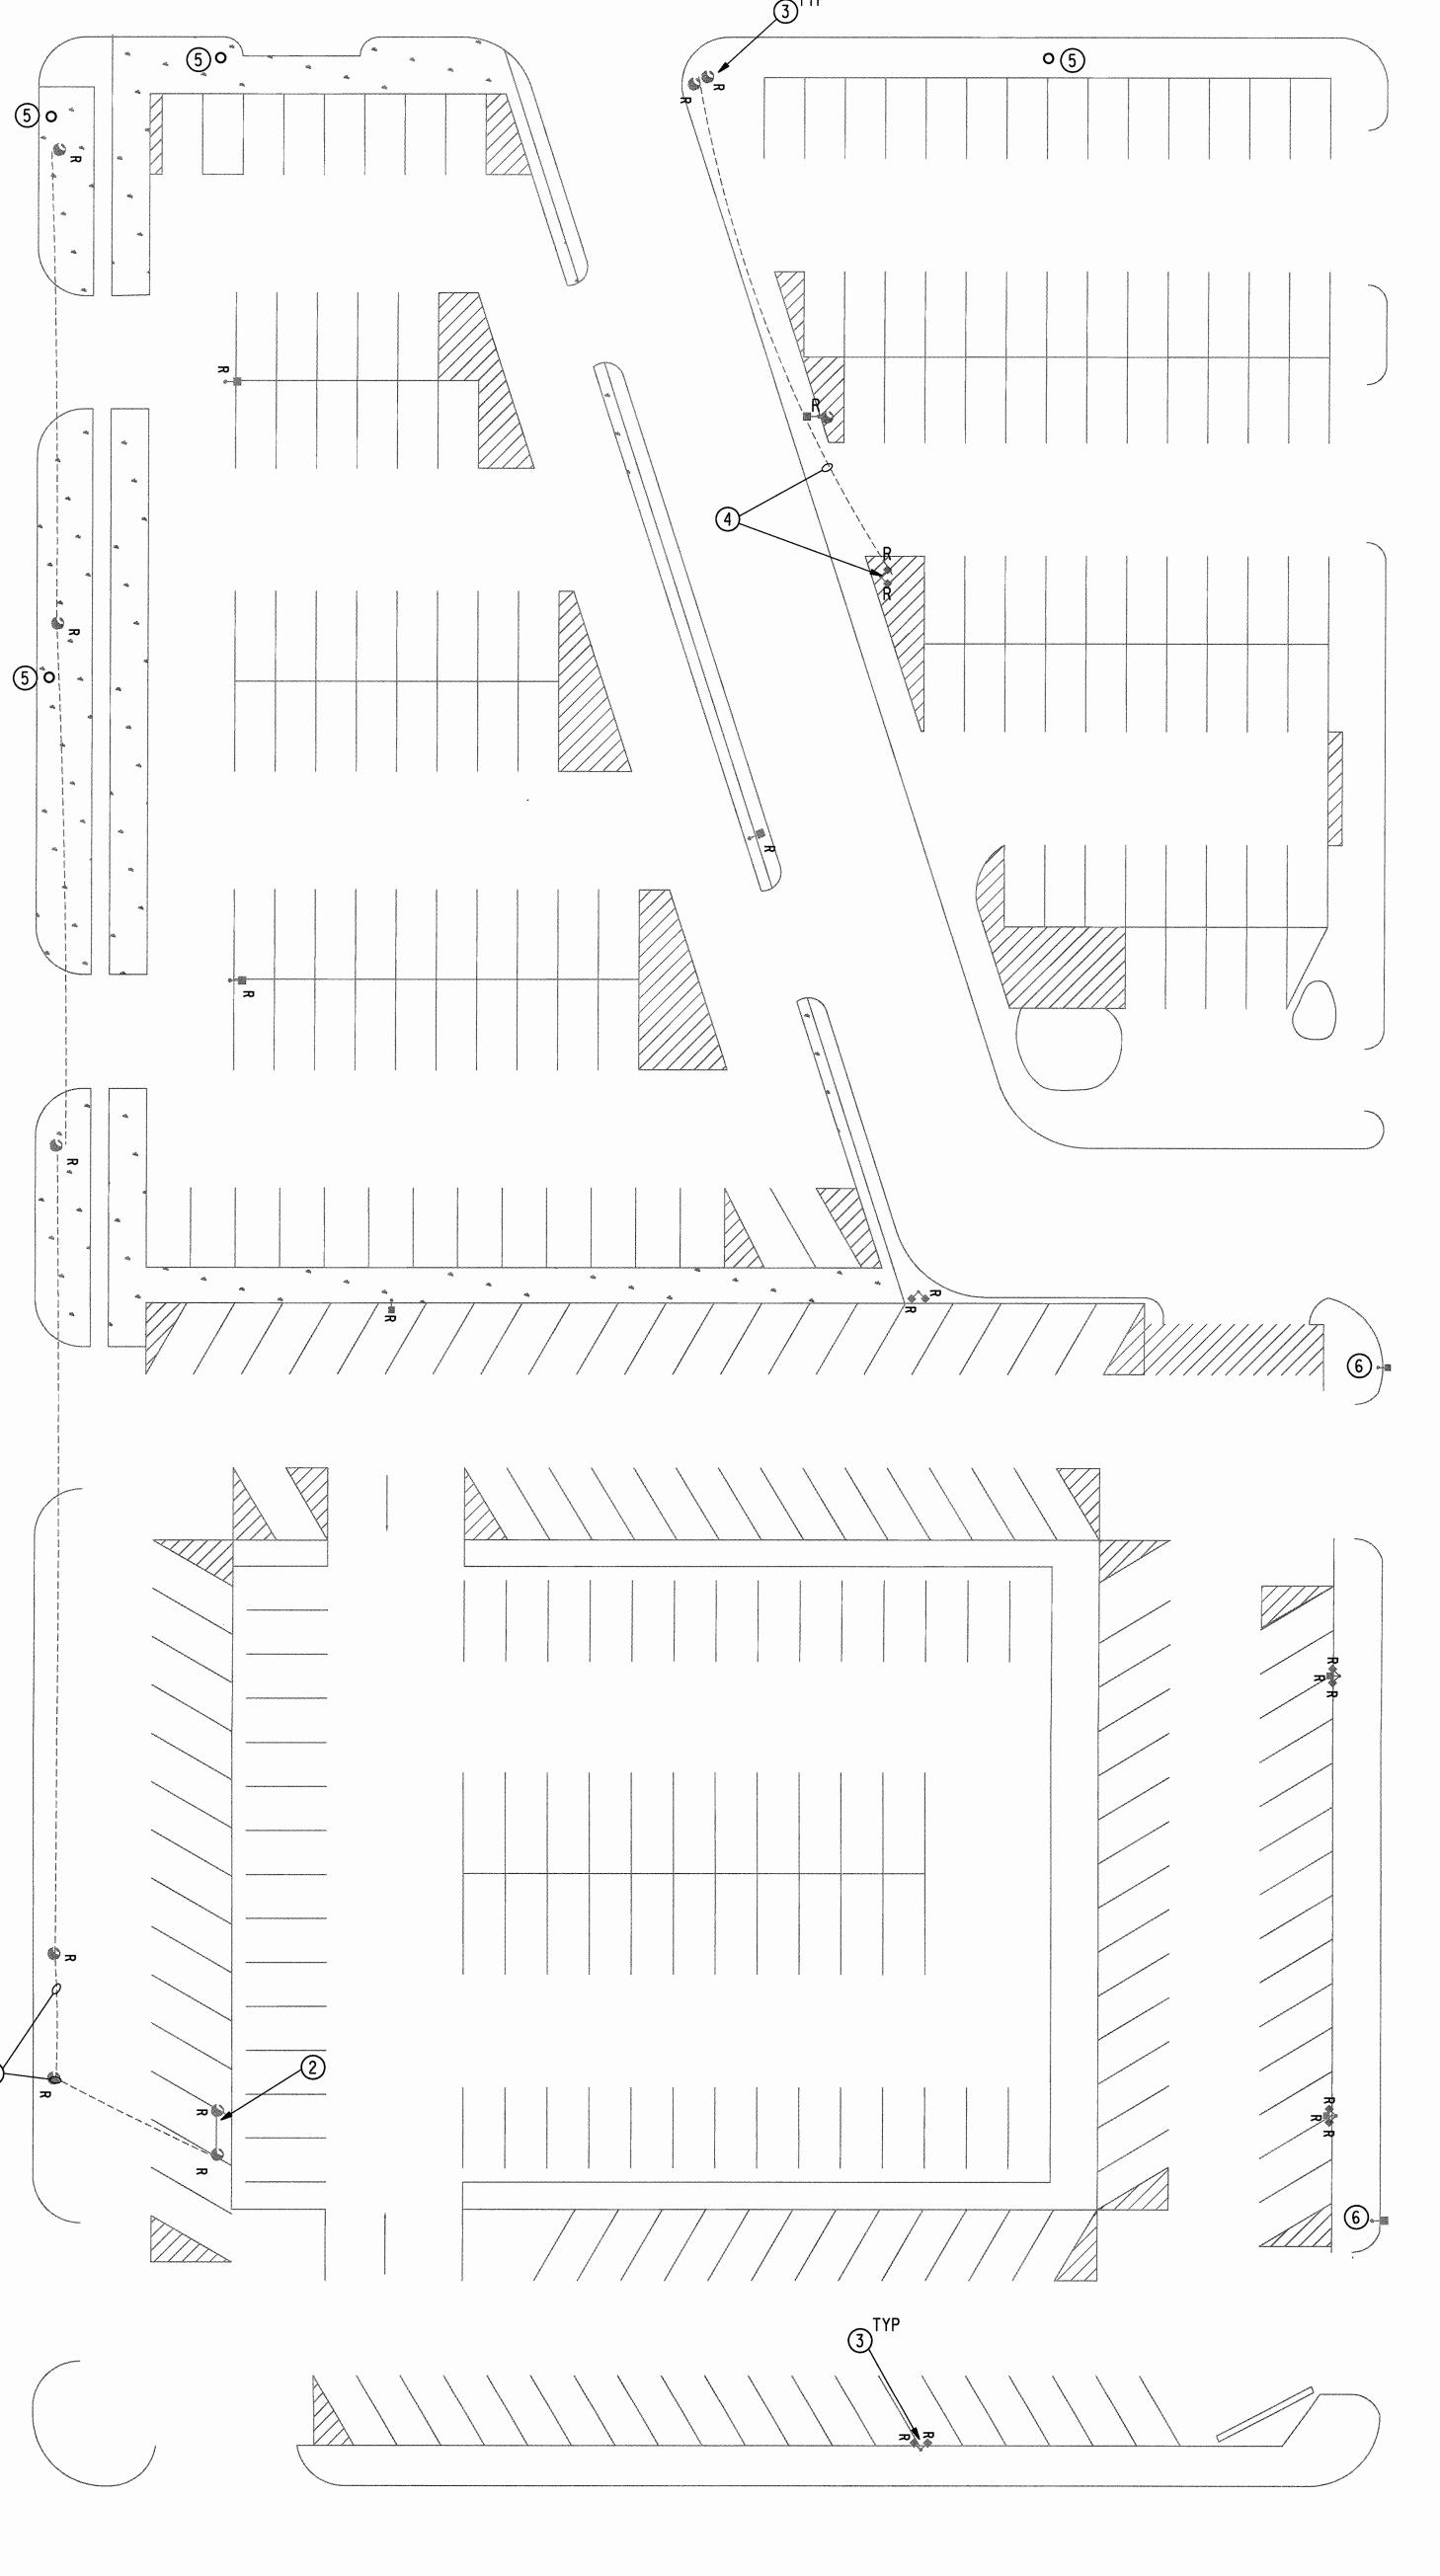



# Houston Community College

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DATE BY

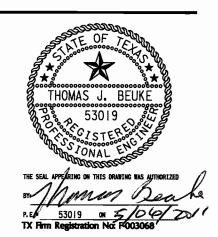05/09/11 JA

Issue/Revision:

REV | DESCRIPTION

1 ISSUED FOR BID & CONSTRUCTION

### Ilewelyn-davies sahni


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5120 Woodway, Suite 8010

Houston, TX 77056

p: 713.850.1500

f: 713.850.1023

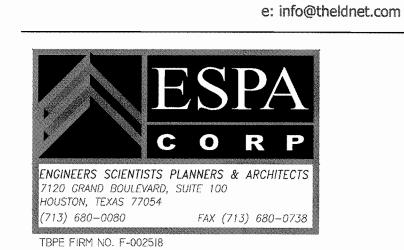

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STUDIO OF RICHARD JETER MFA LIGHTING DESIGNER 15903 PEBBLE BEND DR. HOUSTON, TEXAS 77068



E&C Engineers & Consultants Inc. 1010 Lamar, #650 Houston, Texas 77002 713.580.8880 713.580.8888 Fax

# Central Campus Parking Lot Improvements

1300 Holman Street Houston, TX 77004

 Contract No.:
 A/E Project No.: 2643.00

 Drawn By:
 MHS
 Date: 2011-05-06

 Checked By:
 TJB
 Date: 2011-05-06


 Approved By:
 MHS
 Date: 2011-05-06

Ownership of Instruments of Service:


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# ELECTRICAL DEMOLITION SITE PLAN

Scale

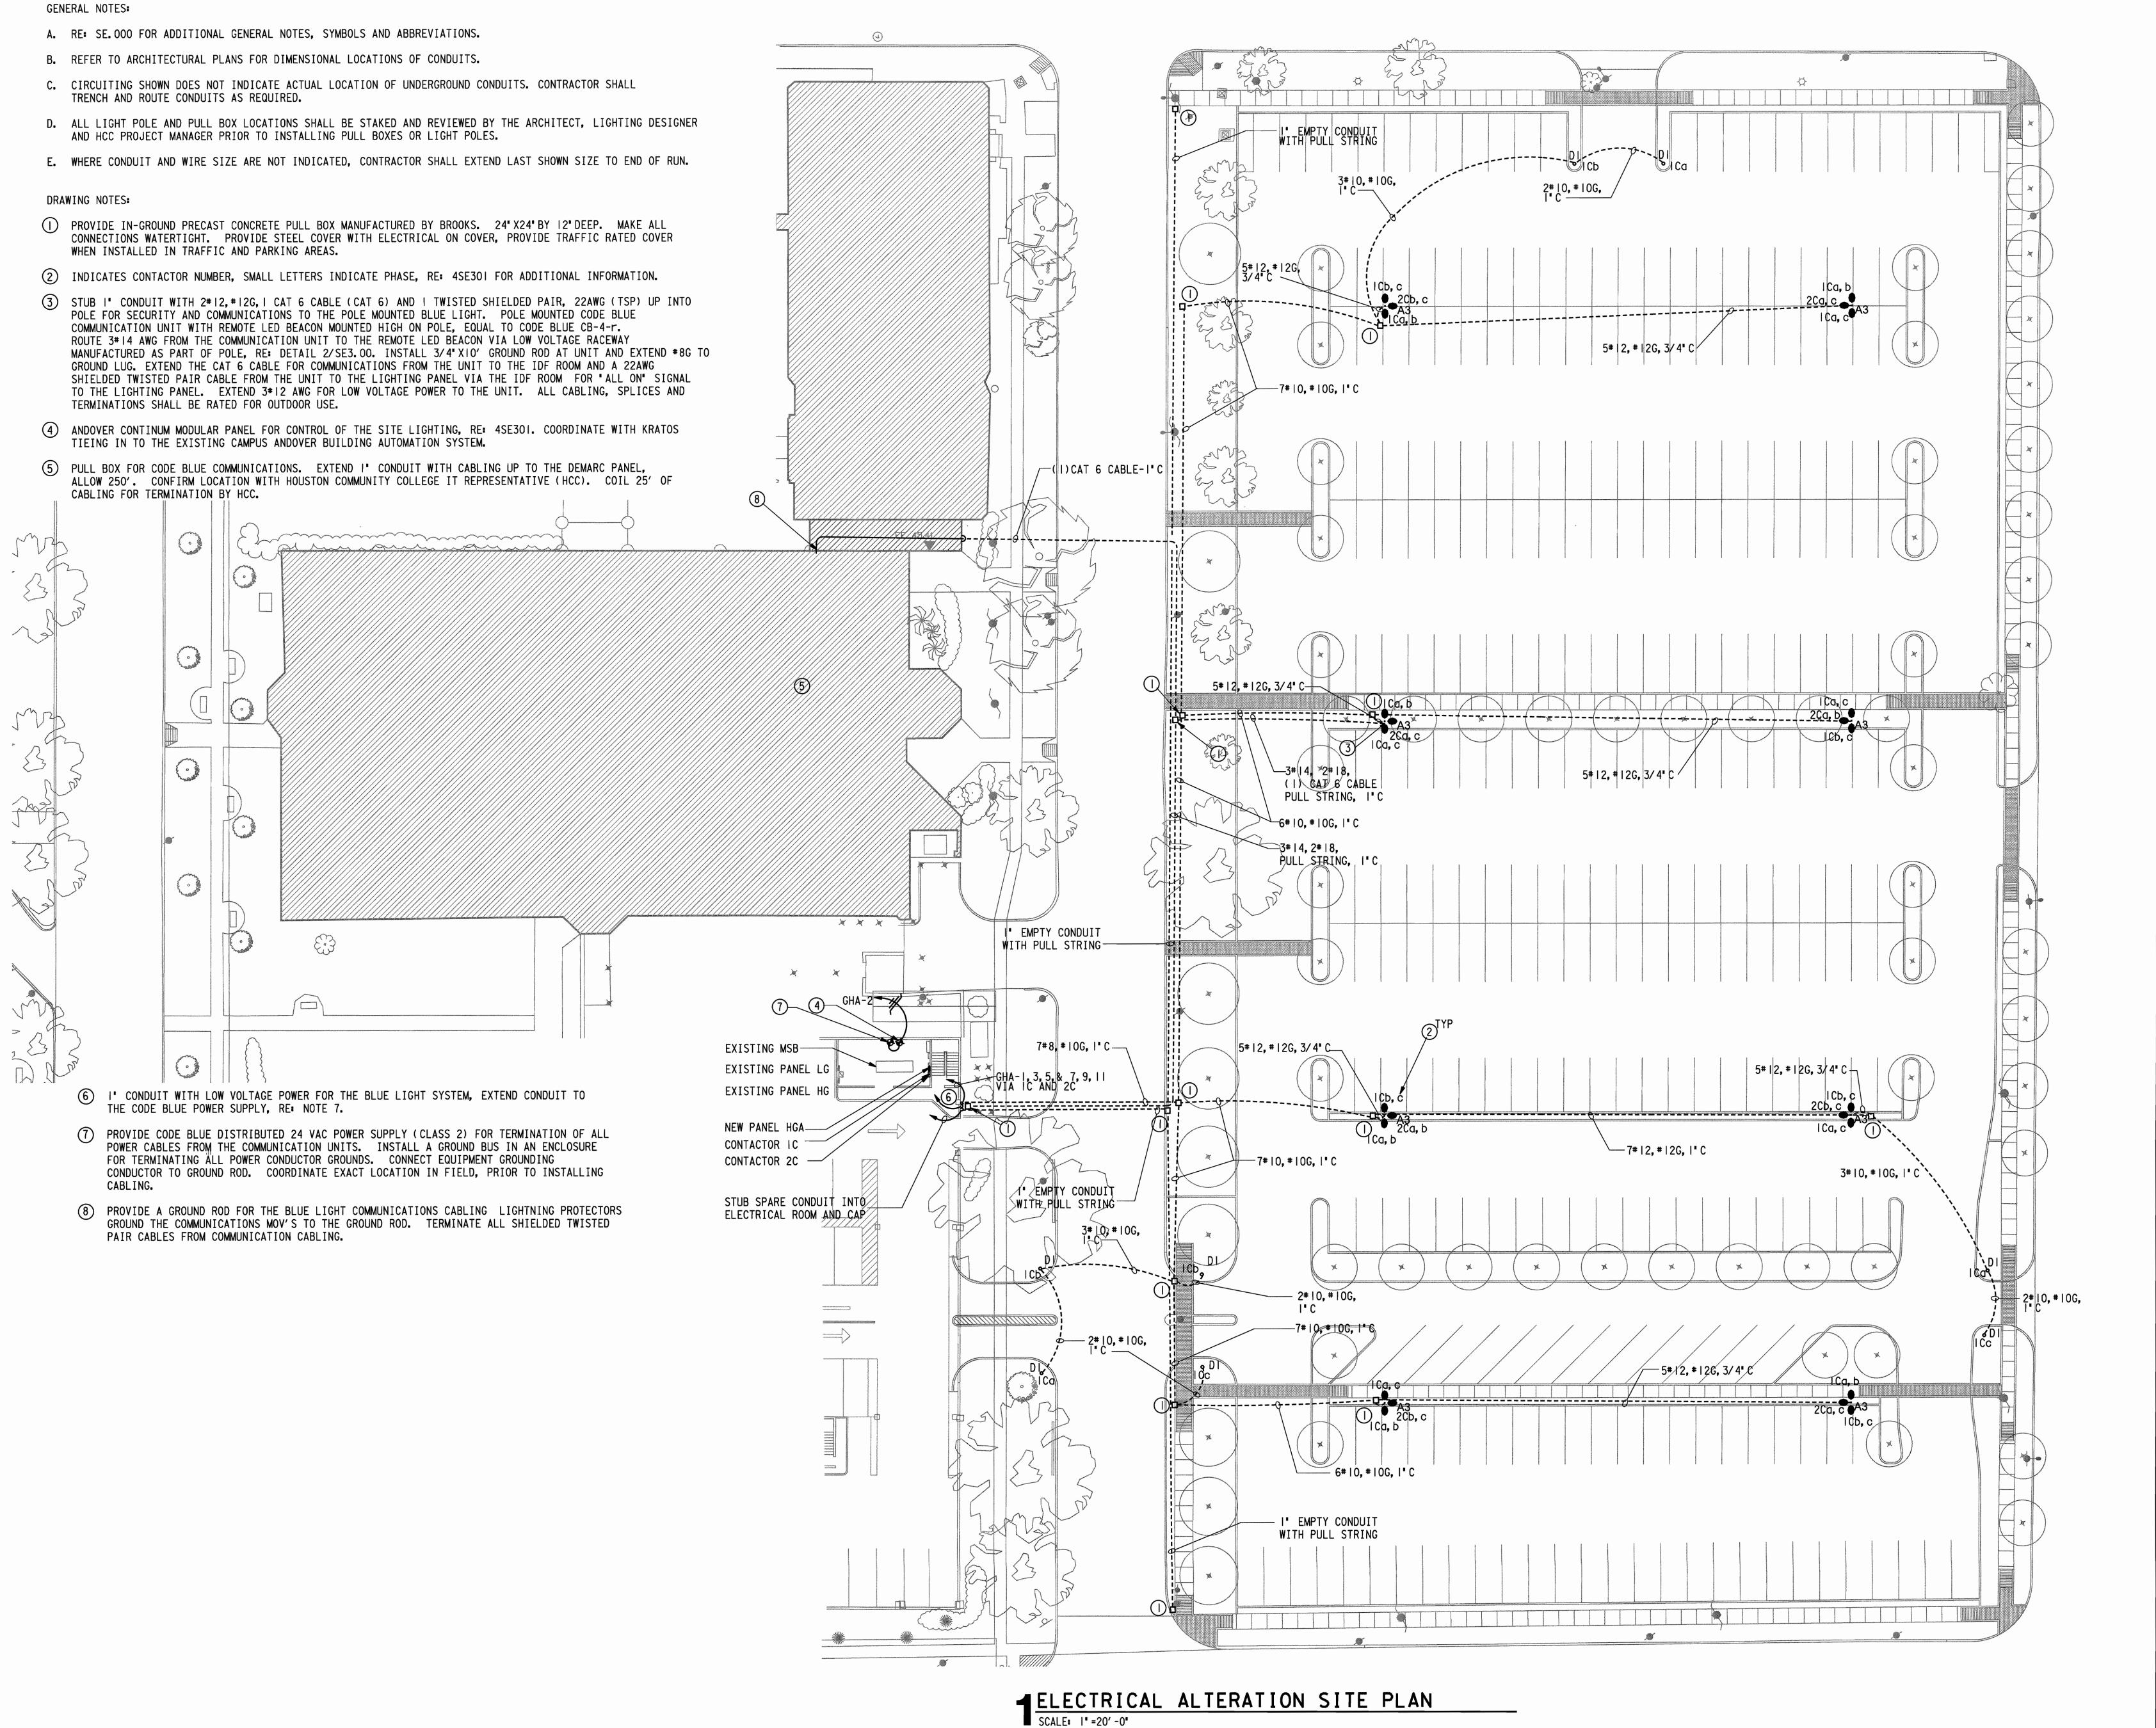

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Issu	ue/Revision:		
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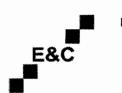
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> STUDIO OF RICHARD JETER MFA LIGHTING DESIGNER 15908 PEBBLE BEND DR. HOUSTON, TEXAS 77068

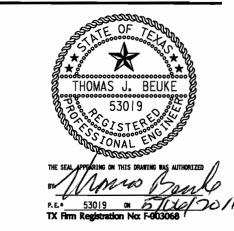

Approved By: MHS

281-759-1513 ph

E&C Engineers & Consultants Inc. 1010 Lamar, #650 Houston, Texas 77002 713.580.8800 713.580.8888 Fax

281-759-1723 fx

# Central Campus Parking Lot Improvements

1300 Holman Street Houston, TX 77004

Contract No.: A/E Project No.: 2643.00

Drawn By: MHS Date: 2011-05-06

Checked By: TJB Date: 2011-05-06

Ownership of Instruments of Service:

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Date: 2011-05-06

ELECTRICAL ALTERATION SITE PLAN

Scale:

<b>Panel</b>		HGA (NEW)					Project -	Central Campus Pa	rking Lot Lighting		
Location	<b>1</b> -	ELECTRICAL ROOM					E&C No.	2643			
Panel Ir	formation		Panel Load	s		Pł	nase A	Phase B	Phase C	Tota	al
Voltage		277/480V, 3P, 4W	Panel Light	ing VA		;	3910	4140	3910	1196	30
Panel T	ype	Panelboard	Panel Rece	ptacle V	Α		0	0	0	0	
Bus Am	ps	100A, 100% Neutral	Panel Equip	oment V	Α		100	0	0	100	)
Bus Typ	е	Copper/65,000AIC	FTL VA				0	0	0	0	
Panel M	lains	100A MLO	Total Conne	ected VA		4	4010	4140	3910	12060	
Breaker	Mtg	Bolt-In	Total Conn	ected An	nps		14	15	14	15	
Enclosu	ire	NEMA 3R Surface	NEC VA			4988		5175	4888	1505	30
Accesso	ories	Ground I Bus	NEC Amps				18	19	18_	18	
Ckt.	Bkr.	Circuit Use	Load	Type	Ph.	Ckt.	Bkr.	Circu	it Use	Load	Туре
1	-	-	2530	2	Α	2	15/1	Lighting Control Pov	ver	100	1
3	20/3	Site Lighting Zone 1	2530	2	В	4	20/1	Spare			
5	-	-	2300	2	С	6	20/1	Spare	-		
7	-		1380	2	Α	8		Space			
9	20/3	Site Lighting Zone 2 (Security)	1610	2	В	10		Space			
11	-		1610	2	С	12		Space			
13		Space			Α	14		Space			
15		Space			В	16		Space			
17		Space			С	18		Space			
19		Space			Α	20		Space			
21		Space			В	22		Space			
23		Space			С	24		Space			
				ļ							
				<b>_</b>							
				ļ							
		epts (per NEC), 1 = Equip. (100%), 2 = Lighti	/40E0/\ 0 \/O	/4000/\ A	- Haati	na (100%)	E-last M	lator (125%) 6 - Kitahan	Equip (per MEC)		

PANEL		HG (Existing)				Project: HCC Central Campus Parking Lot					
Location 1st Floor Electrical Room					E&C No.: 2643						
		Panel Information						Panel Lo	oads		
Voltage	):	277/480V, 3P, 4	4W			FTL VA	\		0		
Panel T	уре:	Panelboard				Panel L	ighting VA	/A 65		164	
Bus Am	nps:	400A, 100% Ne	utral			Panel F	Receptacle	e VA		0	
Bus Ty	pe:	Copper/14,000	AIC			Panel E	quipment	:VA	77	300	
Panel N	fains:	400A MLO				Total C	onnected	VA	142	2464	
Breake	r Mtg.:	Bolt-in				Total C	onnected.	Amps	1	71	
Enclos	ıre:	NEMA 1 Surfa	ce			NEC VA			158755		
Access	ories:	Ground Bus				NEC A	mps		1	91	
Ckt.	Bkr.	Circuit Use	Load	Туре	Ph.	Ckt.	Bkr.	Circuit U	Jse	Load	T
1	20/1	Existing Circuit	3989	2	Α	2	20/1	Existing Circuit		3989	$\top$
3	20/1	Existing Circuit	3457	2	В	4	20/1	Existing Circuit		3989	
5	20/1	Existing Circuit	3989	2	С	6	20/1	Existing Circuit		3989	
7	20/1	Existing Circuit	3989	2	Α	8	20/1	Existing Circuit		3989	
9	20/1	Existing Circuit	3457	2	В	10	20/1	Existing Circuit		3989	
11	20/1	Existing Circuit	3989	2	С	12	20/1	Existing Circuit		3989	
13	20/1	Existing Circuit	3250	1	Α	14	20/1	Existing Circuit		3989	
15	20/1	Existing Circuit	2670	2	В	16	20/1	Existing Circuit		3250	
17	20/1	Existing Circuit	3250	1	С	18	_	-		4500	
19	-	_	3250	1	Α	20	60/3	Existing Circuit		4500	
21	20/3	Existing Circuit	3250	1	В	22		-		4500	
23		-	3250	1	С	24	20/1	Existing Circuit		3250	
25	_		3250	1	Α	26	20/1	Existing Circuit		3250	
27	20/3	Existing Circuit	3250	1	В	28	20/1	Space			
29			3250	1	С	30	20/1	Space			
31	-		4988	1	Α	32	20/1	Existing Circuit		3250	
33	100/3	New Panel HGA (1)	5175	1	В	34	20/1	Existing Circuit		3250	
35	-		4888	1	С	36	20/1	Existing Circuit		3250	
37	20/1	Existing Circuit	3723	2	Α	38	20/1	Existing Circuit		3250	
39	20/1	Existing Circuit	3989	2	В	40	20/1	Space			$\perp$
41	20/1	Existing Circuit	3989	2	C	42	20/1	Space			

#### LIGHT FIXTURE SCHEDULE

TYPE DESCRIPTIO


FIXTURE: MOONGOOSE PARKING AREA LIGHT WITH INTEGRAL ARCHITECTURAL ARM SUITABLE FOR SITE LINK MOUNTING. (3) VERTICAL 400W PULSE START METAL HALIDE LAMP, 480V, SINGLE PHASE, ENERGY SAVING LOW LOSS BALLAST, TEMPERED FLAT GLASS LENS, SYMMETRICAL IES FULL CUT-OFF DISTRIBUTION, GRAPHITE POWDER COAT (TIGER DRYLAC METALLIC #P5 49/80180-C), ARCHITECTURAL ARM MOUNTING.

- MANUFACTURER: (3) HOLOPHANE G400PM48LSFAA-SL-HCCA MONGOOSE WITH ARCHITECTURAL ARM+(4)TNUT3/8-10TPD5+(3)EC-1197+(1) SITELINK STL23000D5P0-SPCL-HCCA+STL2POLEKITD5P0+AB-27-4+TMP40000A

  POLE: MEDIUM DUTY POLE, 30' HIGH, EXTRUDED ALUMINUM SHAFT, ALUMINUM ALLOY POLE TOP AND BASE WITH NUT COVERS, HAND HOLE WITH STAINLESS STEEL TAMPER-RESISTANT SCREWS, GRAPHITE POWDER COAT (TIGER DRYLAC METALLIC #P5 49/80180-C), WITH ANCHOR BOLT SET.

  LAMP:(3) SYLVANIA 64189 LAMP MS400/PS/BU-ONLY/BT28
- FIXTURE: VERTICAL 100W METAL HALIDE LAMP, 277V, 42" HEIGHT (NOMINAL), CLEAR BOROSICLICATE GLASS LENS WITH BLACK IMPACT RESISTANT DIE-CAST ALUMINUM LOUVERS WITH WHITE UNDERSIDES. SYMMETRICAL CUT-OFF DISTRIBUTION, ROUND HEAVY-DUTY VANDAL RESISTANT PILLAR INCLUDING WELDED REINFORCED TOP AND BOTTOM PLATES, HAND HOLE WITH TAMPER RESISTANT COVER, DOMED TOP, HIGH POWER FACTOR BALLAST. GRAPHITE POWDER COAT FINISH (TIGER DRYLAC METALLIC #P5 49/80180-C). INTERNALLY ACCESSED INTEGRAL ACCESSED INTERNAL LEVELING PADS, INCLUDES SINGLE FUSING, LAMP AND ANCHOR BOLTS. FIXTURE SHALL BE PROPERLY GROUNDED, 277V.

MANUFACTURER: HOLOPHANE H10142100CM277SYMSFGH BOLLARD LAMP: (1) SYLVANIA MP100/C/U/MED 100W METAL HALIDE 2900K

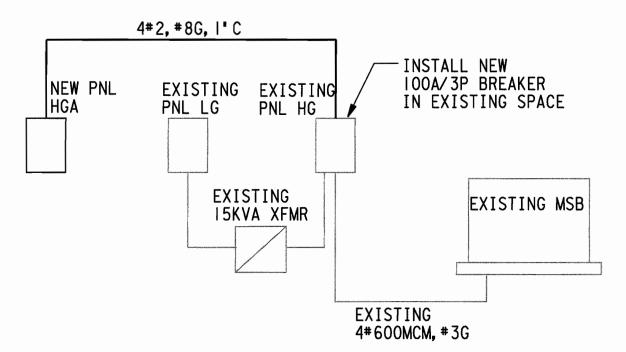


# PARTIAL ONEL LINE DIAGRAM NO SCALE

Parking Lot Load Analysis 277/480V		
	kVA	Amps
Existing One Year Peak Demand from CenterPoint Energy	52.0	62.6
+25%	13.0	15.6
New Lighting Load	15.1	18.1
+25%	3.8	4.5
Total		100.9
Existing Service		2000.0
Spare Capacity		1899.1



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			+

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1300 Holman Street Houston, TX 77004

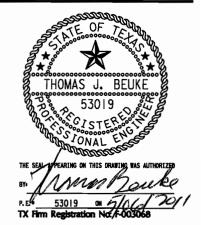Contract No.:		A/E Project No.: 2643,00
Drawn By:	ZHM	Date: 2011-05-06
Checked By:	TJB	Date: 2011-05-06
Approved By:	MHS	Date: 2011-05-06

Ownership of Instruments of Service:

All reports, plans, specifications, computer files, field data, notes & other documents and instruments prepared for Houston Community College as instruments of service shall become the property of Houston Community College. Houston Community College shall gain all common law, statutory and other reserved rights, including the copyright thereto.

# Electrical One Line and Schedules

Scale

CONTROLS CONTRATOR KRATOS SOUTHEAST LP (CONTACT ROBERT OLDROYD (832)-724-8168) CONTROLS CONTRACT SHALL PROVIDE ALL COMPONENTS, PROGRAM LIGHTING SCHEDULES AND UPDATE EXISTING GRAPHIC PACKAGE TO ADD NEW POINTS INDICATING RELAYS CONTROLLER LIGHTING LEVELS.


2. PLENUM RATED WIRING MAY BE USES FOR MLOW VOLTAGE WIRING ABOVE

ACCESSIBLE CEILINGS. PROVIDE CONDUIT WHERE EXPOSED.


- WHERE SHOWN ON THE PLANS
OFFSET LOW VOLTAGE POWER
AND COMMUNICATIONS CABLE AND EXTEND CABLING UP IN COMMUNICATIONS RACEWAY - WHERE SHOWN ON THE PLANS STUB UP COMMUNICATIONS CONDUIT FLUSH WITH BASE STUB CONDUIT UP, INTO LIGHTING POWER RACEWAY BEACON W/ REMOTE MOUNT BRACKET ON J-BOX W/ HOLOPHANE "TRACPOLE" MOUNTING HARDWARE COORDINATE HAND HOLE - POLE MOUNTED ACCESS DOOR TO A LOCATION INTERACTIVE VOICE OPPOSITE OR ADJACENT TO COMMUNICATION VOICE COMM UNIT CB-4-r UNIT CB-4-r OF CALL BUTTON LINE OF GRADE OR PAVEMENT -TYPE 'A' CONFIGURATION MOUNTING DETAIL

2 LIGHTING POLE SECTION NOT TO SCALE

# 4 LIGHTING CONTROL PANEL WIRING DIAGRAM

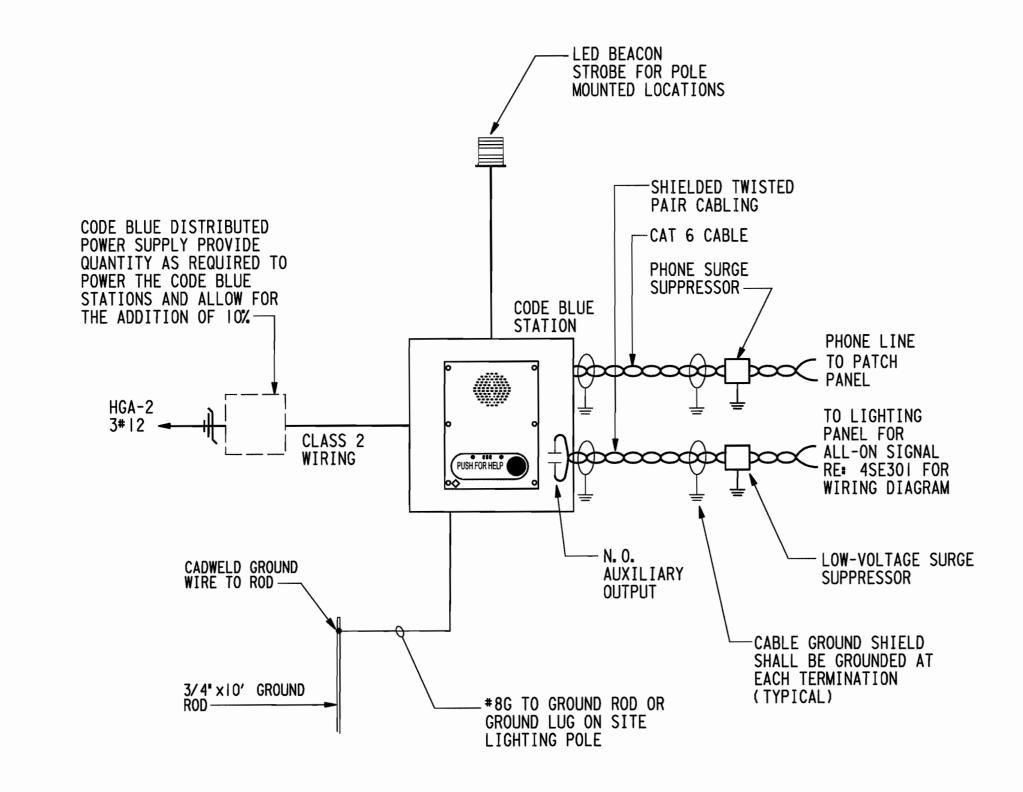

3 CODE BLUE STATION WIRING DIAGRAM NOT TO SCALE

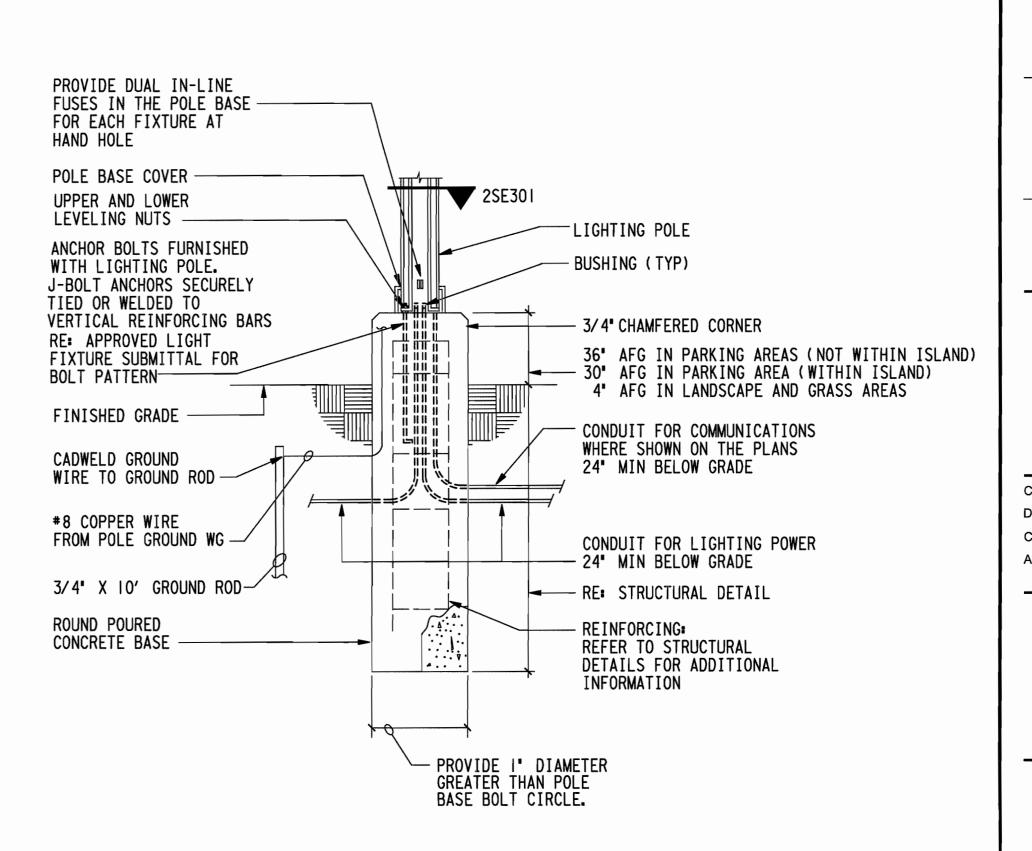


TYPICAL SITE LIGHTING POLE

BASE DETAIL

NOT TO SCALE

Houston Community College

HCC - Construction Department 3100 Main, 12th Floor Houston, Texas, 77002 Voice: 713.718.5168 reynaldo.pradia@hccs.edu

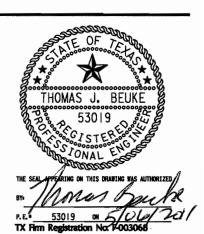

Issue/Revision:


REV DESCRIPTION DATE BY

1 ISSUED FOR BID & CONSTRUCTION 05/09/11 JA

Ilewelyn-davies sahni

architecture + planning + design

5120 Woodway, Suite 8010
Houston, TX 77056
p: 713.850.1500
f: 713.850.1023
e: info@theldnet.com

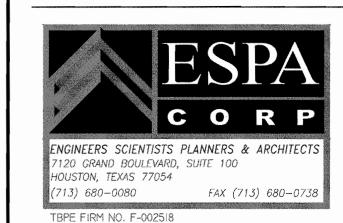

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21550 Provincial Blvd., Bldg. 4, #413 Katy, Texas 77450
281-759-1513 ph 281-759-1723 fx

STUDIO OF RICHARD JETER MFA LIGHTING DESIGNER 15908 PEBBLE BEND DR. HOUSTON, TEXAS 11068

E&C Engineers & Consultants Inc. 1010 Lamar, #650 Houston, Texas 77002 713.580.8880 713.580.8888 Fax

Central Campus
Parking Lot Improvements

1300 Holman Street Houston, TX 77004

 Contract No.:
 A/E Project No.: 2643.00

 Drawn By:
 MHS
 Date: 2011-05-06

 Checked By:
 TJB
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Ownership of Instruments of Service:


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ELECTRICAL DETAILS

Scale:


SE301

on 1260012643/misoutheast Parking Loti2643edtlidgn

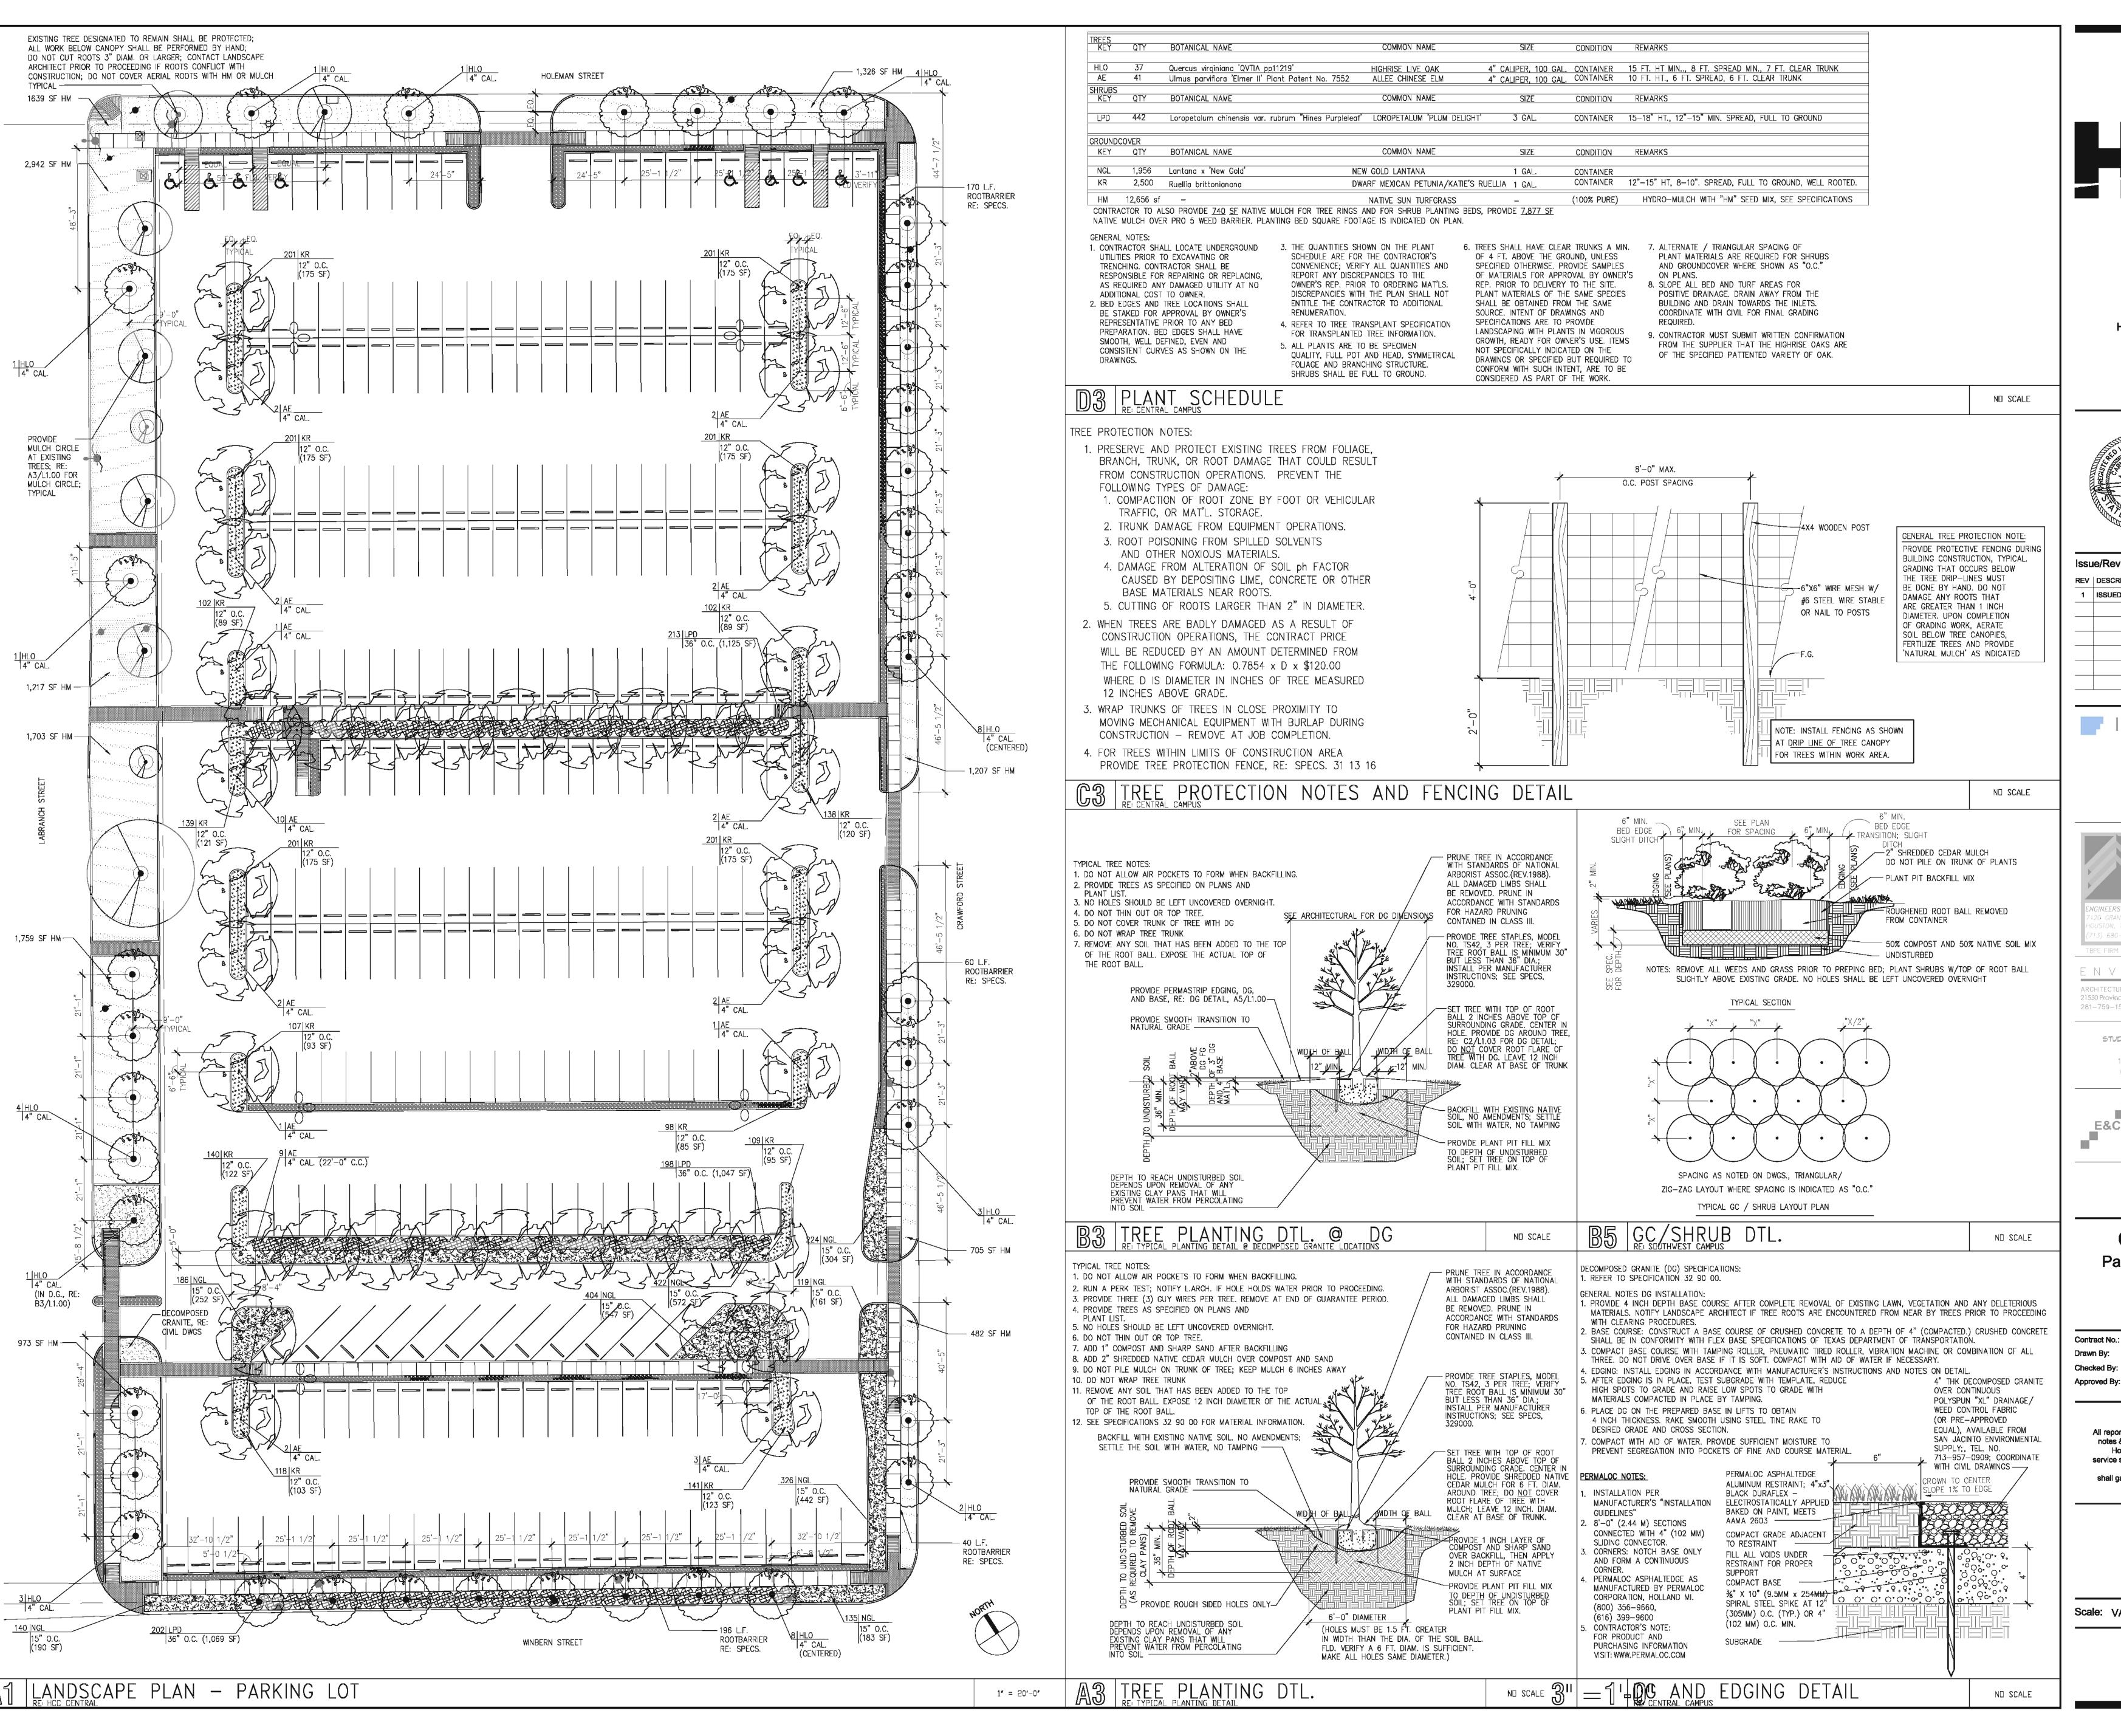

**HCC - Construction Department** 3100 Main, 12th Floor Houston, Texas, 77002 Voice: 713.718.5168 reynaldo.pradia@hccs.edu



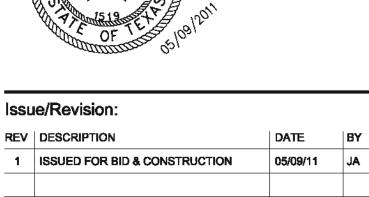

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architecture + planning + design 5120 Woodway, Suite 8010 Houston, TX 77056 p: 713.850.1500 f: 713.850.1023 e: info@theldnet.com



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1010 Lamar, #650 713.580.8800 713.580.8888 Fax

#### **Central Campus** Parking Lot Improvements

1300 Holman Street Houston, TX 77004


A/E Project No.: 724 Drawn By: CLP Date: 05/9/2011 Checked By: MSM Date: 05/9/2011 Date: 05/09/11 Approved By: CLP

Ownership of Instruments of Service: All reports, plans, specifications, computer files, field data, notes & other documents and instruments prepared for lousion Community College as instruments of service shall become the property of Houston Community College. Houston Community College shall gain all common law, statutory and other reserved rights, including the copyright thereto.

> Landscape Plan and **Details**

Scale: VARIES

L1.00

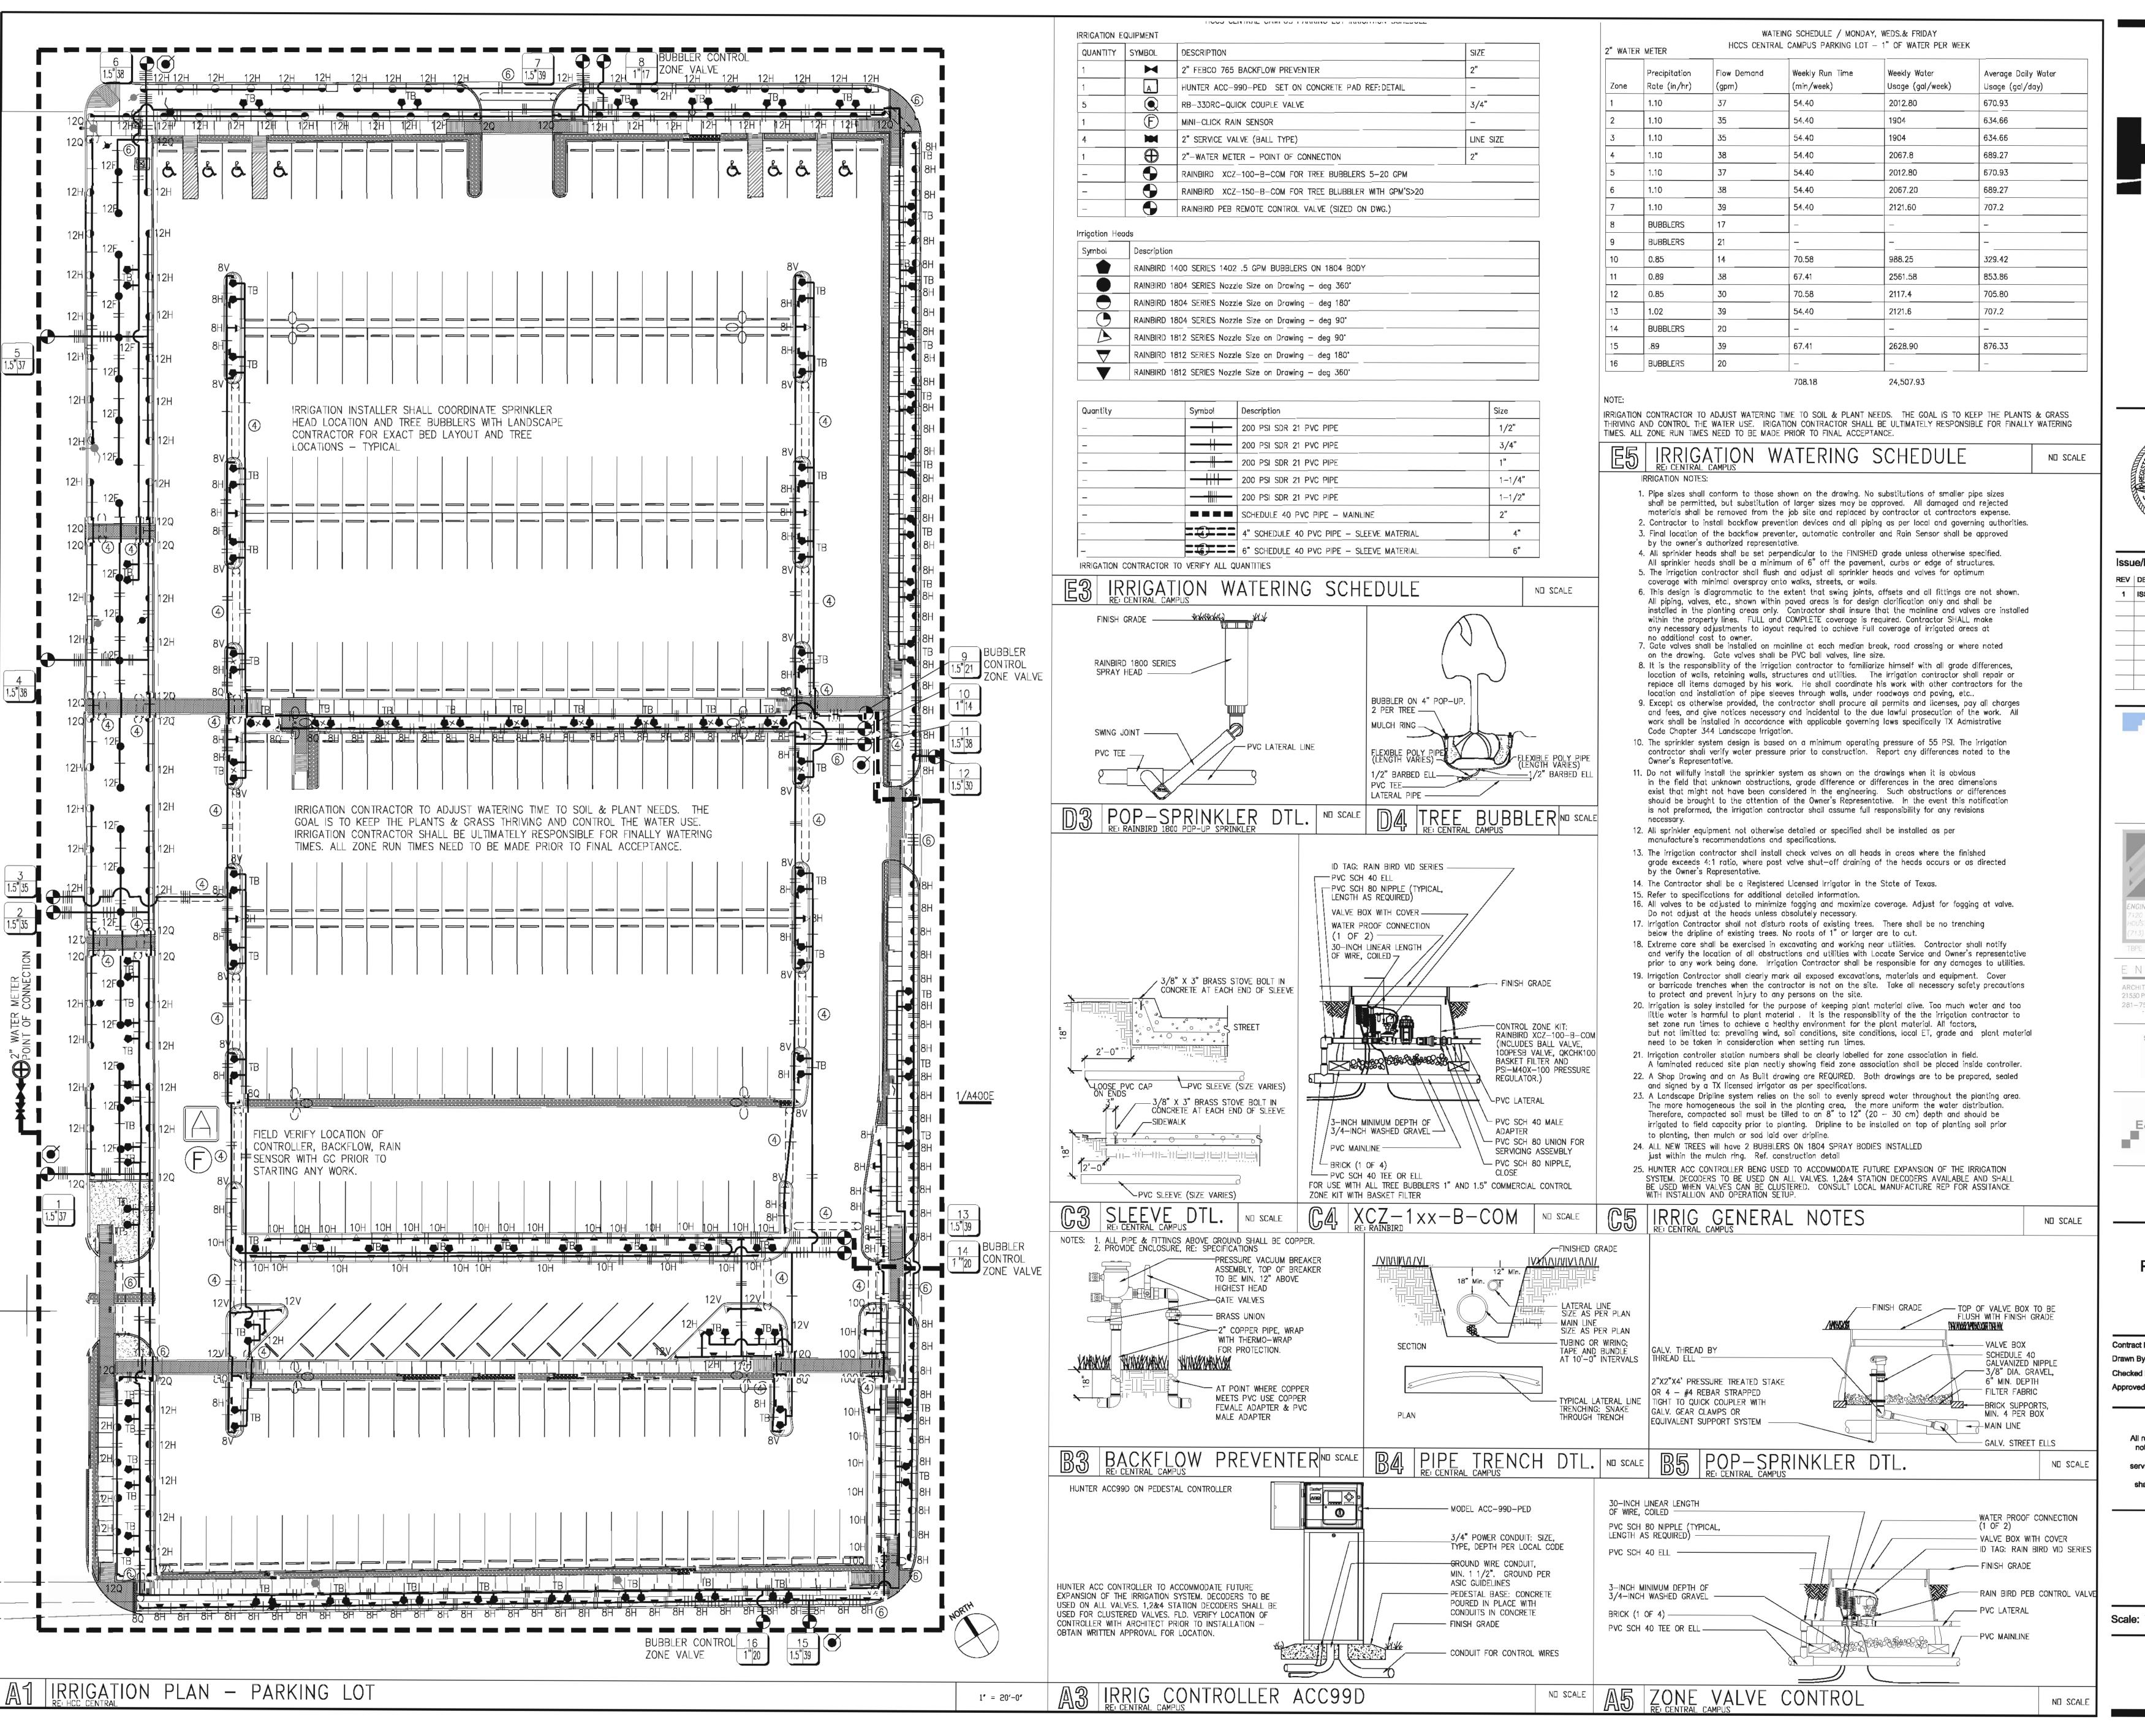



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### Issue/Revision: REV | DESCRIPTION ISSUED FOR BID & CONSTRUCTION

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Houston, Texas 77002 713.580.8800 713.580.8888 Fax

1010 Lamar, #650

#### **Central Campus Parking Lot Improvements**

1300 Holman Street Houston, TX 77004

Contract No.: A/E Project No.: 724 Drawn By: PJ Date: 05/9/2011 Checked By: CLP Date: 05/9/2011 Approved By: CLP

Ownership of Instruments of Service: All reports, plans, specifications, computer files, field data, Houston Community College as instruments of service shall become the property of Houston Community College. Houston Community College shall gain all common law, statutory and other reserved rights, including the copyright thereto.

> Irrigation Plan and **Details**

Scale: VARIES

L1.01